




CONTENTS OF SHEET

TOWER 6
FLOOR PLAN & AREA DIAGRAM, FLAT RERA CARPET

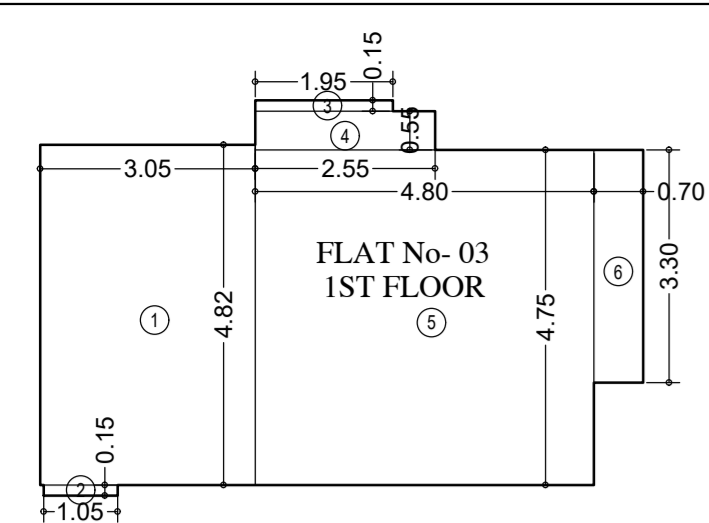

CARPET AREA CALCULATION (FOR PARKING PURPOSE) FOR 1ST FLOOR (TOWER-6)

FLAT-1	1	2	3	4	5	6	7	TOTAL RERA AREA
	3.05 X 4.82 X 1 No	=	14.70	Sq.mt				
	1.05 X 0.15 X 1 No	=	0.29	Sq.mt				
	2.40 X 4.85 X 1 No	=	11.64	Sq.mt				
	4.20 X 5.75 X 1 No	=	24.15	Sq.mt				
	5.30 X 4.75 X 1 No	=	14.55	Sq.mt				
	6.10 X 0.15 X 1 No	=	0.16	Sq.mt				
	7.15 X 0.05 X 1 No	=	0.06	Sq.mt				
	TOTAL RERA AREA	=	41.66	Sq.mt				

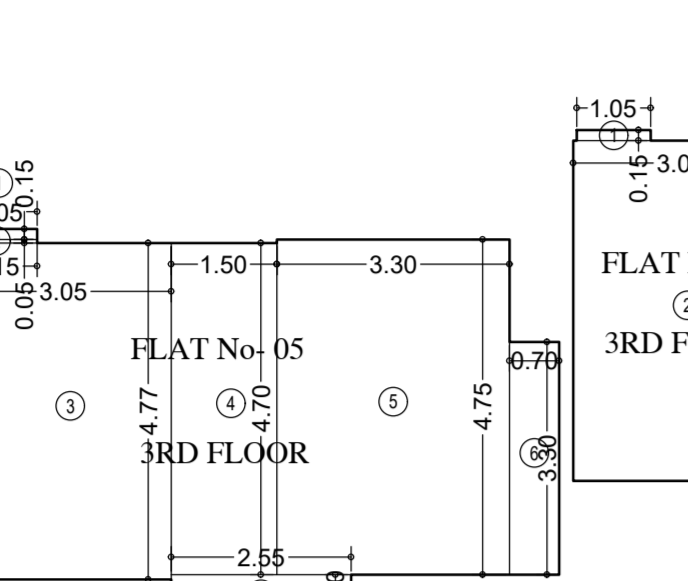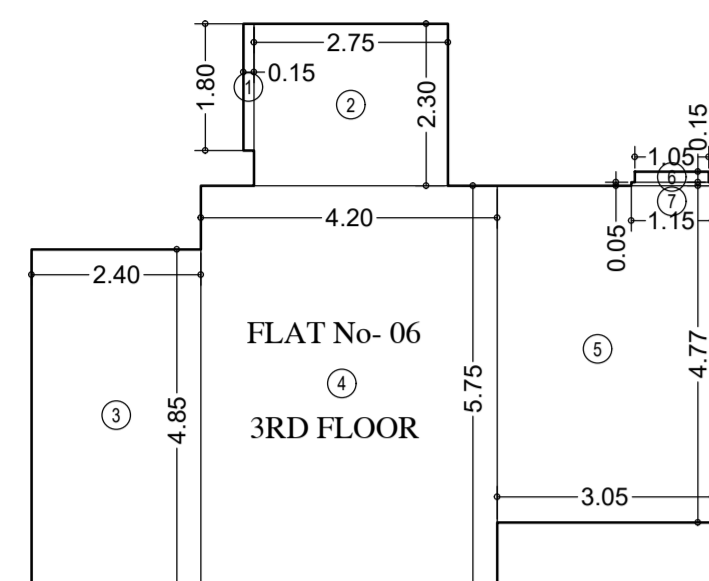

CARPET AREA CALCULATION (FOR PARKING PURPOSE) FOR 3RD FLOOR (TOWER-6)

FLAT-4	1	2	3	4	5	6	7	TOTAL RERA AREA
	0.15 X 1.80 X 1 No	=	0.27	Sq.mt				
	2.75 X 2.30 X 1 No	=	6.33	Sq.mt				
	3.30 X 4.77 X 1 No	=	14.55	Sq.mt				
	4.20 X 4.70 X 1 No	=	7.05	Sq.mt				
	5.30 X 4.75 X 1 No	=	15.68	Sq.mt				
	6.10 X 0.15 X 1 No	=	0.16	Sq.mt				
	7.15 X 0.05 X 1 No	=	0.06	Sq.mt				
	TOTAL RERA AREA	=	57.16	Sq.mt				

CARPET AREA CALCULATION (FOR PARKING PURPOSE) FOR 3RD FLOOR (TOWER-6)



FLAT-5	1	2	3	4	5	6	7	TOTAL RERA AREA
	1.05 X 0.15 X 1 No	=	0.16	Sq.mt				
	3.05 X 4.82 X 1 No	=	14.70	Sq.mt				
	4.80 X 4.15 X 1 No	=	19.92	Sq.mt				
	4.25 X 0.55 X 1 No	=	1.40	Sq.mt				
	5.15 X 0.15 X 1 No	=	0.29	Sq.mt				
	6.10 X 0.15 X 1 No	=	0.29	Sq.mt				
	7.15 X 0.05 X 1 No	=	0.06	Sq.mt				
	TOTAL RERA AREA	=	41.66	Sq.mt				

CARPET AREA CALCULATION (FOR PARKING PURPOSE) FOR 3RD FLOOR (TOWER-6)

FLAT-5	1	2	3	4	5	6	7	TOTAL RERA AREA
	1.05 X 0.15 X 1 No	=	0.16	Sq.mt				
	2.15 X 0.06 X 1 No	=	0.07	Sq.mt				
	3.30 X 4.77 X 1 No	=	14.55	Sq.mt				
	4.15 X 4.70 X 1 No	=	7.05	Sq.mt				
	5.30 X 4.75 X 1 No	=	15.68	Sq.mt				
	6.10 X 0.15 X 1 No	=	0.16	Sq.mt				
	7.15 X 0.05 X 1 No	=	0.06	Sq.mt				
	TOTAL RERA AREA	=	41.51	Sq.mt				



CARPET AREA CALCULATION (FOR PARKING PURPOSE) FOR 4TH TO 15TH FLOOR (TOWER-6)

FLAT-1	1	2	3	4	5	6	7	8	9	10	11	12	13	14	15	TOTAL RERA AREA	
	0.15 X 1.80 X 1 No	=	0.27	Sq.mt													
	2.15 X 2.30 X 1 No	=	6.33	Sq.mt													
	3.25 X 4.62 X 1 No	=	15.02	Sq.mt													
	4.15 X 0.05 X 1 No	=	0.06	Sq.mt													
	5.30 X 4.60 X 1 No	=	22.40	Sq.mt													
	6.10 X 0.15 X 1 No	=	0.16	Sq.mt													
	7.15 X 0.05 X 1 No	=	0.06	Sq.mt													
	TOTAL RERA AREA	=	55.52	Sq.mt													

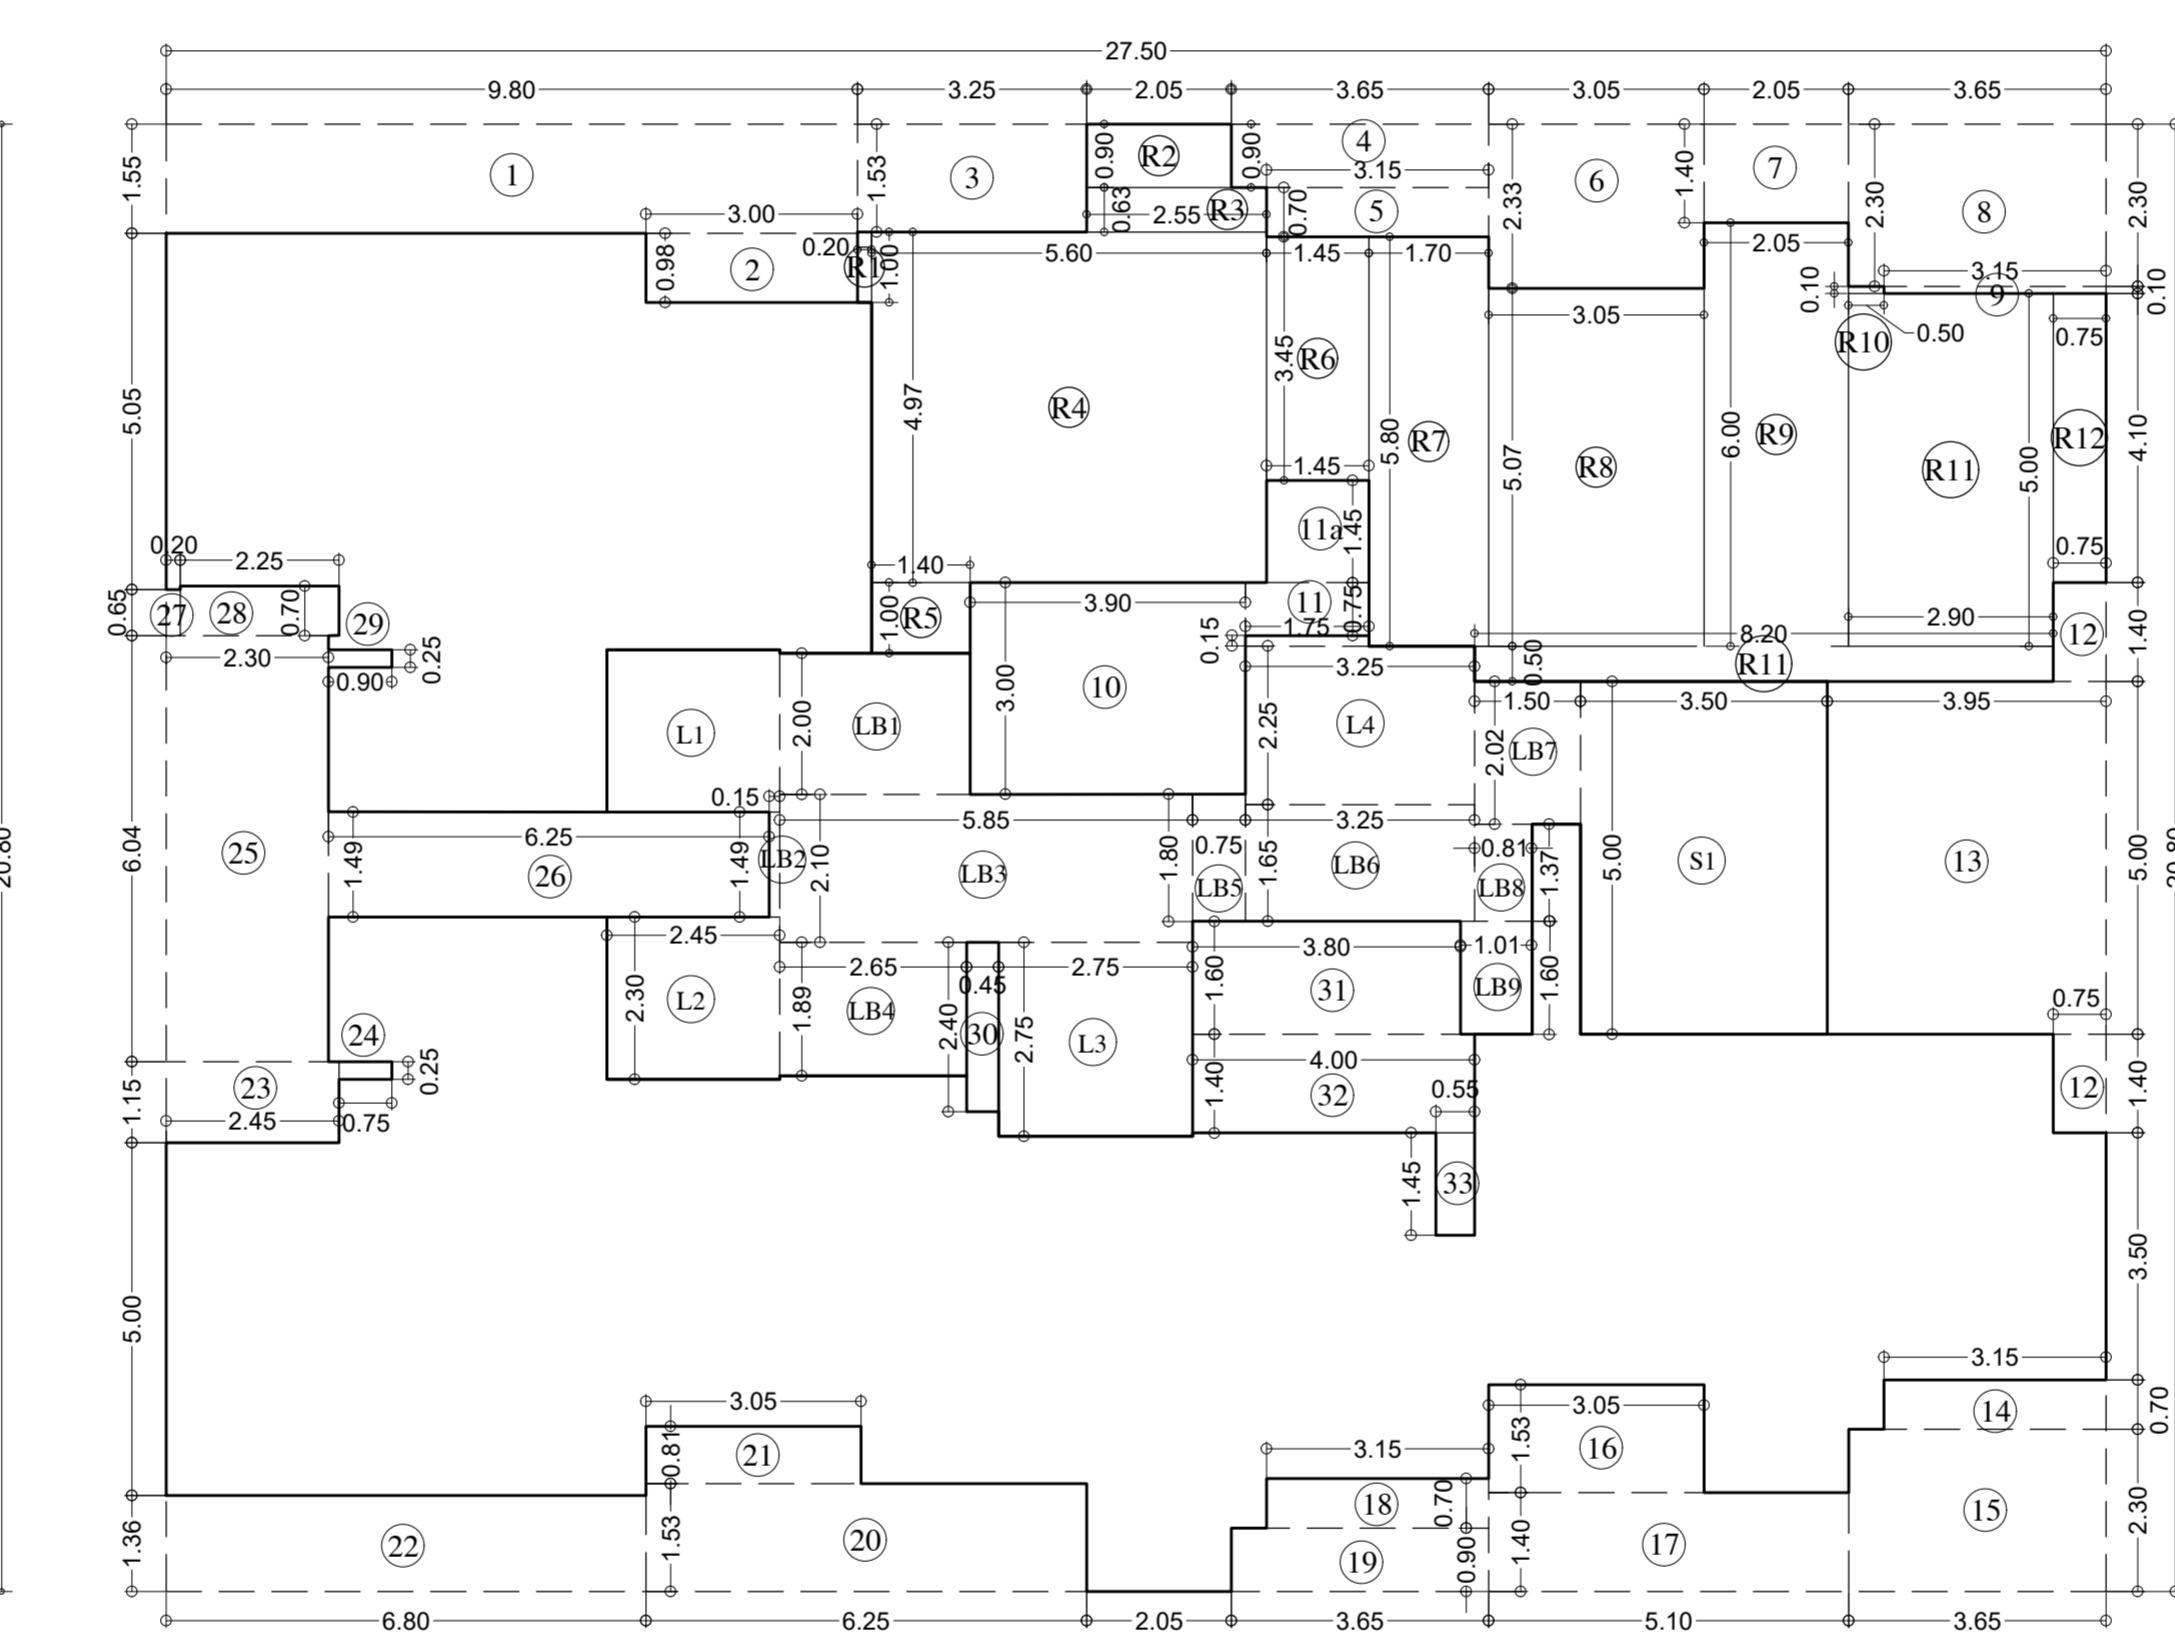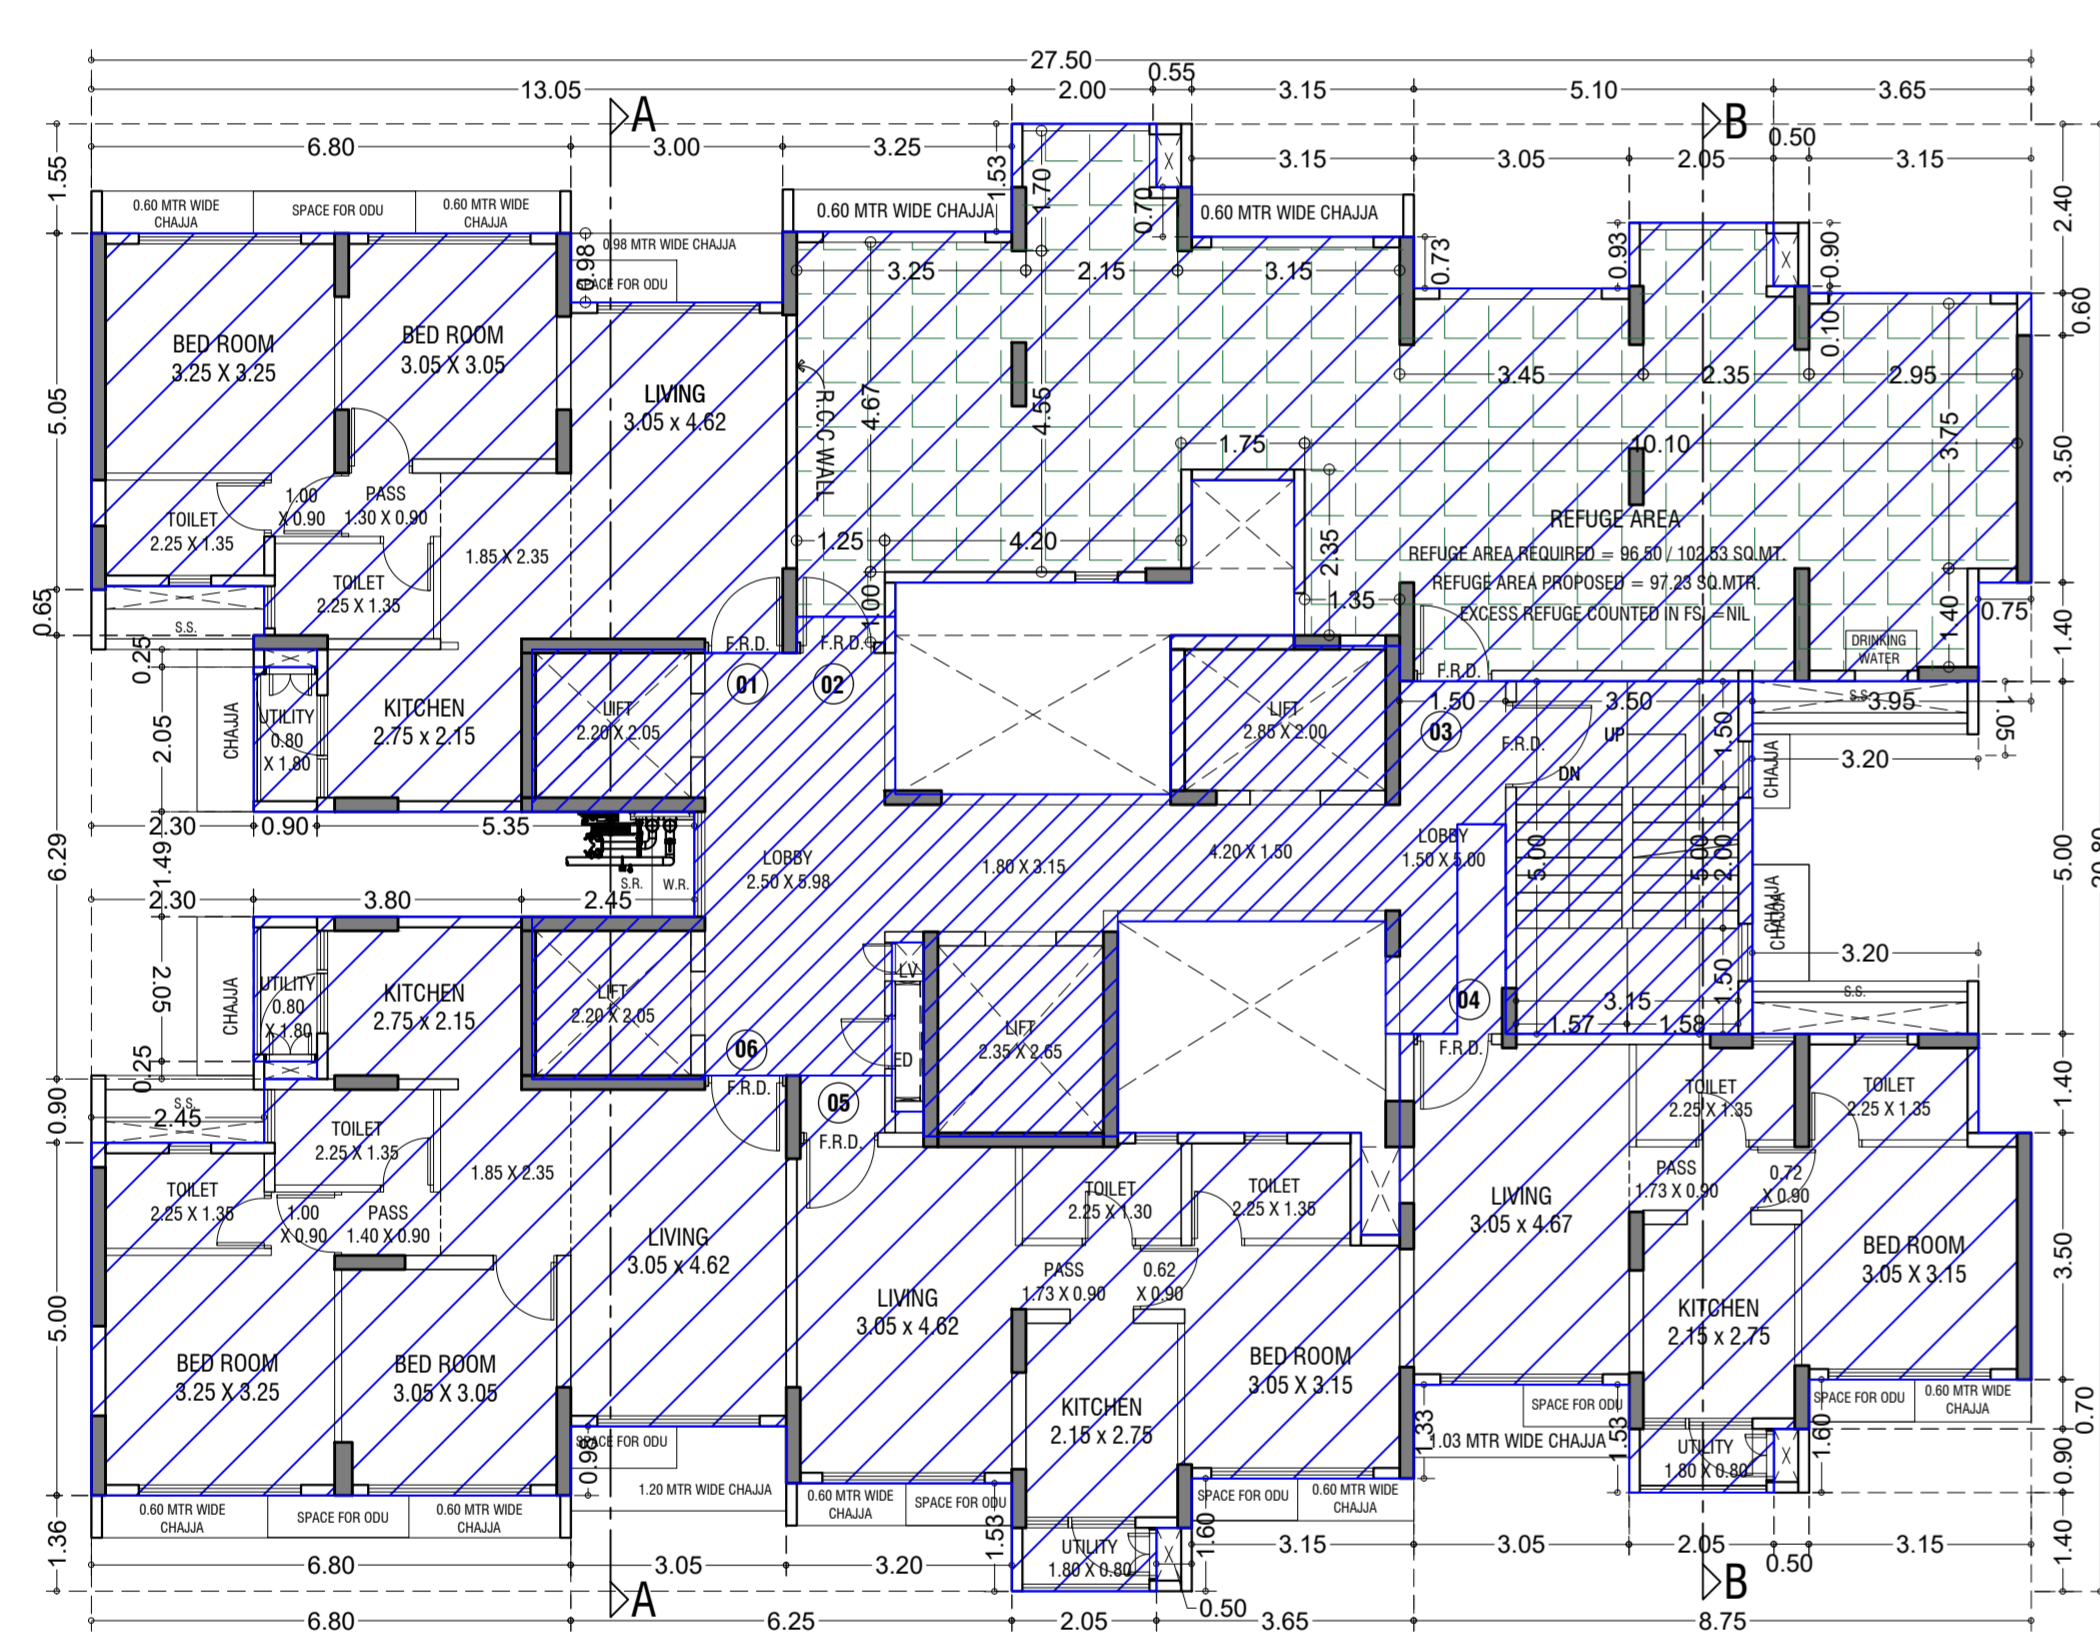

LINE AREA DIAGRAM FOR 8TH (REFUGE) FLOOR (TOWER-6)


ADDITION (X)		A	27.50	X	20.80	X	1.00	X	1	=	572.00	SQ.MT.
TOTAL												
STANDARD DEDUCTION (Y1)												
1	9.80	X	1.55	X	1.00	X	1	=	15.19	SQ.MT.		
2	3.00	X	0.98	X	1.00	X	1	=	2.94			
3	3.25	X	1.53	X	1.00	X	1	=	4.97			
4	3.65	X	0.90	X	1.00	X	1	=	3.29			
5	3.15	X	0.70	X	1.00	X	1	=	2.21			
6	3.05	X	2.33	X	1.00	X	1	=	7.11			
7	2.05	X	1.40	X	1.00	X	1	=	2.87			
8	3.65	X	2.30	X	1.00	X	1	=	8.40			
9	3.15	X	0.10	X	1.00	X	1	=	0.32			
10	3.90	X	3.00	X	1.00	X	1	=	11.70			
11	1.75	X	0.75	X	1.00	X	1	=	1.31			
11a	1.45	X	1.45	X	1.00	X	1	=	2.10			
12	0.75	X	1.40	X	1.00	X	2	=	2.10			
13	3.95	X	5.00	X	1.00	X	1	=	19.75			
14	3.15	X	0.70	X	1.00	X	1	=	2.21			
15	3.65	X	2.30	X	1.00	X	1	=	8.40			
16	3.05	X	1.53	X	1.00	X	1	=	4.67			
17	5.10	X	1.40	X	1.00	X	1	=	7.14			
18	3.15	X	0.70	X	1.00	X	1	=	2.21			
19	3.65	X	0.90	X	1.00	X	1	=	3.29			
20	6.25	X	1.53	X	1.00	X	1	=	9.56			
21	3.05	X	0.81	X	1.00	X	1	=	2.47			
22	6.80	X	1.36	X	1.00	X	1	=	9.25			
23	2.45	X	1.15	X	1.00	X	1	=	2.82			
24	2.75	X	0.30	X	1.00	X	1	=	0.23			
25	2.30	X	6.04	X	1.00	X	1	=	13.89			
26	6.25	X	1.49	X	1.00	X	1	=	9.31			
27	0.20	X	0.65	X	1.00	X	1	=	0.13			
28	2.25	X	0.70	X	1.00	X	1	=	1.58			
29	0.90	X	0.25	X	1.00	X	1	=	0.23			
30	0.45	X	2.40	X	1.00	X	1	=	1.08			
31	3.80	X	1.60	X	1.00	X	1	=	6.08			
32	4.00	X	1.40	X	1.00	X	1	=	5.60			
33	0.55	X	1.45	X	1.00	X	1	=	0.80			
TOTAL												
STAIRCASE, LIFT, LOBBY & PASSAGE DEDUCTION (Y2)												
S1	3.50	X	5.00	X	1.00	X	1	=	17.50	SQ.MT.		
S1	2.45	X	2.30	X	1.00	X	1	=	5.64			
L2	2.45	X	2.30	X	1.00	X	1	=	5.64			
L3	2.75	X	2.75	X	1.00	X	1	=	7.56			
L4	3.25	X	2.25	X	1.00	X	1	=	7.31			
L5	1.75	X	0.15	X	1.00	X	1	=	0.26			
L6	2.70	X	2.00	X	1.00	X	1	=	5.40			
LB1	0.15	X	1.49	X	1.00	X	1	=	0.22			
LB2	0.15	X	1.49	X	1.00	X	1	=	0.22			
LB3	5.85	X	2.10	X	1.00	X	1	=	12.29			
LB4	2.65	X	1.89	X	1.00	X	1	=	5.01			
LB5	0.75	X	1.80	X	1.00	X	1	=	1.35			
LB6	3.25	X	1.65	X	1.00	X	1	=	5.36			
LB7	1.50	X	2.02	X	1.00	X	1	=	3.03			
LB8	0.81	X	1.37	X	1.00	X	1	=	1.11			
LB9	1.01	X	1.60	X	1.00	X	1	=	1.62			
TOTAL												
REFUGE AREA DEDUCTION (Y3)												
R1	0.20	X	1.00	X	1.00	X	1	=	0.20	SQ.MT.		
R2	2.05	X	0.90	X	1.00	X	1	=	1.85			
R3	2.55	X	0.63	X	1.00	X	1	=	1.61			
R4	5.60	X	4.97	X	1.00	X	1	=	27.83			
R5	1.40	X	1.00	X	1.00	X	1	=	1.40			
R6	1.45	X	3.45	X	1.00	X	1	=	5.00			
R7	1.70	X	5.80	X	1.00	X	1	=	9.86			
R8	3.05	X	5.07	X	1.00	X	1	=	15.46			
R9	2.05	X	6.00	X	1.00	X	1	=	12.30			
R10	0.50	X	0.10	X	1.00	X	1	=	0.05			
R11	2.90	X	5.00	X	1.00	X	1	=	14.50			
R12	0.75	X	4.10	X	1.00	X	1	=	3.08			
R13	6.20	X	0.50	X	1.00	X	1	=	3.10			
TOTAL												
REFUGE AREA DEDUCTION (Y4) (Y1+Y2+Y3)												
TOTAL DEDUCTION (Y4) (Y1+Y2+Y3)												
TOTAL BUILT UP AREA (Y5) (X-Y4)												
EXCESS REFUGE AREA (Y6)												
TOTAL BUILT UP AREA (Y5 + Y6)												

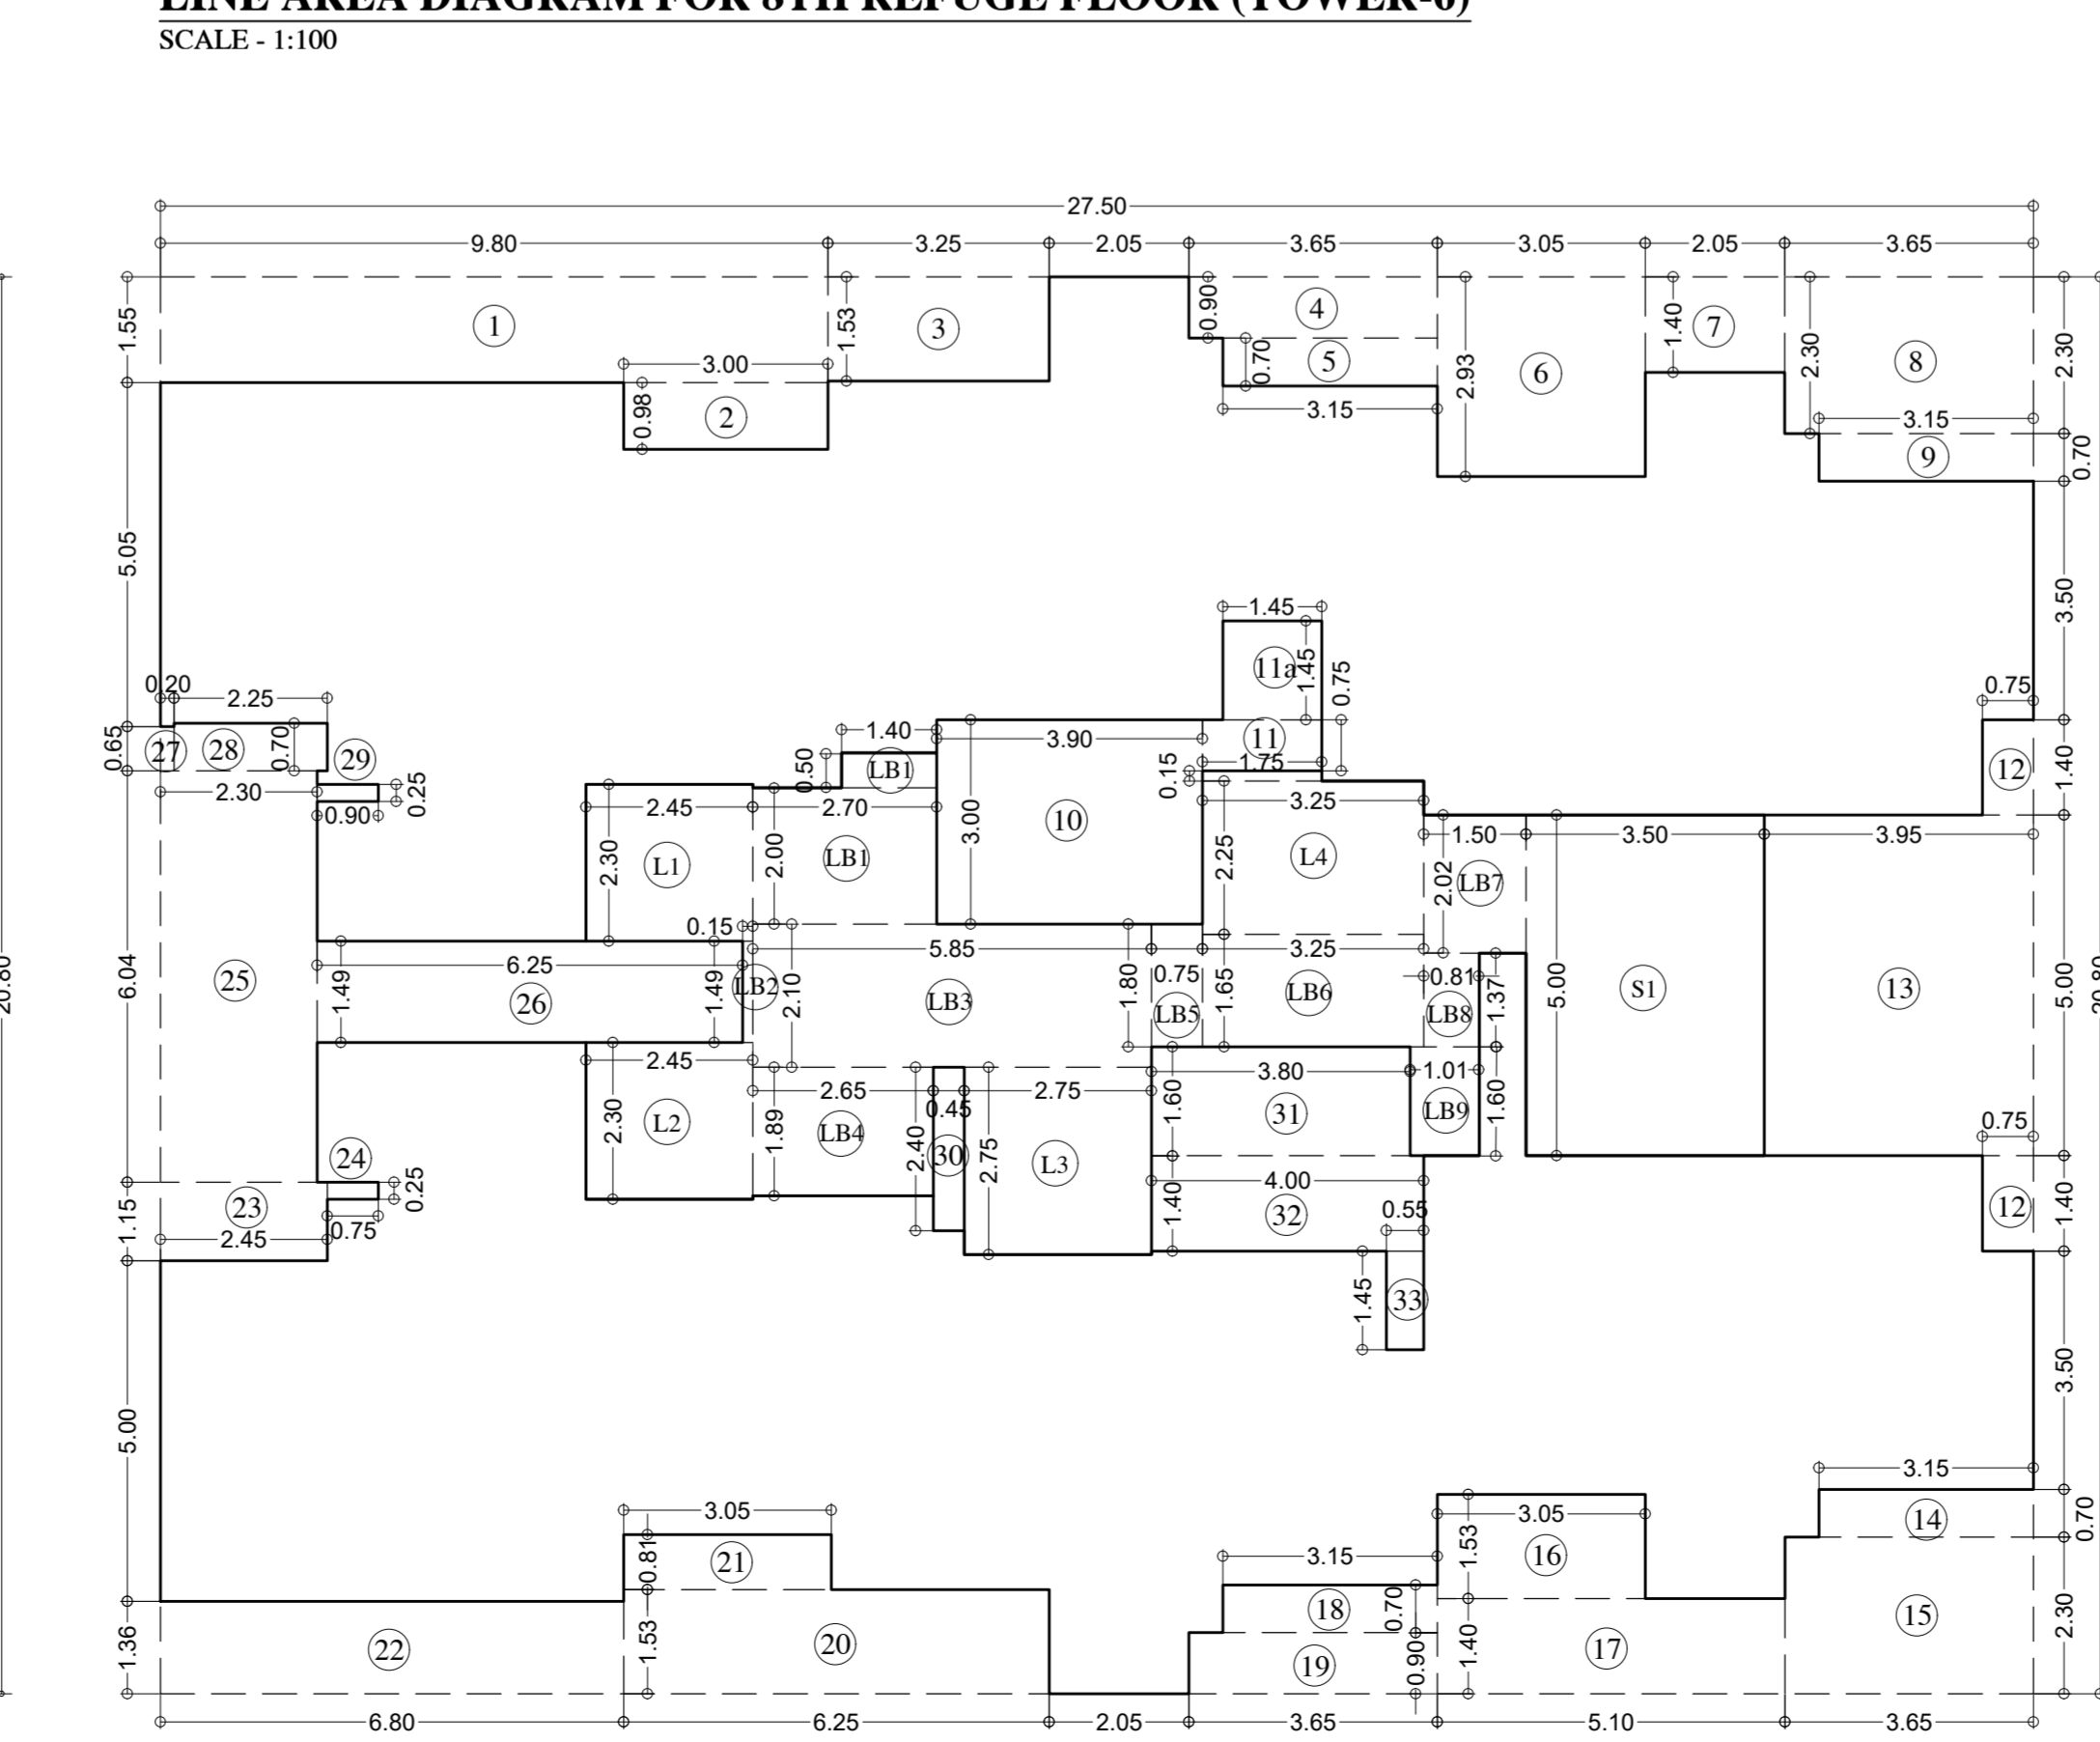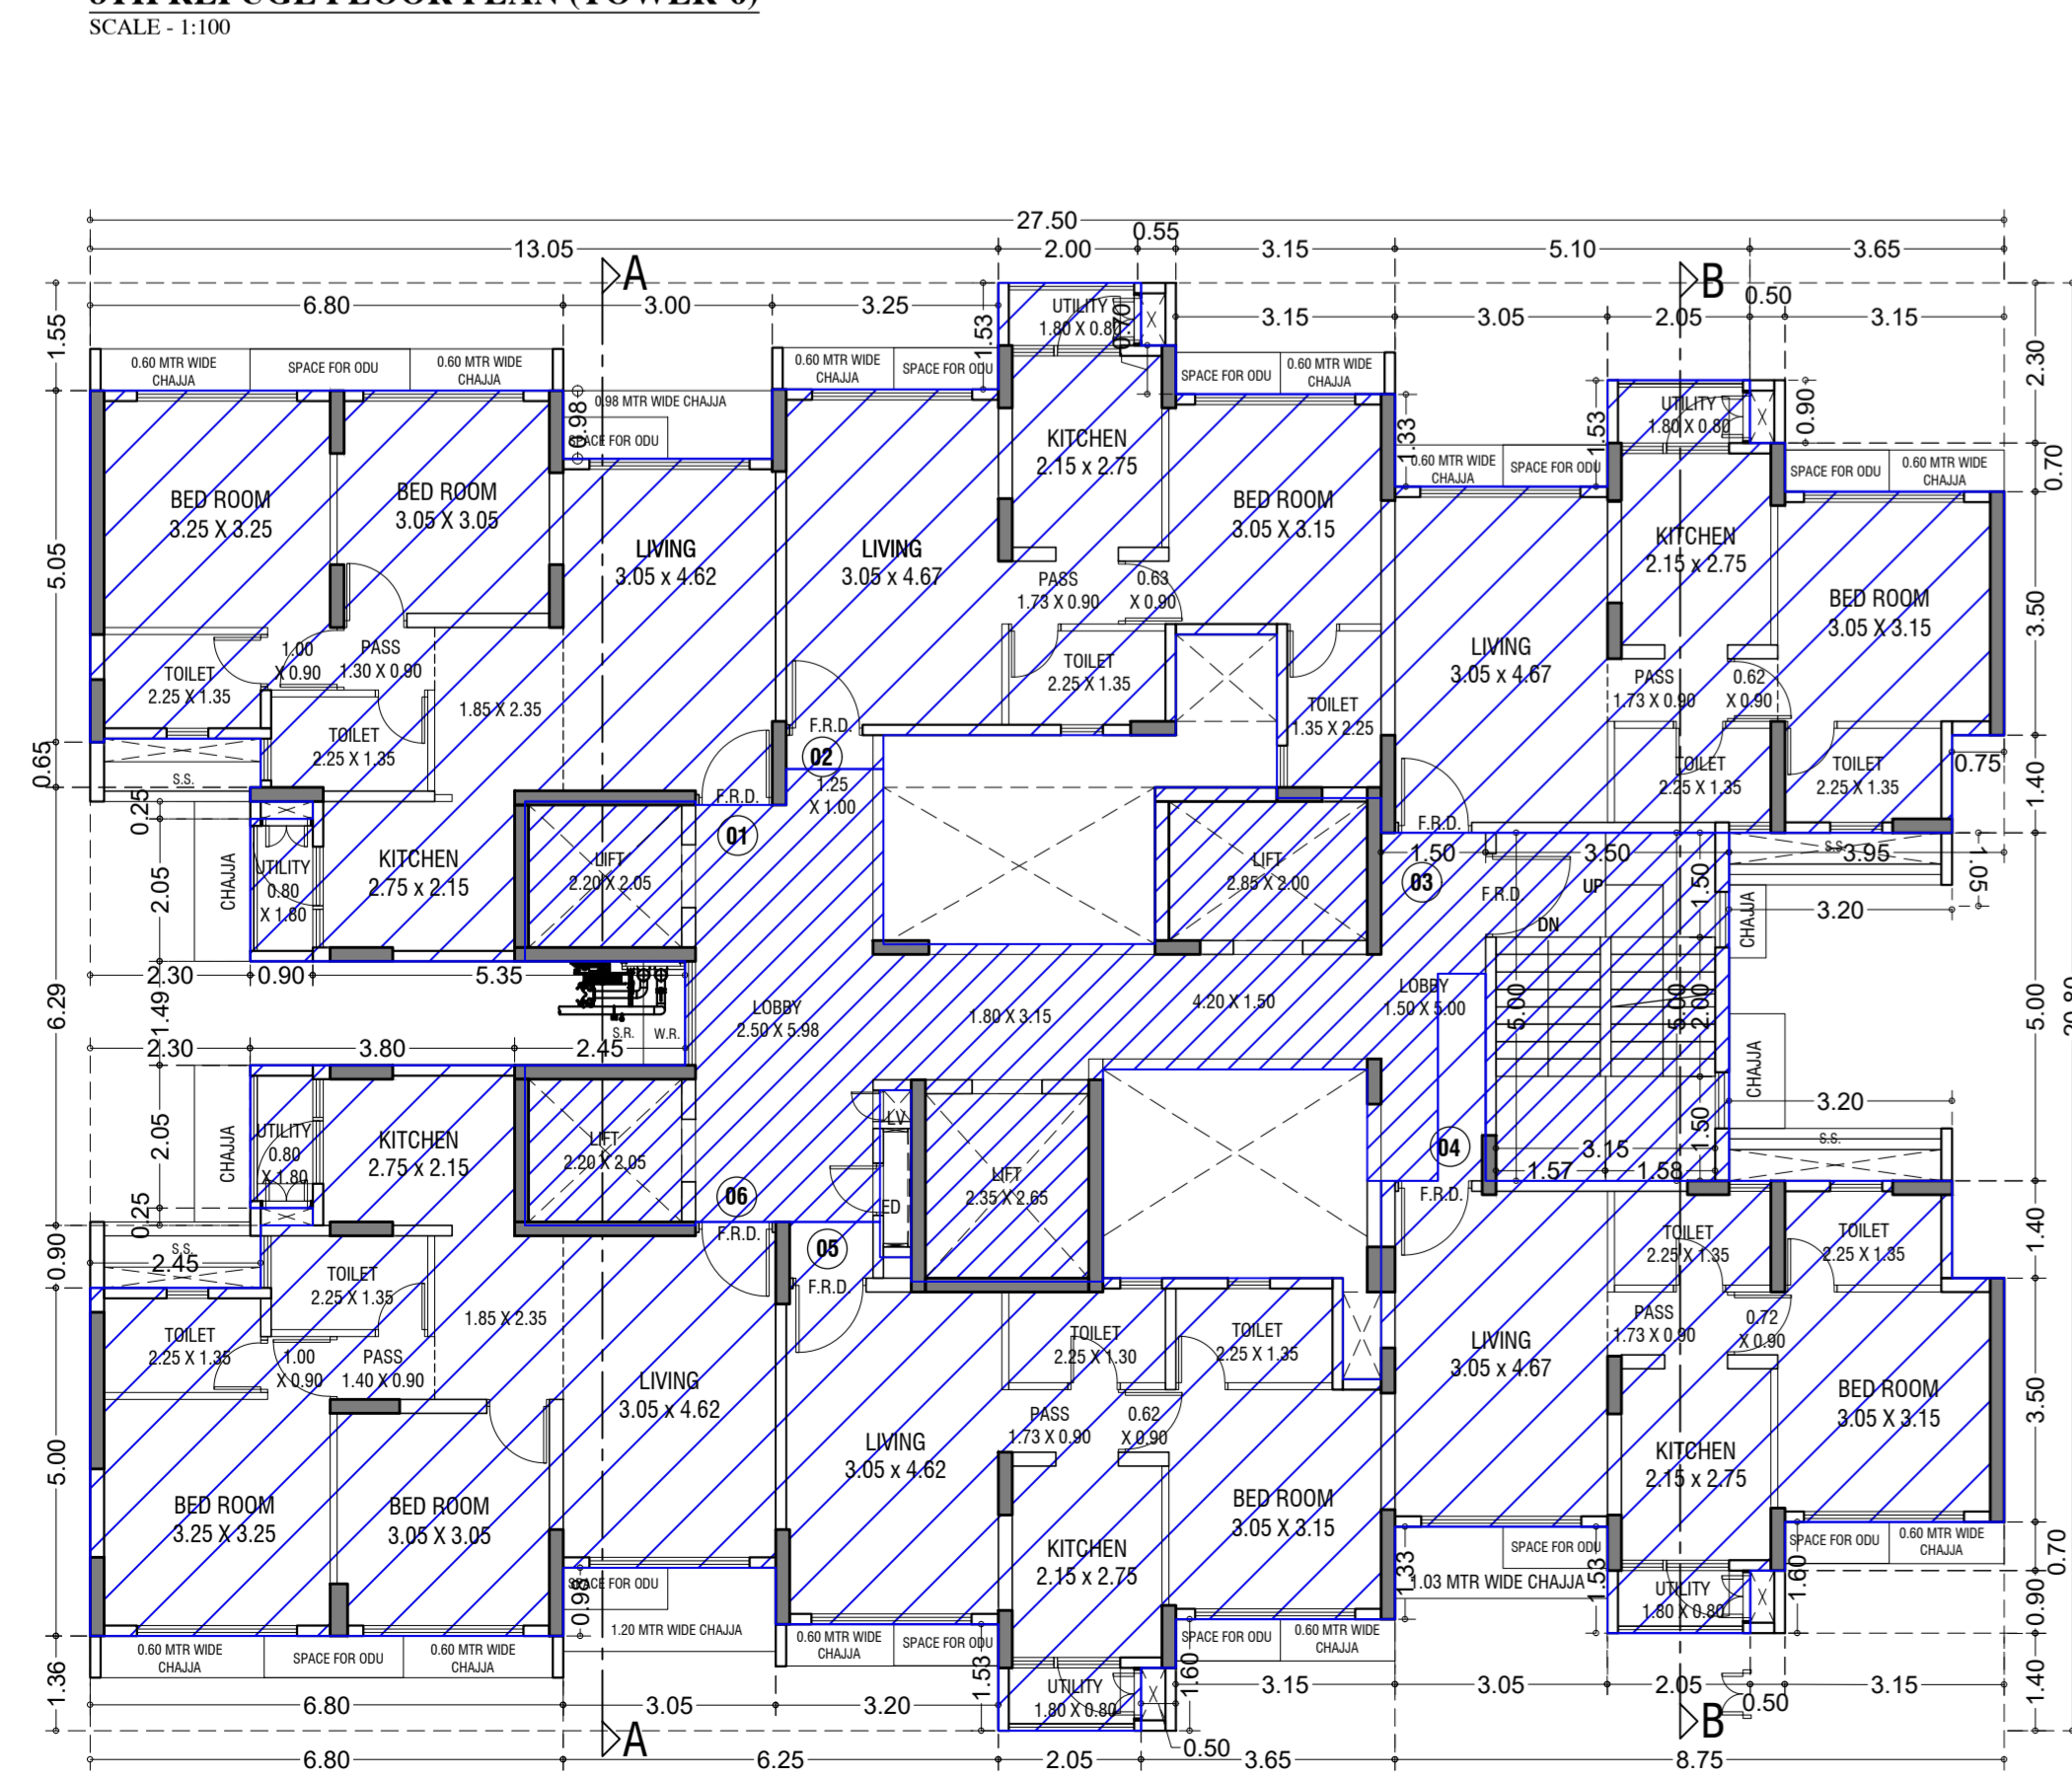

LINE AREA DIAGRAM FOR 4TH TO 7TH & 9TH TO 15TH TYPICAL FLOOR (TOWER-6)

ADDITION (X)		A	27.50	X	20.80	X	1.00	X	1	=	572.00	SQ.MT.
TOTAL												
STAIRCASE, LIFT, LOBBY & PASSAGE DEDUCTION (Y2)												
S1	3.50	X	5.00	X	1.00	X	1	=	17.50	SQ.MT.		
S1	2.45	X	2.30	X	1.00	X	1	=	5.64			
L2	2.45	X	2.30	X	1.00	X	1	=	5.64			
L3	2.75	X	2.75	X	1.00	X	1	=	7.56			
L4	3.25	X	2.25	X	1.00	X	1	=	7.31			
L5	1.75	X	0.15	X	1.00	X	1	=	0.26			
L6	2.70	X	2.00	X	1.00	X	1					

CONTENTS OF SHEET
TOWER 7
FLOOR PLAN & AREA DIAGRAM, FLAT RERA CARPET

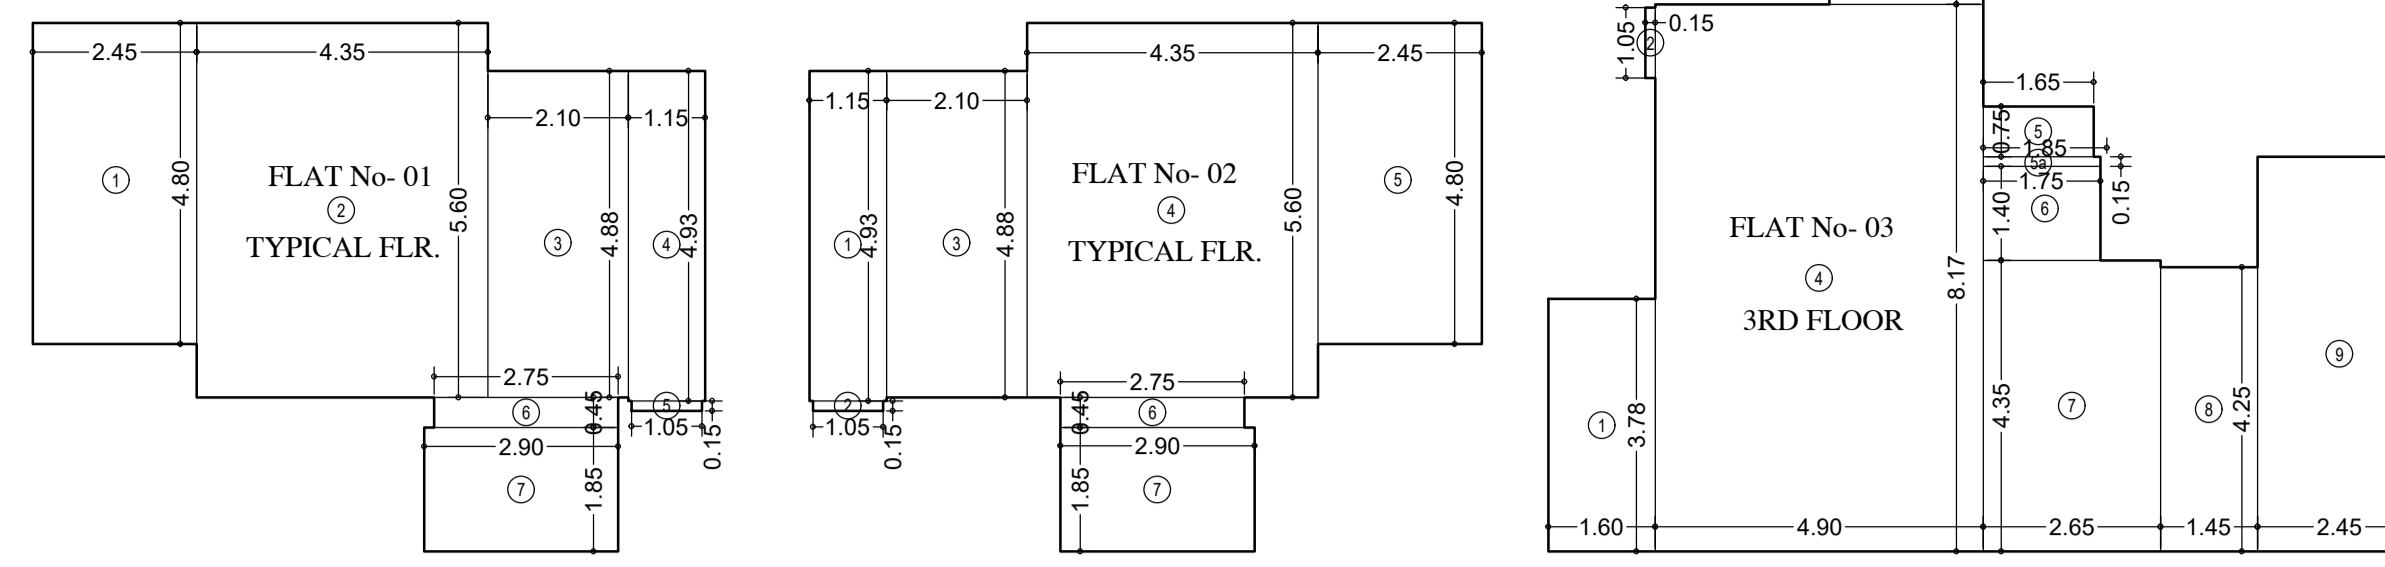

CARPET AREA CALCULATION (FOR PARKING PURPOSE) FOR 1ST TO 7TH, 9TH TO 15TH FLR. (TOWER-7)


FLAT-1	1	2.45 X 4.80 X 1 No	=	11.70 Sq.Mt
	2	4.35 X 5.90 X 1 No	=	24.36 Sq.Mt
	3	2.10 X 4.88 X 1 No	=	10.25 Sq.Mt
	4	1.15 X 4.93 X 1 No	=	5.67 Sq.Mt
	5	1.05 X 0.15 X 1 No	=	0.16 Sq.Mt
	6	2.75 X 0.45 X 1 No	=	1.24 Sq.Mt
	7	2.80 X 1.85 X 1 No	=	5.17 Sq.Mt
	TOTAL RERA AREA		=	58.81 Sq.Mt

CARPET AREA CALCULATION (FOR PARKING PURPOSE) FOR 1ST TO 7TH, 9TH TO 15TH FLR. (TOWER-7)

FLAT-2	1	1.15 X 4.80 X 1 No	=	5.67 Sq.Mt
	2	1.05 X 0.15 X 1 No	=	0.16 Sq.Mt
	3	2.10 X 4.88 X 1 No	=	10.25 Sq.Mt
	4	4.35 X 4.93 X 1 No	=	24.36 Sq.Mt
	5	2.45 X 4.80 X 1 No	=	11.70 Sq.Mt
	6	2.75 X 0.45 X 1 No	=	1.24 Sq.Mt
	7	2.80 X 1.85 X 1 No	=	5.17 Sq.Mt
	TOTAL RERA AREA		=	58.81 Sq.Mt


CARPET AREA CALCULATION (FOR PARKING PURPOSE) FOR 3RD FLOORS (TOWER-7)

FLAT-3	1	1.60 X 3.78 X 1 No	=	6.05 Sq.Mt
	2	0.15 X 1.05 X 1 No	=	0.16 Sq.Mt
	3	2.30 X 2.10 X 1 No	=	4.83 Sq.Mt
	4	4.90 X 8.17 X 1 No	=	40.03 Sq.Mt
	5	1.65 X 0.75 X 1 No	=	1.24 Sq.Mt
	5a	1.85 X 0.15 X 1 No	=	0.28 Sq.Mt
	6	1.75 X 1.40 X 1 No	=	2.45 Sq.Mt
	7	2.65 X 4.35 X 1 No	=	11.51 Sq.Mt
	8	1.45 X 4.25 X 1 No	=	6.16 Sq.Mt
	9	2.45 X 5.90 X 1 No	=	14.46 Sq.Mt
	TOTAL RERA AREA		=	87.19 Sq.Mt

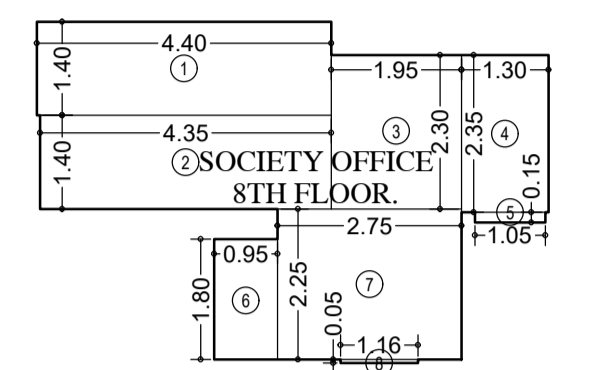

CARPET AREA CALCULATION (FOR PARKING PURPOSE) FOR 5TH FLOORS (TOWER-7)

FLAT-1	1	4.40 X 1.40 X 1 No	=	6.16 Sq.Mt
	2	4.35 X 1.40 X 1 No <td>= <td>6.09 Sq.Mt</td> </td>	= <td>6.09 Sq.Mt</td>	6.09 Sq.Mt
	3	1.95 X 2.30 X 1 No <td>= <td>4.49 Sq.Mt</td> </td>	= <td>4.49 Sq.Mt</td>	4.49 Sq.Mt
	4	1.30 X 2.35 X 1 No <td>= <td>3.06 Sq.Mt</td> </td>	= <td>3.06 Sq.Mt</td>	3.06 Sq.Mt
	5	1.05 X 0.15 X 1 No <td>= <td>0.16 Sq.Mt</td> </td>	= <td>0.16 Sq.Mt</td>	0.16 Sq.Mt
	6	0.95 X 1.90 X 1 No <td>= <td>1.71 Sq.Mt</td> </td>	= <td>1.71 Sq.Mt</td>	1.71 Sq.Mt
	7	2.75 X 2.25 X 1 No <td>= <td>6.19 Sq.Mt</td> </td>	= <td>6.19 Sq.Mt</td>	6.19 Sq.Mt
	8	1.16 X 0.05 X 1 No <td>= <td>0.06 Sq.Mt</td> </td>	= <td>0.06 Sq.Mt</td>	0.06 Sq.Mt
	TOTAL RERA AREA		= <td>27.92 Sq.Mt</td>	27.92 Sq.Mt

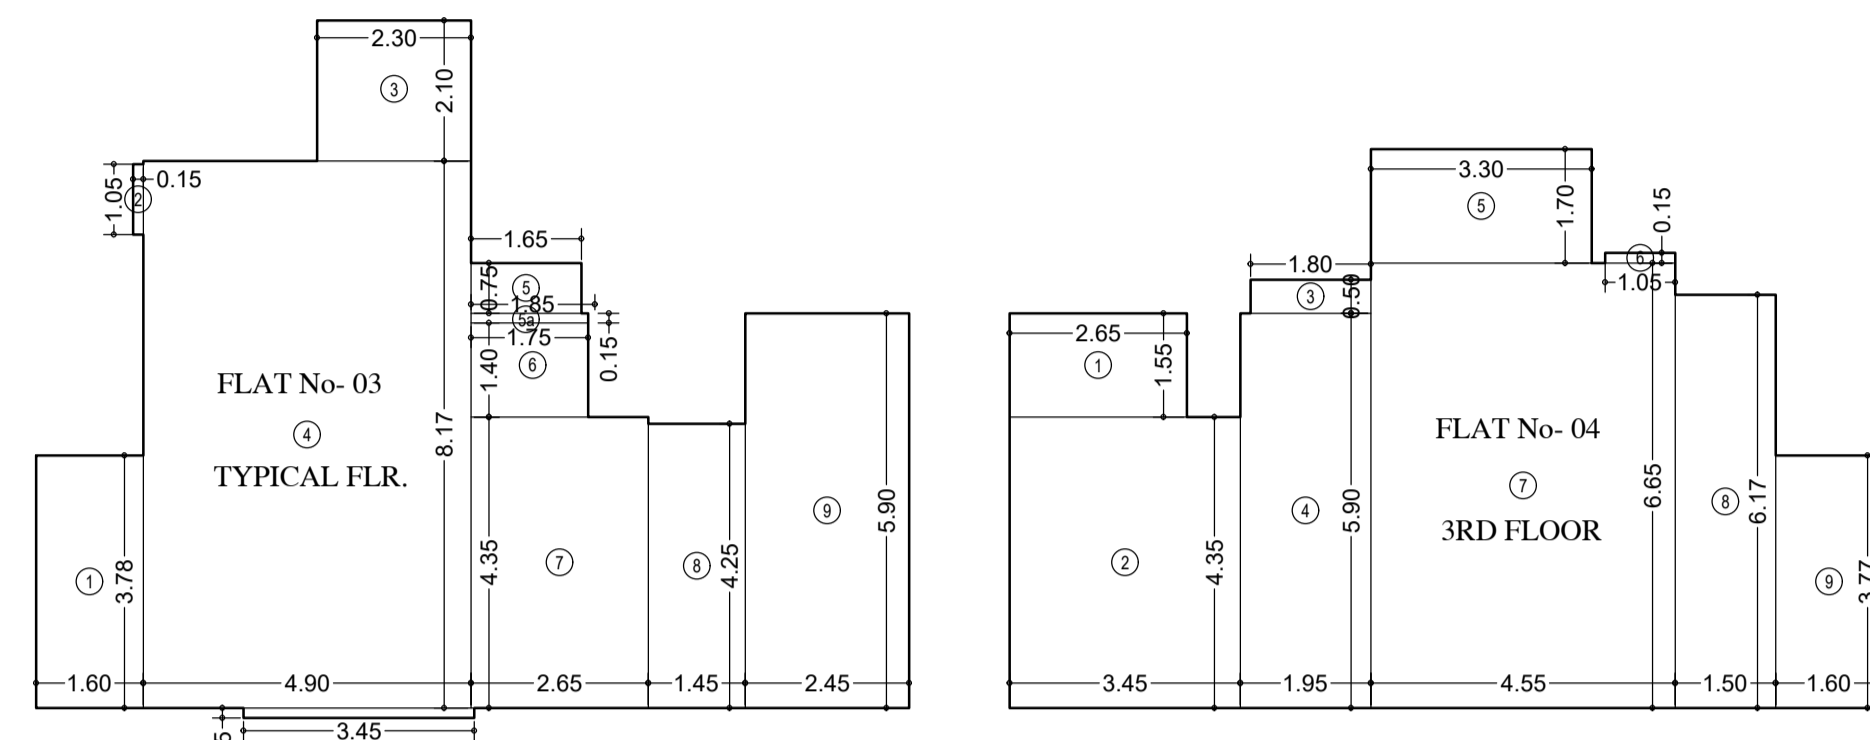

CARPET AREA CALCULATION (FOR PARKING PURPOSE) FOR 4TH TO 15TH FLOORS (TOWER-7)


FLAT-3	1	1.60 X 3.78 X 1 No	=	6.05 Sq.Mt
	2	0.15 X 1.05 X 1 No <td>=</td> <td>0.16 Sq.Mt</td>	=	0.16 Sq.Mt
	3	2.30 X 2.10 X 1 No <td>=</td> <td>4.83 Sq.Mt</td>	=	4.83 Sq.Mt
	4	4.90 X 8.17 X 1 No <td>=</td> <td>40.03 Sq.Mt</td>	=	40.03 Sq.Mt
	5	1.65 X 0.75 X 1 No <td>=</td> <td>1.24 Sq.Mt</td>	=	1.24 Sq.Mt
	5a	1.85 X 0.15 X 1 No <td>=</td> <td>0.28 Sq.Mt</td>	=	0.28 Sq.Mt
	6	1.75 X 1.40 X 1 No <td>=</td> <td>2.45 Sq.Mt</td>	=	2.45 Sq.Mt
	7	2.65 X 4.35 X 1 No <td>=</td> <td>11.51 Sq.Mt</td>	=	11.51 Sq.Mt
	8	1.45 X 4.25 X 1 No <td>=</td> <td>6.16 Sq.Mt</td>	=	6.16 Sq.Mt
	9	2.45 X 5.90 X 1 No <td>=</td> <td>14.46 Sq.Mt</td>	=	14.46 Sq.Mt
	TOTAL RERA AREA		=	87.71 Sq.Mt

CARPET AREA CALCULATION (FOR PARKING PURPOSE) FOR 3RD FLOORS (TOWER-7)

FLAT-4	1	2.65 X 1.55 X 1 No	=	4.11 Sq.Mt
	2	3.45 X 4.35 X 1 No <td>=</td> <td>15.01 Sq.Mt</td>	=	15.01 Sq.Mt
	3	1.80 X 0.50 X 1 No <td>=</td> <td>0.90 Sq.Mt</td>	=	0.90 Sq.Mt
	4	1.95 X 5.90 X 1 No <td>=</td> <td>11.51 Sq.Mt</td>	=	11.51 Sq.Mt
	5	3.30 X 1.70 X 1 No <td>=</td> <td>5.61 Sq.Mt</td>	=	5.61 Sq.Mt
	6	1.05 X 0.15 X 1 No <td>=</td> <td>0.16 Sq.Mt</td>	=	0.16 Sq.Mt
	7	4.55 X 6.65 X 1 No <td>=</td> <td>30.29 Sq.Mt</td>	=	30.29 Sq.Mt
	8	1.50 X 6.17 X 1 No <td>=</td> <td>9.25 Sq.Mt</td>	=	9.25 Sq.Mt
	9	1.60 X 3.77 X 1 No <td>=</td> <td>6.03 Sq.Mt</td>	=	6.03 Sq.Mt
	TOTAL RERA AREA		=	82.84 Sq.Mt

CARPET AREA CALCULATION (FOR PARKING PURPOSE) FOR 4TH TO 15TH FLOORS (TOWER-7)

FLAT-4	1	2.65 X 1.55 X 1 No	=	4.11 Sq.Mt
	2	3.45 X 4.35 X 1 No <td>=</td> <td>15.01 Sq.Mt</td>	=	15.01 Sq.Mt
	3	1.80 X 0.50 X 1 No <td>=</td> <td>0.90 Sq.Mt</td>	=	0.90 Sq.Mt
	4	1.95 X 5.90 X 1 No <td>=</td> <td>11.51 Sq.Mt</td>	=	11.51 Sq.Mt
	5	3.30 X 1.70 X 1 No <td>=</td> <td>5.61 Sq.Mt</td>	=	5.61 Sq.Mt
	6	1.05 X 0.15 X 1 No <td>=</td> <td>0.16 Sq.Mt</td>	=	0.16 Sq.Mt
	7	4.55 X 6.65 X 1 No <td>=</td> <td>30.29 Sq.Mt</td>	=	30.29 Sq.Mt
	8	1.50 X 6.17 X 1 No <td>=</td> <td>9.25 Sq.Mt</td>	=	9.25 Sq.Mt
	9	1.60 X 3.77 X 1 No <td>=</td> <td>6.03 Sq.Mt</td>	=	6.03 Sq.Mt
	TOTAL RERA AREA		=	83.30 Sq.Mt

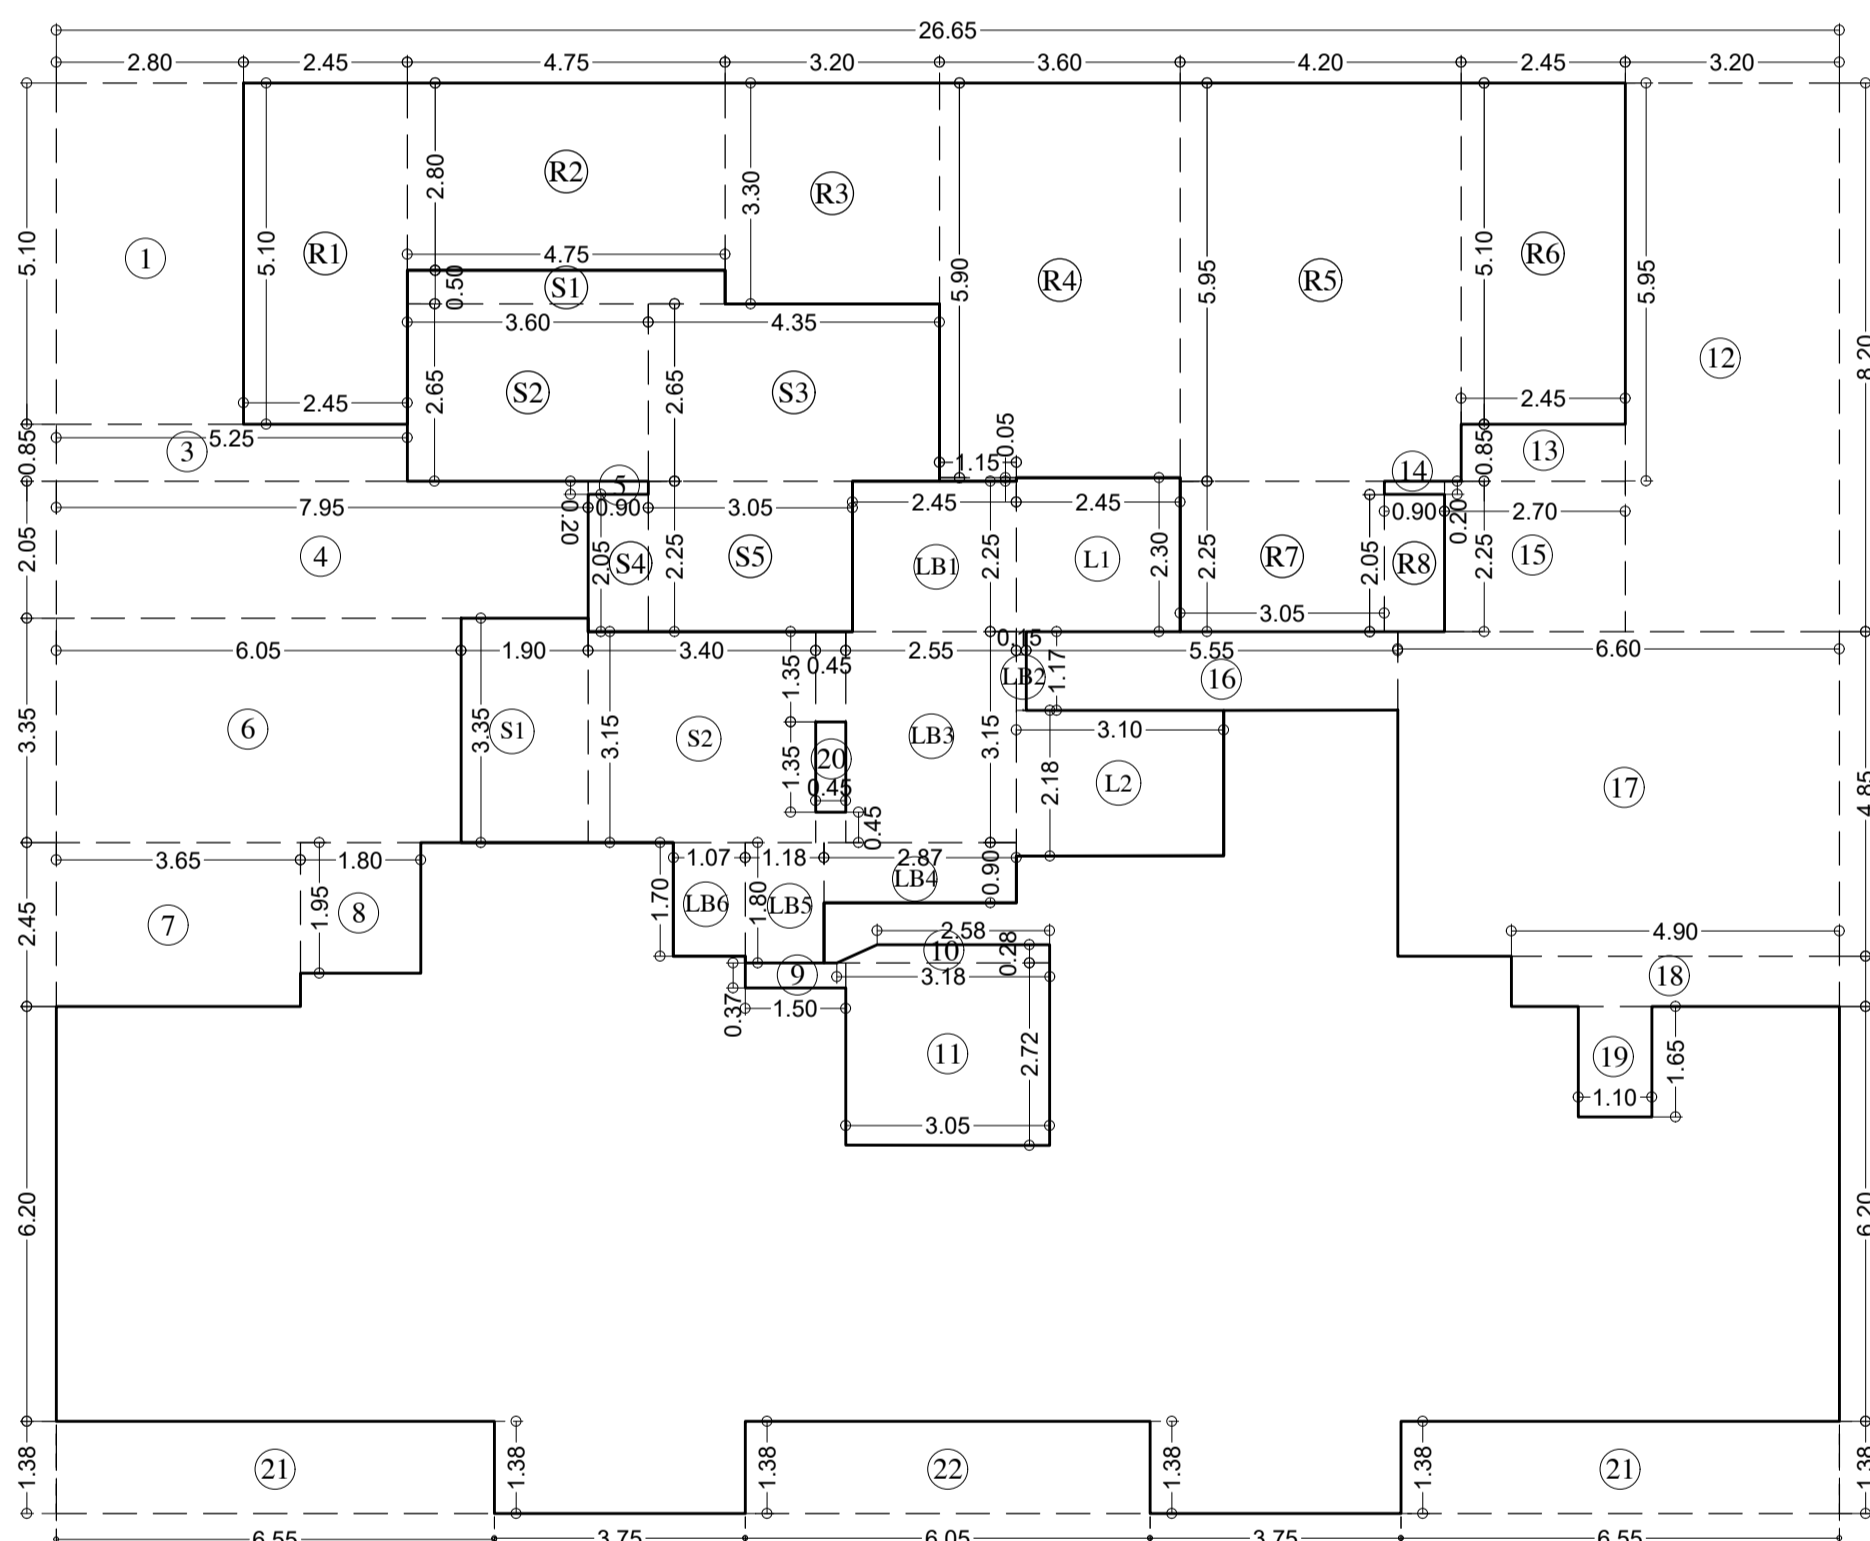

LINE AREA DIAGRAM FOR 8TH REFUGE FLOOR (TOWER-7)
SCALE - 1:100


LINE AREA DIAGRAM FOR 8TH REFUGE FLOOR (TOWER-7)

ADDITION (X)	A	26.65 X 21.38	X	100 X 1	=	569.78 SQ.MT.
TOTAL					=	569.78 SQ.MT.
STANDARD DEDUCTION (Y1)	1	2.80 X 5.10 X 100 X 1	=	14.28 SQ.MT.		
	2	0.90 X 0.90 X 100 X 1	=	0.90		
	3	5.25 X 0.85 X 100 X 1	=	5.46		
	4	7.95 X 2.05 X 100 X 1	=	16.30		
	5	0.90 X 0.20 X 100 X 1	=	0.18		
	6	6.05 X 3.35 X 100 X 1	=	20.27		
	7	3.65 X 2.45 X 100 X 1	=	8.94		
	8	1.80 X 1.95 X 100 X 1	=	3.51		
	9	1.50 X 0.37 X 100 X 1	=	0.56		
	10	0.28 X (2.58 + 3.18) X 200 X 1	=	0.81		
	11	3.05 X 2.72 X 100 X 1	=	8.30		
	12	3.20 X 8.20 X 100 X 1	=	26.24		
	13	2.45 X 0.85 X 100 X 1	=	2.08		
	14	0.90 X 0.20 X 100 X 1	=	0.18		
	15	2.70 X 2.25 X 100 X 1	=	6.08		
	16	5.55 X 1.17 X 100 X 1	=	6.49		
	17	6.60 X 4.85 X 100 X 1	=	32.01		
	18	4.90 X 0.75 X 100 X 1	=	3.68		
	19	1.10 X 1.65 X 100 X 1	=	1.82		
	20	0.45 X 1.35 X 100 X 1	=	0.61		
	21	4.55 X 1.38 X 100 X 2	=	12.60		
	22	6.05 X 1.38 X 100 X 1	=	8.35		
	TOTAL		=	183.20 SQ.MT.		
STAIRCASE, LIFT, LOBBY & PASSAGE DEDUCTION (Y2)	S1	1.90 X 3.35 X 100 X 1	=	6.37 SQ.MT.		
	S2	1.40 X 3.15 X 100 X 1	=	10.71		
	L1	2.45 X 2.30 X 100 X 1	=	5.64		
	L2	3.10 X 2.18 X 100 X 1	=	6.76		
	LB1	2.45 X 1.25 X 100 X 1	=	5.51		
	LB2	1.15 X 1.17 X 100 X 1	=	0.88		
	LB3	2.55 X 3.15 X 100 X 1	=	8.03		
		0.45 X 1.35 X 100 X 1	=	0.61		
	LB4	2.87 X 0.90 X 100 X 1	=	2.58		
	LB5	1.18 X 1.80 X 100 X 1	=	2.12		
	LB6	1.07 X 1.70 X 100 X 1	=	1.82		
	TOTAL		=	50.52 SQ.MT.		
SOCIETY OFFICE AREA DEDUCTIONS (Y3)	S1	4.75 X 0.50 X 100 X 1	=	2.38 SQ.MT.		
	S2	3.60 X 2.65 X 100 X 1	=	9.54		
	S3	4.35 X 2.65 X 100 X 1	=	11.53		
	S4	0.90 X 2.05 X 100 X 1	=	1.85		
	S5	3.05 X 2.25 X 100 X 1	=	6.86		
	TOTAL		=	32.15 SQ.MT.		
REFUGE AREA DEDUCTIONS (Y4)	R1	2.45 X 5.10 X 100 X 1	=	12.50 SQ.MT.		
	R2	4.75 X 2.80 X 100 X 1	=	13.30		
	R3	3.20 X 3.30 X 100 X 1	=	10.56		
	R4	3.60 X 5.90 X 100 X 1	=	21.24		
		1.15 X 0.05 X 100 X 1	=	0.06		
	R5	4.20 X 5.95 X 100 X 1	=	24.99		
	R6	2.15 X 5.10 X 100 X 1	=	12.50		
	R7	3.05 X 2.25 X 100 X 1	=	6.86		
	R8	0.90 X 2.05 X 100 X 1	=	1.85		
	TOTAL		=	103.85 SQ.MT.		
TOTAL DEDUCTION (Y5) (Y1+Y2+Y3+Y4)			=	269.72 SQ.MT.		
TOTAL BUILT UP AREA (Y6) (X-Y5)			=	200.05 SQ.MT.		
EXCESS REFUGE AREA (Y7)			=	0.00 SQ.MT.		
EXCESS SOCIETY OFFICE AREA (Y8) (20 Sq.mtr Free of FSI)			=	12.15 SQ.MT.		
TOTAL BUILT UP AREA (Y9) (Y6+Y7+Y8)			=	212.20 SQ.MT.		


LINE AREA DIAGRAM FOR 4TH TO 7TH & 9TH TO 15TH TYPICAL FLOOR (TOWER-7)

ADDITION (X)	A	26.65 X 21.38	X	100 X 1	=	569.78 SQ.MT.
TOTAL					=	569.78 SQ.MT.
STANDARD DEDUCTION (Y1)	1	2.80 X 5.10 X 100 X 1	=	14.28 SQ.MT.		
	2	6.25 X 0.72 X 100 X 1	=	4.50		
	3	5.25 X 0.85 X 100 X 1	=	4.46		
	4	7.95 X 2.05 X 100 X 1	=	16.30		
	5	0.90 X 0.20 X 100 X 1	=	0.18		
	6	6.05 X 3.35 X 100 X 1	=	20.27		
	7	3.65 X 2.45 X 100 X 1	=	8.94		
	8	1.80 X 1.95 X 100 X 1	=	3.51		
	9	1.50 X 0.37 X 100 X 1	=	0.56		
	10	0.28 X (2.58 + 3.18) X 200 X 1	=	0.81		
	11	3.05 X 2.72 X 100 X 1	=	8.30		
	12	3.20 X 8.20 X 100 X 1	=	26.24		
	13	2.45 X 0.85 X 100 X 1	=	2.08		
	14	0.90 X 0.20 X 100 X 1	=	0.18		
	15	2.70 X 2.25 X 100 X 1	=	6.08		
	16	5.55 X 1.17 X 100 X 1	=	6.49		
	17	6.60 X 4.85 X 100 X 1	=	32.01		
	18	4.90 X 0.75 X 100 X 1	=	3.68		
	19	1.10 X 1.65 X 100 X 1	=	1.82		
	20	0.45 X 1.35 X 100 X 1	=	0.61		
	21	4.55 X 1.38 X 100 X 2	=	12.60		
	22	6.05 X 1.38 X 100 X 1	=	8.35		
	TOTAL		=	187.70 SQ.MT.		
STAIRCASE, LIFT, LOBBY & PASSAGE DEDUCTION (Y2)	S1	1.90 X 3.35 X 100 X 1	=	6.37 SQ.MT.		
	S2	3.40 X 3.15 X 100 X 1	=	10.71		
	L1	2.45 X 2.30 X 100 X 1	=	5.64		
	L2	3.10 X 2.18 X 100 X 1	=	6.76		
	LB1	2.45 X 1.25 X 100 X 1	=	5.51		
	LB2	1.15 X 1.17 X 100 X 1	=	0.88		
	LB3	2.55 X 3.15 X 100 X 1	=	8.03		
		0.45 X 1.35 X 100 X 1	=	0.61		
	LB4	2.87 X 0.90 X 100 X 1	=	2.58		
	LB5	1.18 X 1.80 X 100 X 1	=	2.12		
	LB6	1.07 X 1.70 X 100 X 1	=	1.82		
	TOTAL		=	50.52 SQ.MT.		
TOTAL DEDUCTION (Y3) (Y1+Y2)			=	238.23 SQ.MT.		
TOTAL BUILT UP AREA (Y4) (X-Y3)			=	331.55 SQ.MT.		


LINE AREA DIAGRAM FOR 4TH TO 7TH & 9TH TO 15TH TYPICAL FLOOR (TOWER-7)
SCALE - 1:100

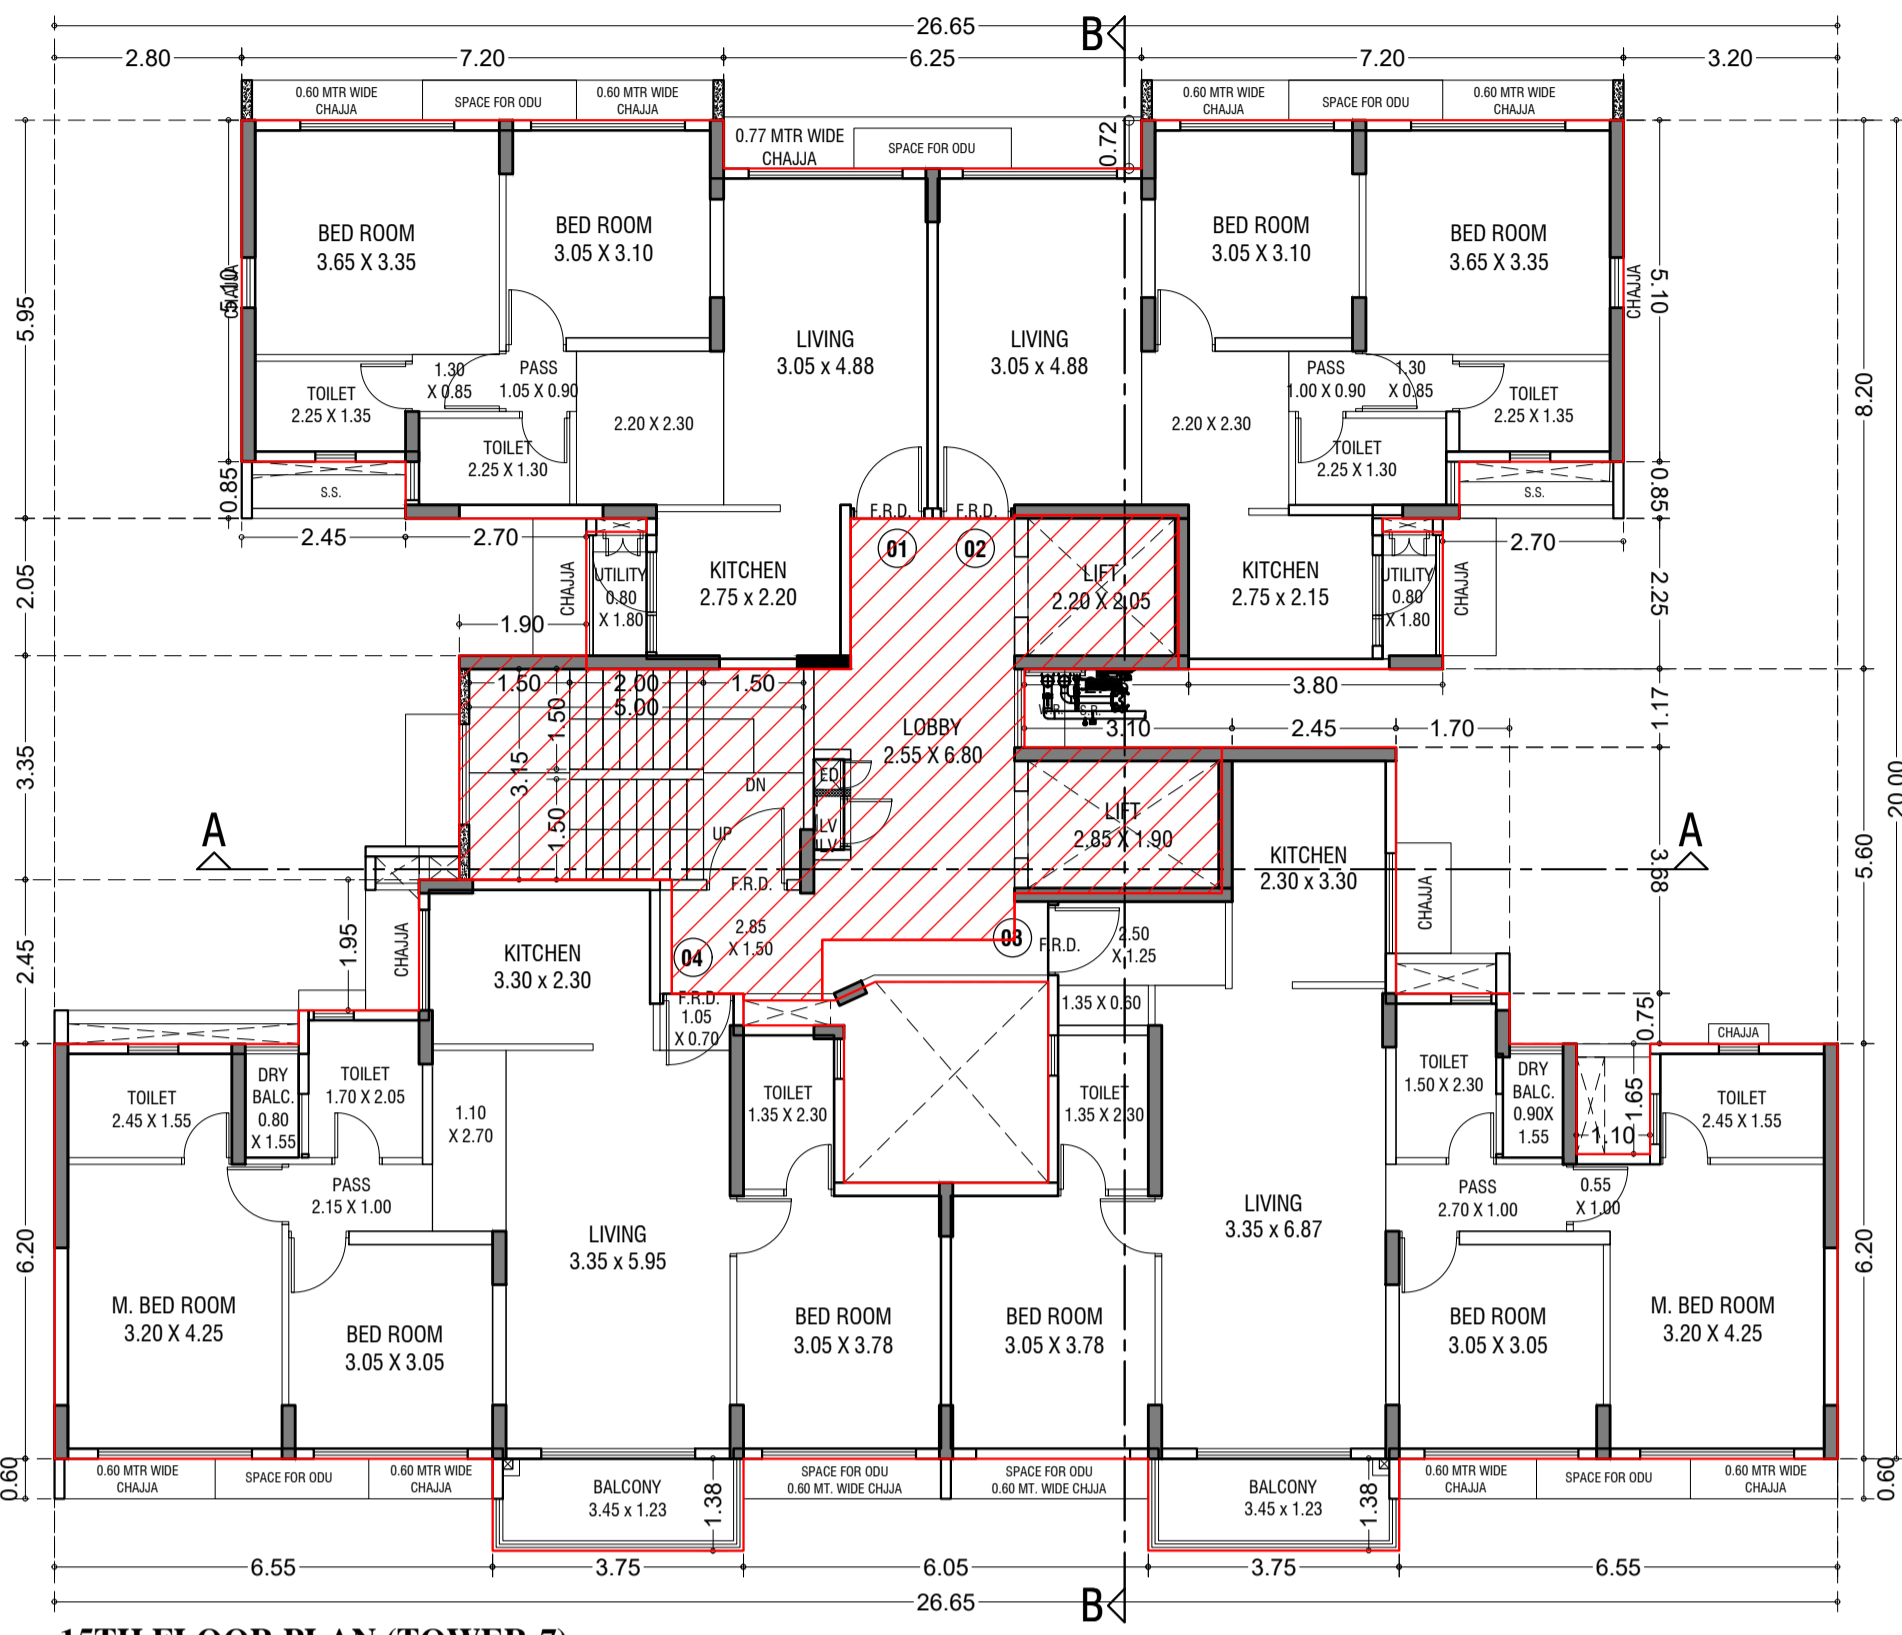

15TH FLOOR PLAN (TOWER-7)
SCALE - 1:100

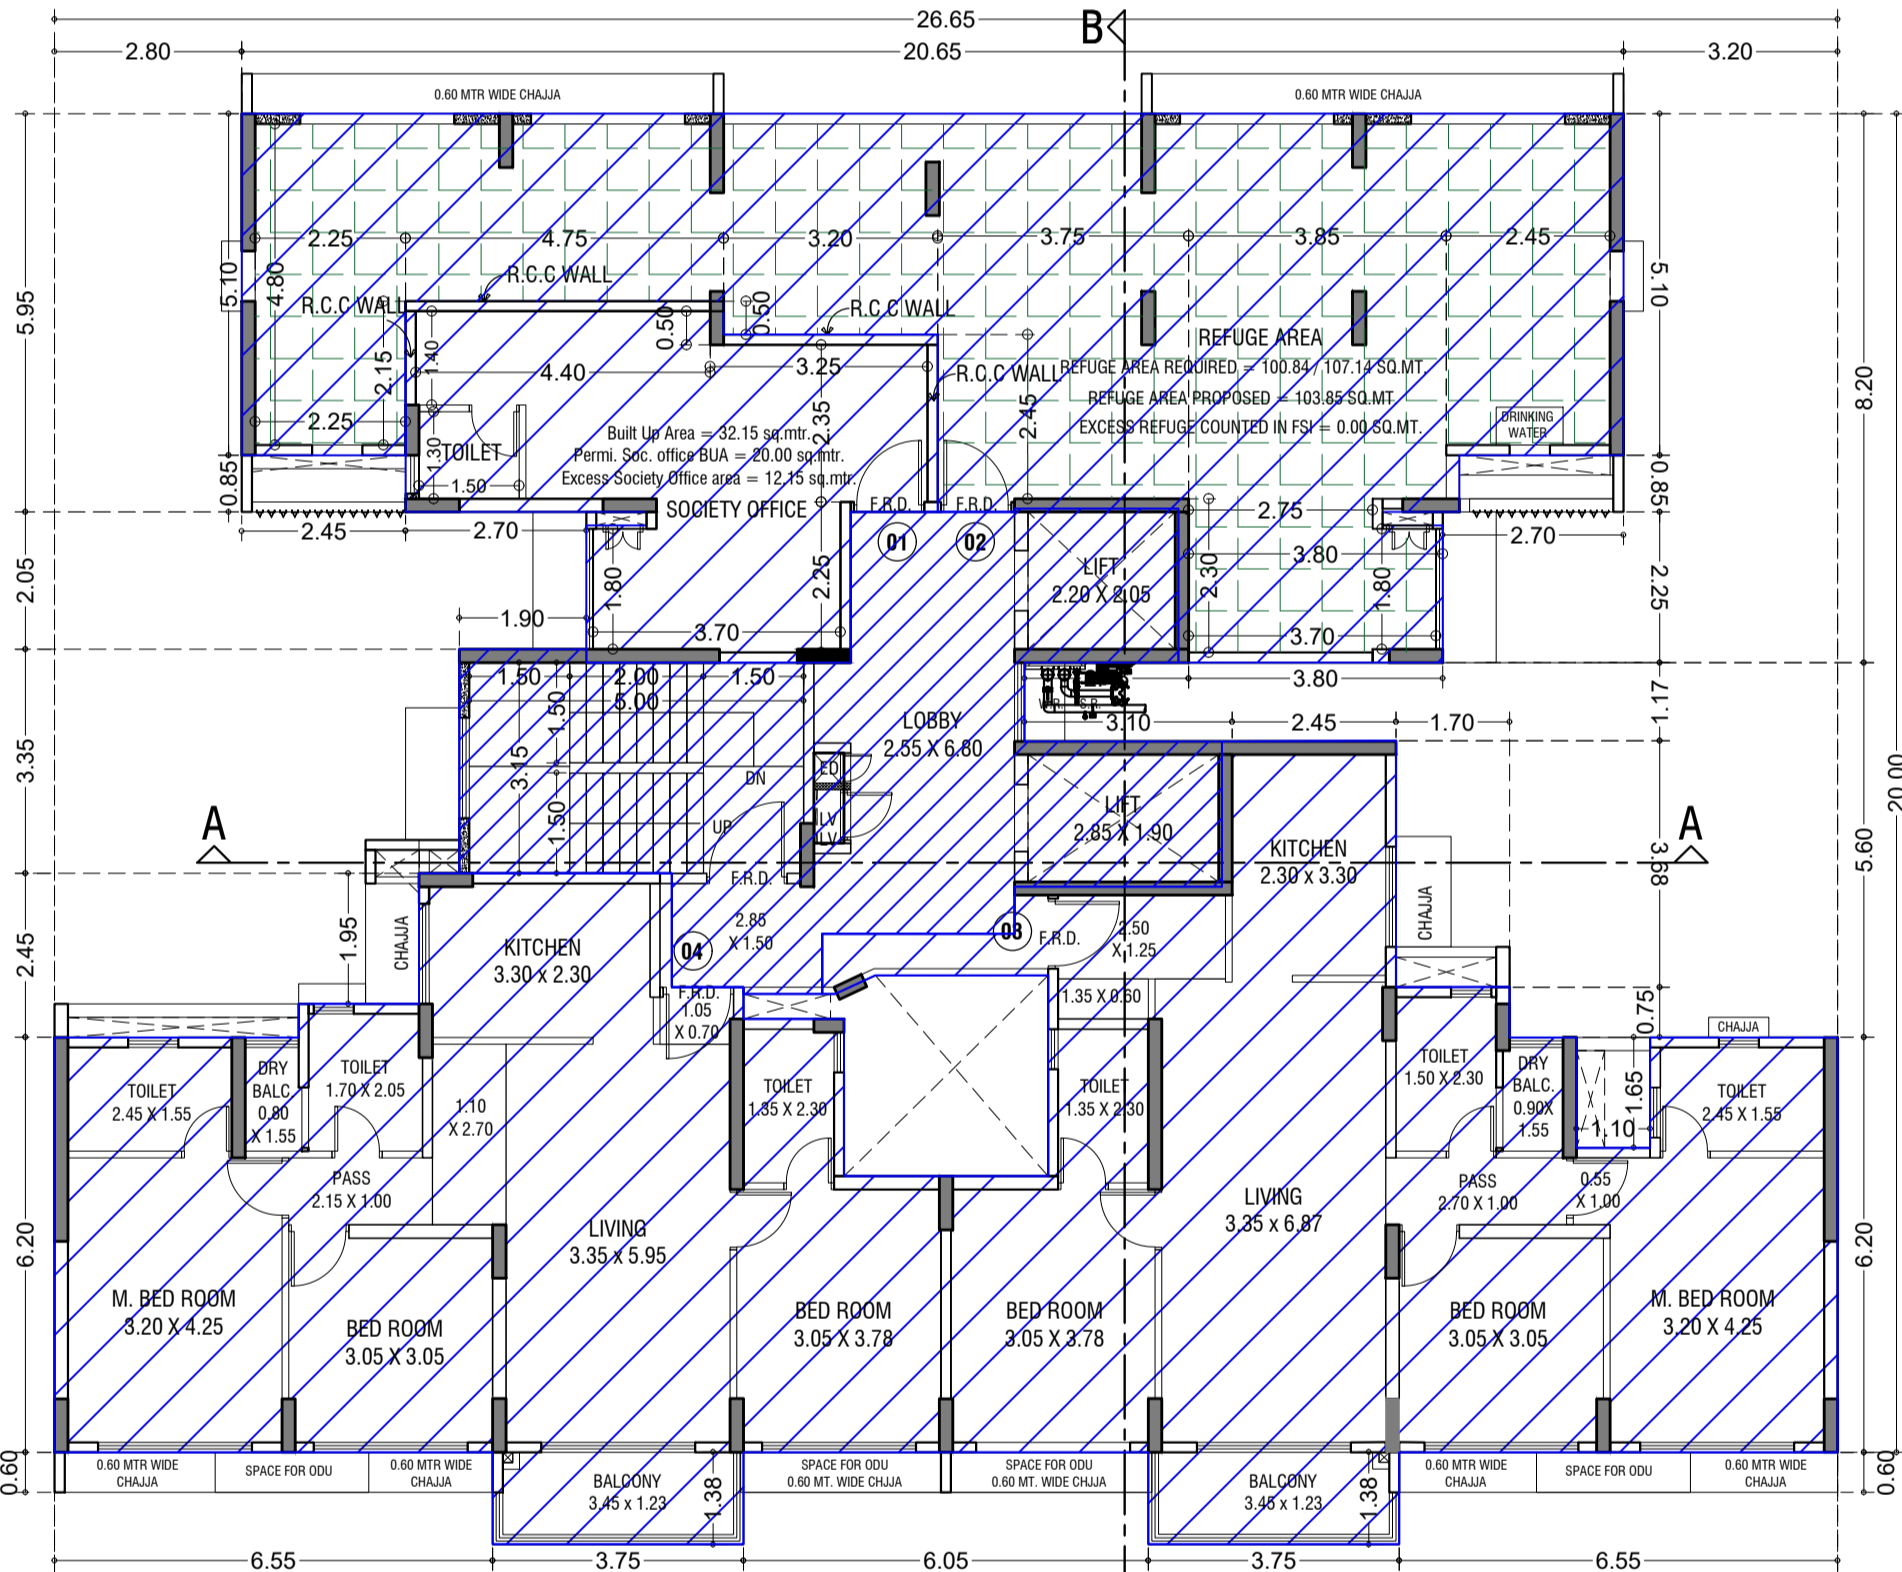

8TH REFUGE FLOOR PLAN (TOWER-7)
SCALE - 1:100

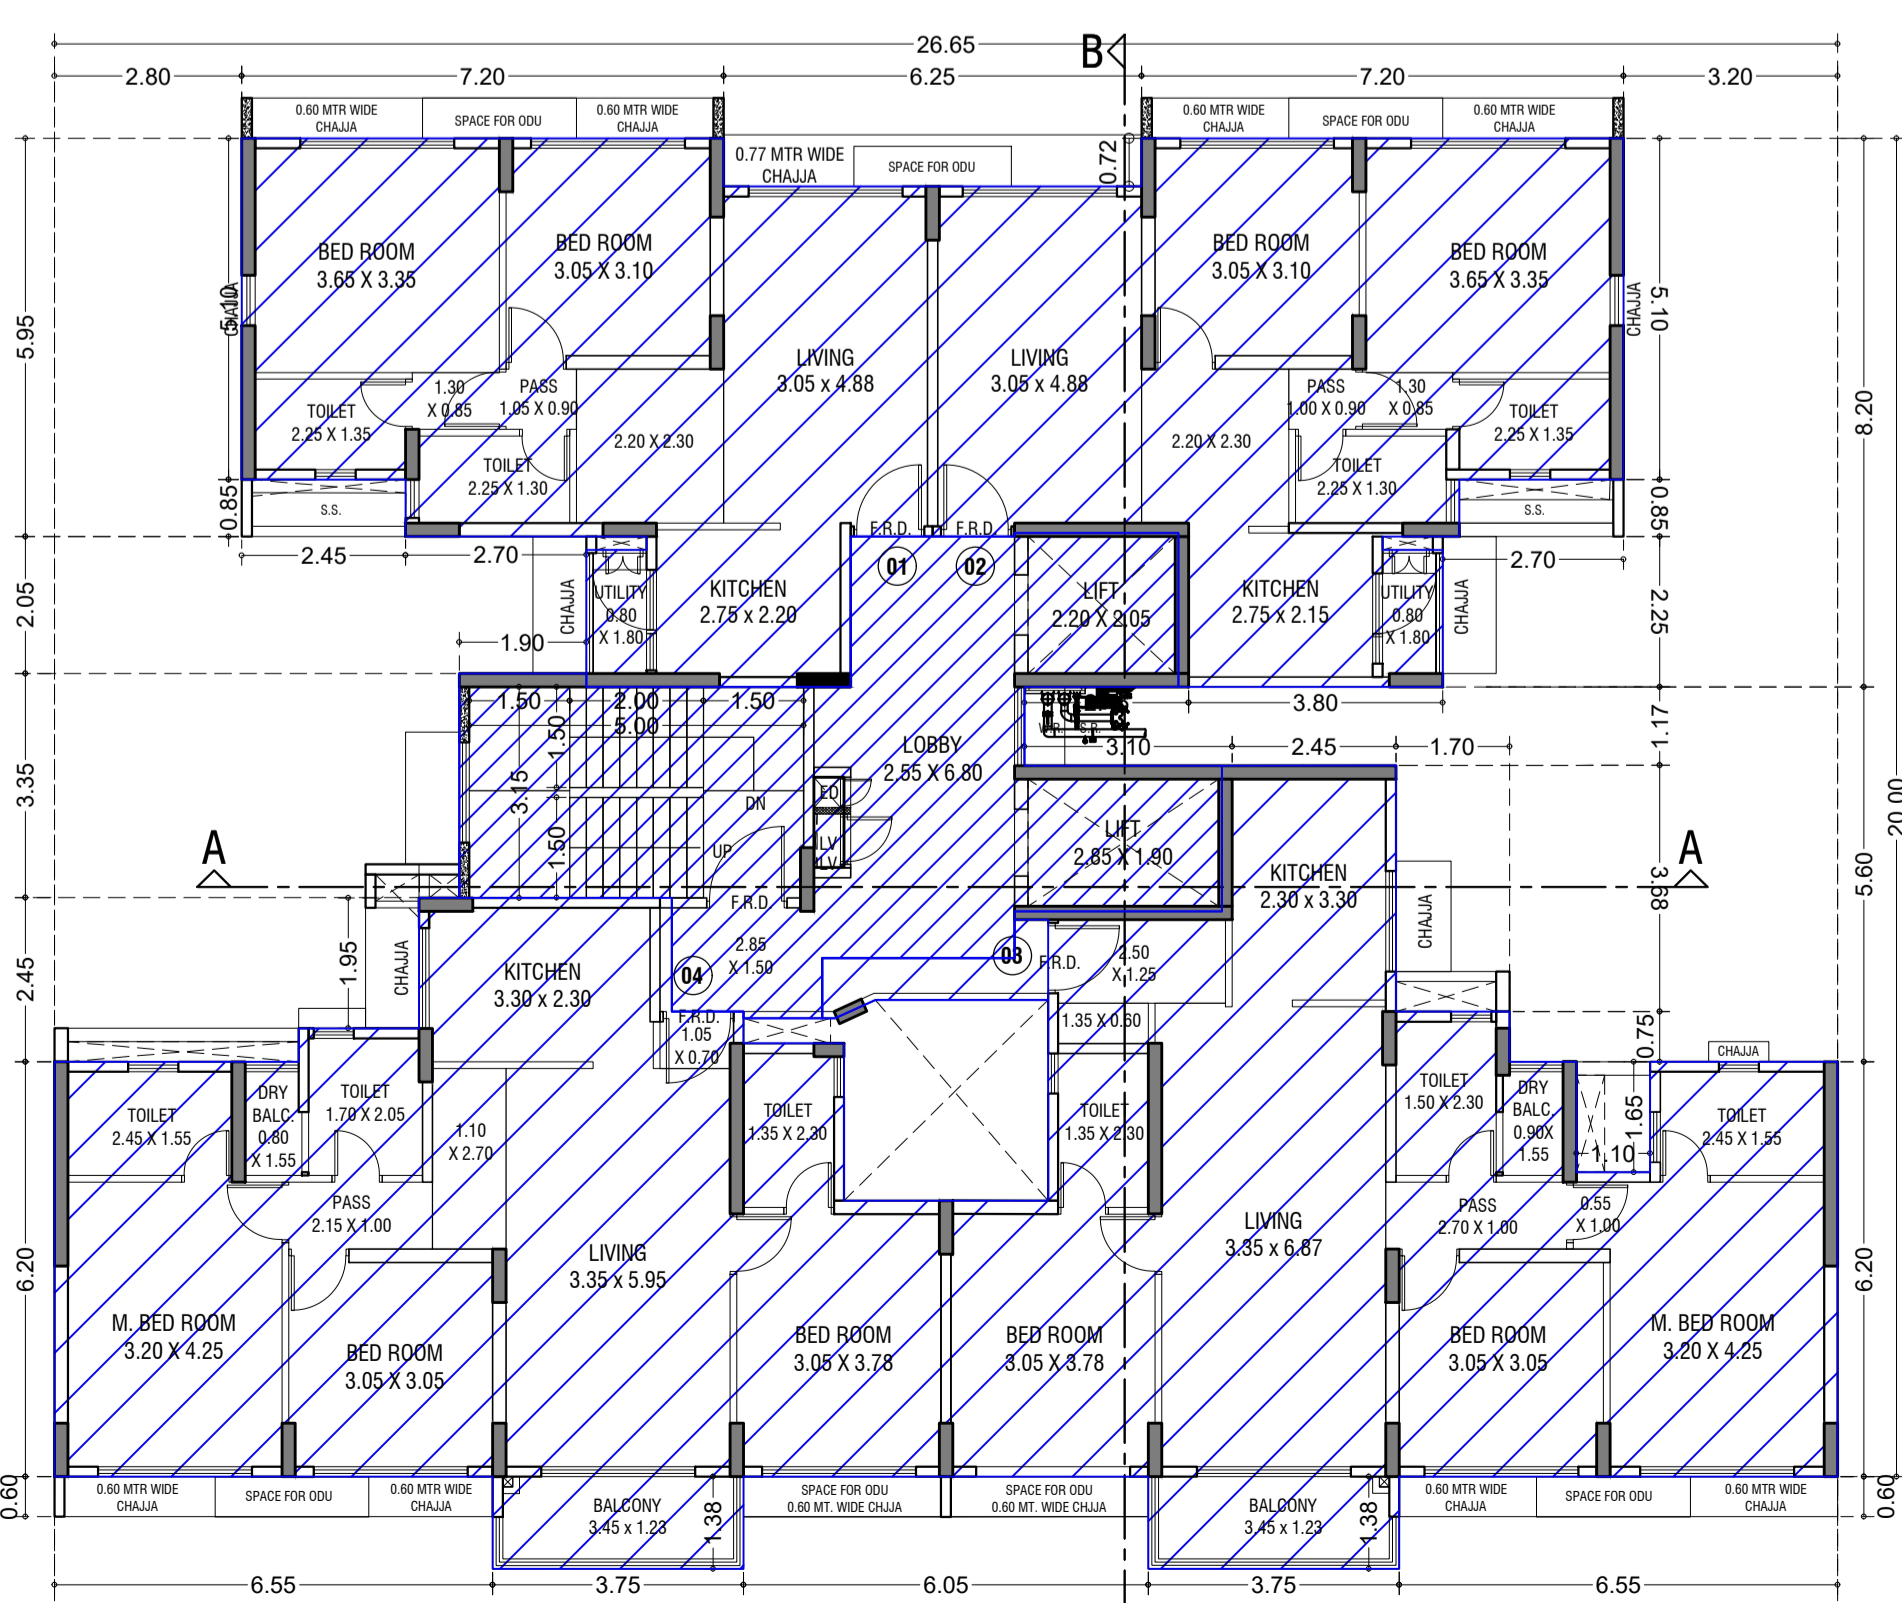

5TH TO 7TH & 9TH TO 14TH TYPICAL FLOOR PLAN (TOWER-7)
SCALE - 1:100




BUILT UP AREA SUMMARY (Tower-7)

FLOOR	RESI. BUILT UP AREA	Total	STAIRCASE AREA	Tower-7 Tenements
BASEMENT	0.00	0.00	0.00	0
GROUND	0.00	0.00	0.00	0
1ST FLOOR	97.45	34.11	131.56	43.95
2nd FLOOR	97.50	34.12	131.62	46.38
3rd FLOOR	237.93	83.27	321.20	50.52
4th FLOOR	245.59	85.96	331.55	50.52
5th FLOOR	245.59	85.96	331.55	50.52
6th FLOOR	245.59	85.96	331.55	50.52
7th FLOOR	245.59	85.96	331.55	50.52
8th FLOOR (Refuge)	157.19	55.01	212.20	50.52
9th FLOOR	245.59	85.96	331.55	50.52
10th FLOOR	245.59	85.96	331.55	50.52
11th FLOOR	245.59	85.96	331.55	50.52
12th FLOOR	245.59	85.96		

CONTENTS OF SHEET
TOWER 8
FLOOR PLAN & AREA DIAGRAM, FLAT RERA CARPET

BUILT UP AREA SUMMARY (Tower-8)					Tower-8 Tenements
FLOOR	RESI. BUILT UP AREA	Total	STAIRCASE AREA		
	Base FSI	Fungible FSI	per floor	per floor	
BASEMENT	0.00	0.00	0.00	0.00	
GROUND	0.00	0.00	0.00	0.00	0
1ST FLOOR	75.99	26.60	102.59	46.43	1
2nd FLOOR	76.70	26.85	103.55	47.13	1
3rd FLOOR	214.28	75.00	289.28	47.08	3
4th FLOOR	221.95	77.68	299.63	47.08	3
5th FLOOR	221.95	77.68	299.63	47.08	3
6th FLOOR	221.95	77.68	299.63	47.08	3
7th FLOOR	221.95	77.68	299.63	47.08	3
8th FLOOR (Refuge)	149.67	52.39	202.06	47.08	2
9th FLOOR	221.95	77.68	299.63	47.08	3
10th FLOOR	221.95	77.68	299.63	47.08	3
11th FLOOR	221.95	77.68	299.63	47.08	3
12th FLOOR	221.95	77.68	299.63	47.08	3
13th FLOOR	221.95	77.68	299.63	47.08	3
14th FLOOR	221.95	77.68	299.63	47.08	3
15th FLOOR	221.95	77.68	299.63	47.08	3
TOTAL	2958.08	1035.33	3993.41	705.60	40
TOTAL				3993.41 SQ.MT.	

REFUGE AREA STATEMENT FOR 8TH (REFUGE) FLOOR (TOWER 8)		
HABITABLE AREA OF UPPER FLOORS	9th to 15th floor (299.63 Sq.mtr per 8 th)	= 2097.41
	8th floor	= 198.36
	total habitable area	= 2295.77
REFUGE REQUIRED ON 8TH FLOOR	= 4%	91.83 SQMT
REFUGE PROVIDED	=	101.27 SQMT
WITHIN 4.25 % REFUGE AREA NOT COUNTED IN FSI	=	97.57 SQMT
EXCESS REFUGE AREA COUNTED IN FSI	=	3.70 SQMT

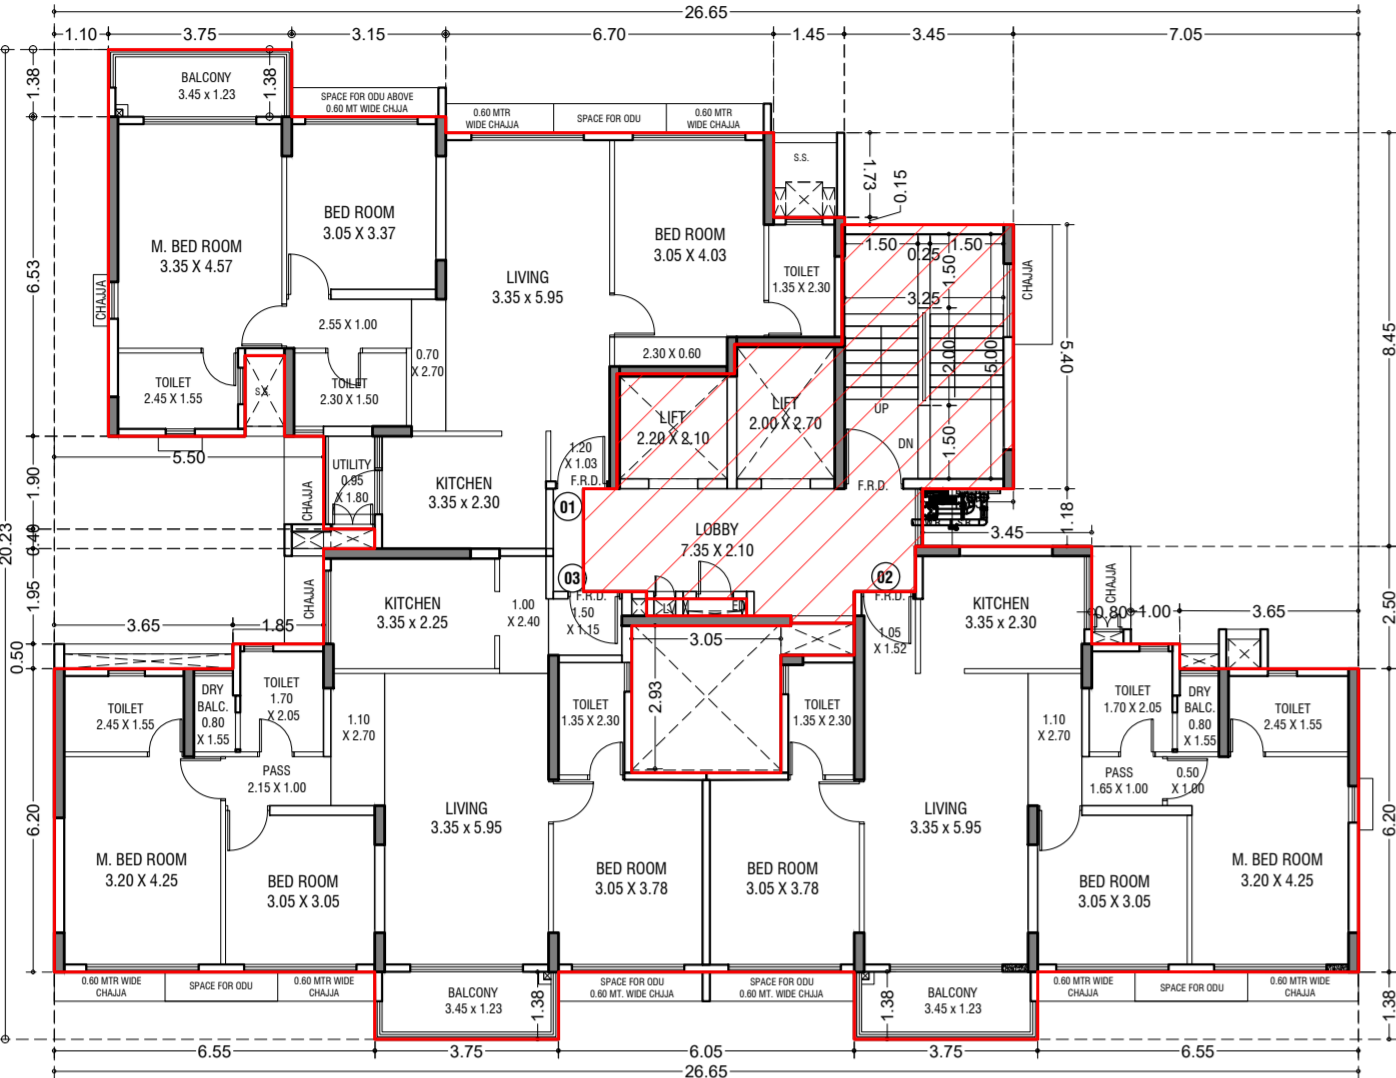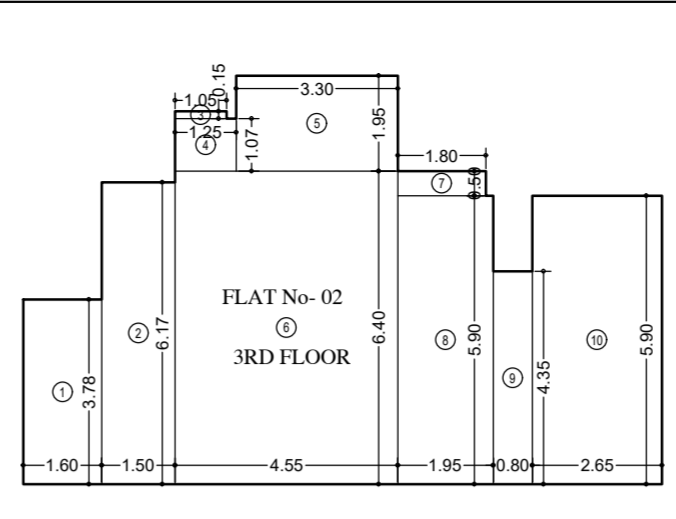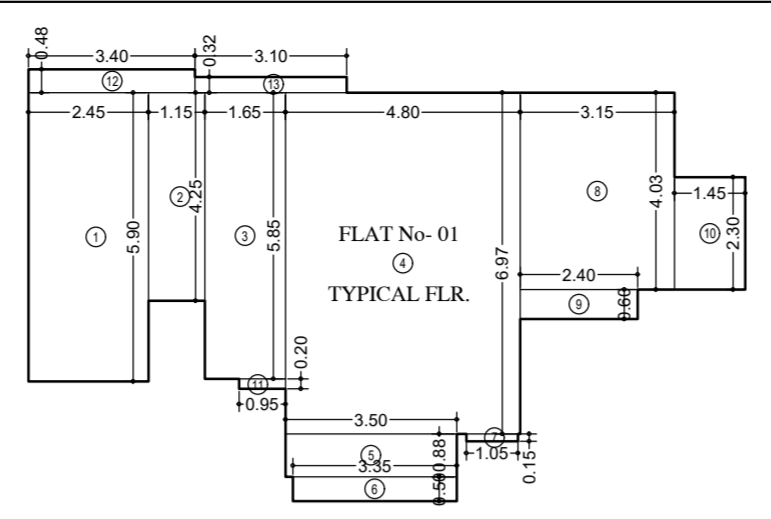




15TH FLOOR PLAN (TOWER-8)
SCALE: 1:100

CARPET AREA CALCULATION (FOR PARKING PURPOSE) FOR 1ST TO 7TH, 9TH TO 15TH FLOOR (TOWER-8)

FLAT No.	Dimensions	Area
1	2.45 X 5.90 X 1 No	= 14.46 Sq.mtr
2	1.15 X 4.25 X 1 No	= 4.89 Sq.mtr
3	1.65 X 5.85 X 1 No	= 9.65 Sq.mtr
4	4.80 X 6.97 X 1 No	= 33.46 Sq.mtr
5	3.50 X 0.88 X 1 No	= 3.08 Sq.mtr
6	3.35 X 0.90 X 1 No	= 3.02 Sq.mtr
7	1.05 X 0.15 X 1 No	= 0.16 Sq.mtr
8	3.15 X 4.03 X 1 No	= 12.69 Sq.mtr
9	2.60 X 0.60 X 1 No	= 1.56 Sq.mtr
10	1.45 X 2.30 X 1 No	= 3.34 Sq.mtr
11	0.95 X 0.20 X 1 No	= 0.19 Sq.mtr
12	3.40 X 0.48 X 1 No	= 1.63 Sq.mtr
13	3.10 X 0.32 X 1 No	= 0.99 Sq.mtr
TOTAL RERA AREA		= 87.66 Sq.mtr

CARPET AREA CALCULATION (FOR PARKING PURPOSE) FOR 3RD FLOOR (TOWER-8)

FLAT No.	Dimensions	Area
1	1.60 X 3.78 X 1 No	= 6.05 Sq.mtr
2	1.50 X 6.17 X 1 No	= 9.25 Sq.mtr
3	1.95 X 0.50 X 1 No	= 0.98 Sq.mtr
4	1.25 X 1.07 X 1 No	= 1.34 Sq.mtr
5	3.30 X 1.95 X 1 No	= 6.44 Sq.mtr
6	4.55 X 6.40 X 1 No	= 29.12 Sq.mtr
7	1.80 X 0.50 X 1 No	= 0.90 Sq.mtr
8	1.95 X 5.90 X 1 No	= 11.51 Sq.mtr
9	0.80 X 4.35 X 1 No	= 3.48 Sq.mtr
10	2.65 X 5.90 X 1 No	= 15.64 Sq.mtr
11	1.60 X 3.77 X 1 No	= 6.03 Sq.mtr
TOTAL RERA AREA		= 83.89 Sq.mtr

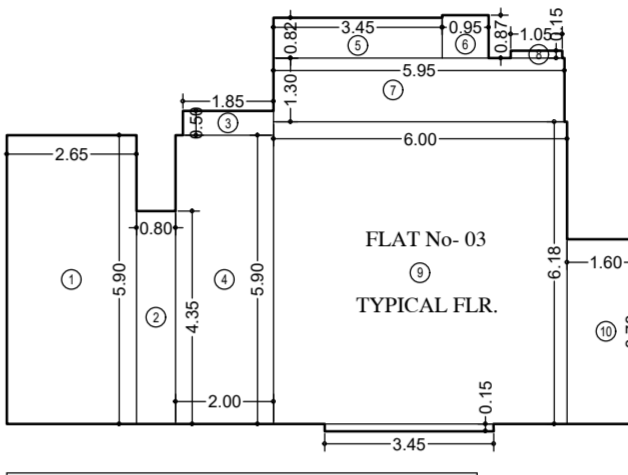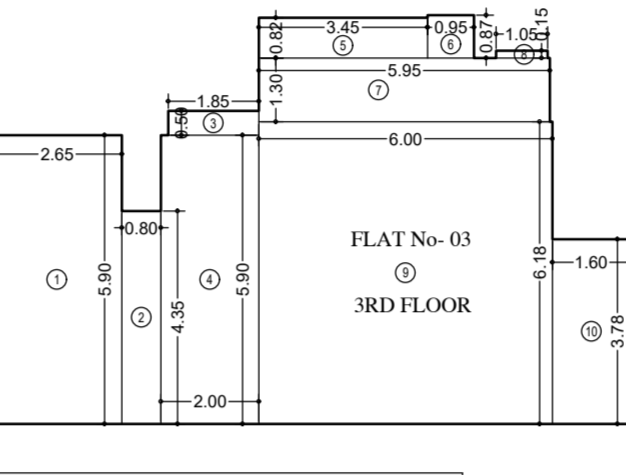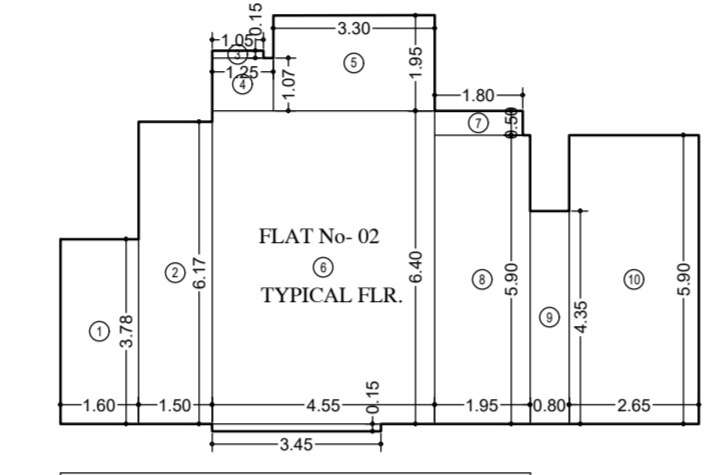

CARPET AREA CALCULATION (FOR PARKING PURPOSE) FOR 4TH TO 15TH FLOOR (TOWER-8)


FLAT No.	Dimensions	Area
1	1.60 X 3.78 X 1 No	= 6.05 Sq.mtr
2	1.50 X 6.17 X 1 No	= 9.25 Sq.mtr
3	1.95 X 0.50 X 1 No	= 0.98 Sq.mtr
4	1.25 X 1.07 X 1 No	= 1.34 Sq.mtr
5	3.30 X 1.95 X 1 No	= 6.44 Sq.mtr
6	4.55 X 6.40 X 1 No	= 29.12 Sq.mtr
7	1.80 X 0.50 X 1 No	= 0.90 Sq.mtr
8	1.95 X 5.90 X 1 No	= 11.51 Sq.mtr
9	0.80 X 4.35 X 1 No	= 3.48 Sq.mtr
10	2.65 X 5.90 X 1 No	= 15.64 Sq.mtr
11	1.60 X 3.77 X 1 No	= 6.03 Sq.mtr
TOTAL RERA AREA		= 84.47 Sq.mtr

CARPET AREA CALCULATION (FOR PARKING PURPOSE) FOR 3RD FLOOR (TOWER-8)


FLAT No.	Dimensions	Area
1	2.65 X 5.90 X 1 No	= 15.64 Sq.mtr
2	0.80 X 4.35 X 1 No	= 3.48 Sq.mtr
3	1.95 X 0.50 X 1 No	= 0.98 Sq.mtr
4	2.00 X 5.90 X 1 No	= 11.80 Sq.mtr
5	3.45 X 0.82 X 1 No	= 2.83 Sq.mtr
6	0.95 X 0.87 X 1 No	= 0.83 Sq.mtr
7	5.95 X 1.30 X 1 No	= 7.74 Sq.mtr
8	1.05 X 0.15 X 1 No	= 0.16 Sq.mtr
9	6.00 X 6.18 X 1 No	= 37.08 Sq.mtr
10	1.60 X 3.77 X 1 No	= 6.03 Sq.mtr
TOTAL RERA AREA		= 86.52 Sq.mtr

CARPET AREA CALCULATION (FOR PARKING PURPOSE) FOR 4TH TO 15TH FLOOR (TOWER-8)

FLAT No.	Dimensions	Area
1	2.65 X 5.90 X 1 No	= 15.64 Sq.mtr
2	0.80 X 4.35 X 1 No	= 3.48 Sq.mtr
3	1.95 X 0.50 X 1 No	= 0.98 Sq.mtr
4	2.00 X 5.90 X 1 No	= 11.80 Sq.mtr
5	3.45 X 0.82 X 1 No	= 2.83 Sq.mtr
6	0.95 X 0.87 X 1 No	= 0.83 Sq.mtr
7	5.95 X 1.30 X 1 No	= 7.74 Sq.mtr
8	1.05 X 0.15 X 1 No	= 0.16 Sq.mtr
9	6.00 X 6.18 X 1 No	= 37.08 Sq.mtr
10	3.45 X 0.15 X 1 No	= 0.52 Sq.mtr
11	1.60 X 3.77 X 1 No	= 6.03 Sq.mtr
TOTAL RERA AREA		= 87.04 Sq.mtr

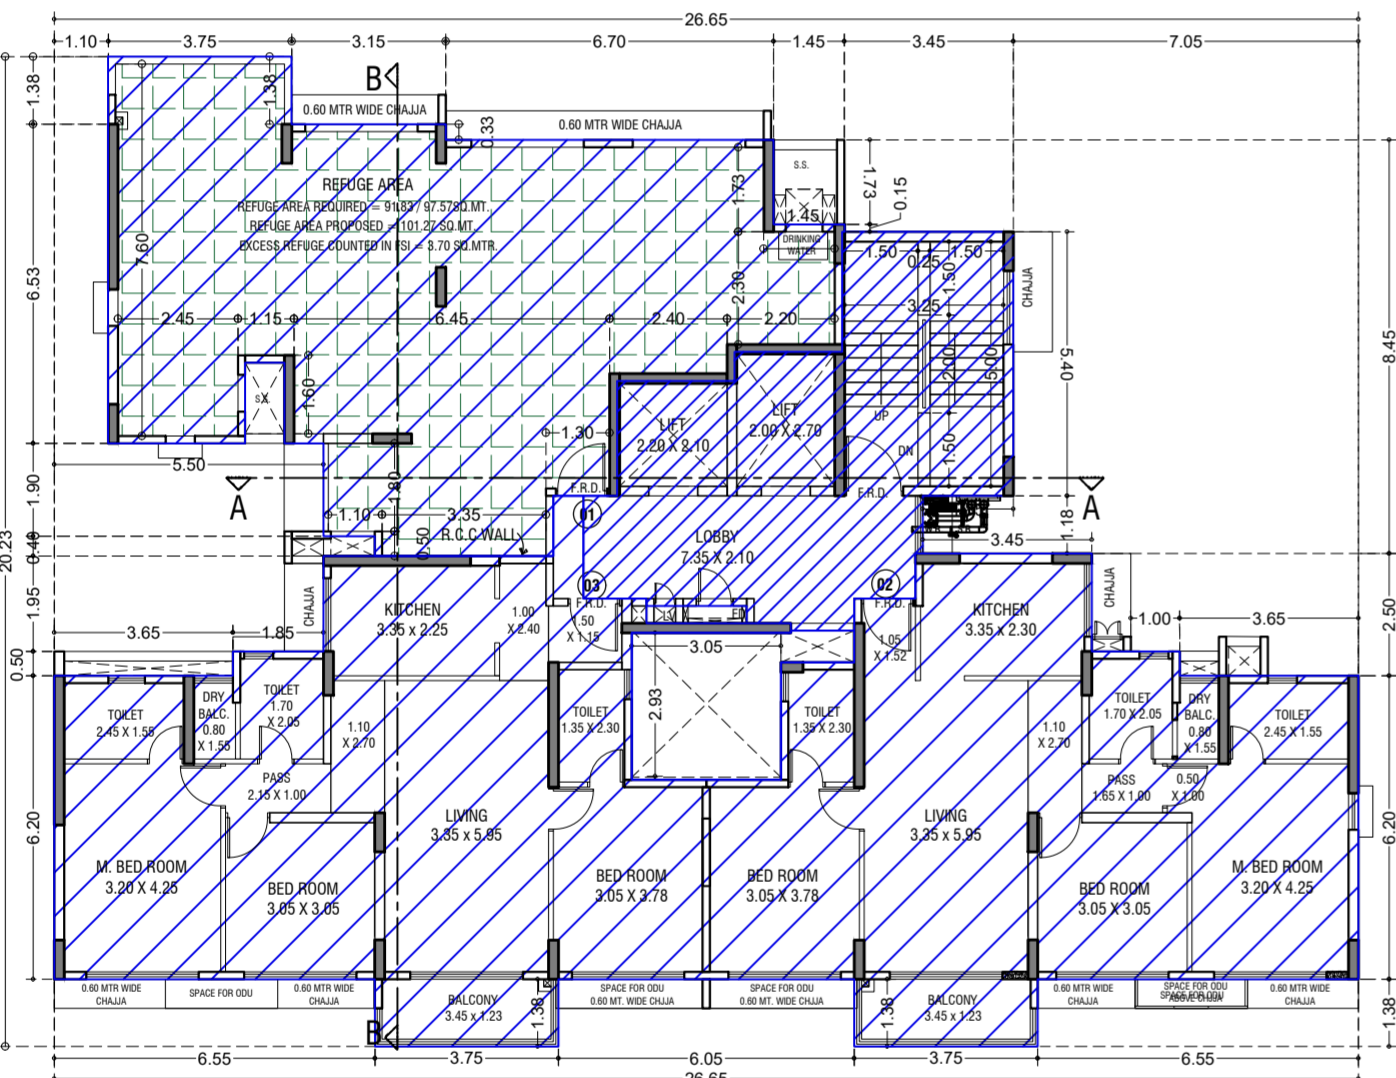

8TH REFUGE FLOOR PLAN (TOWER-8)
SCALE: 1:100

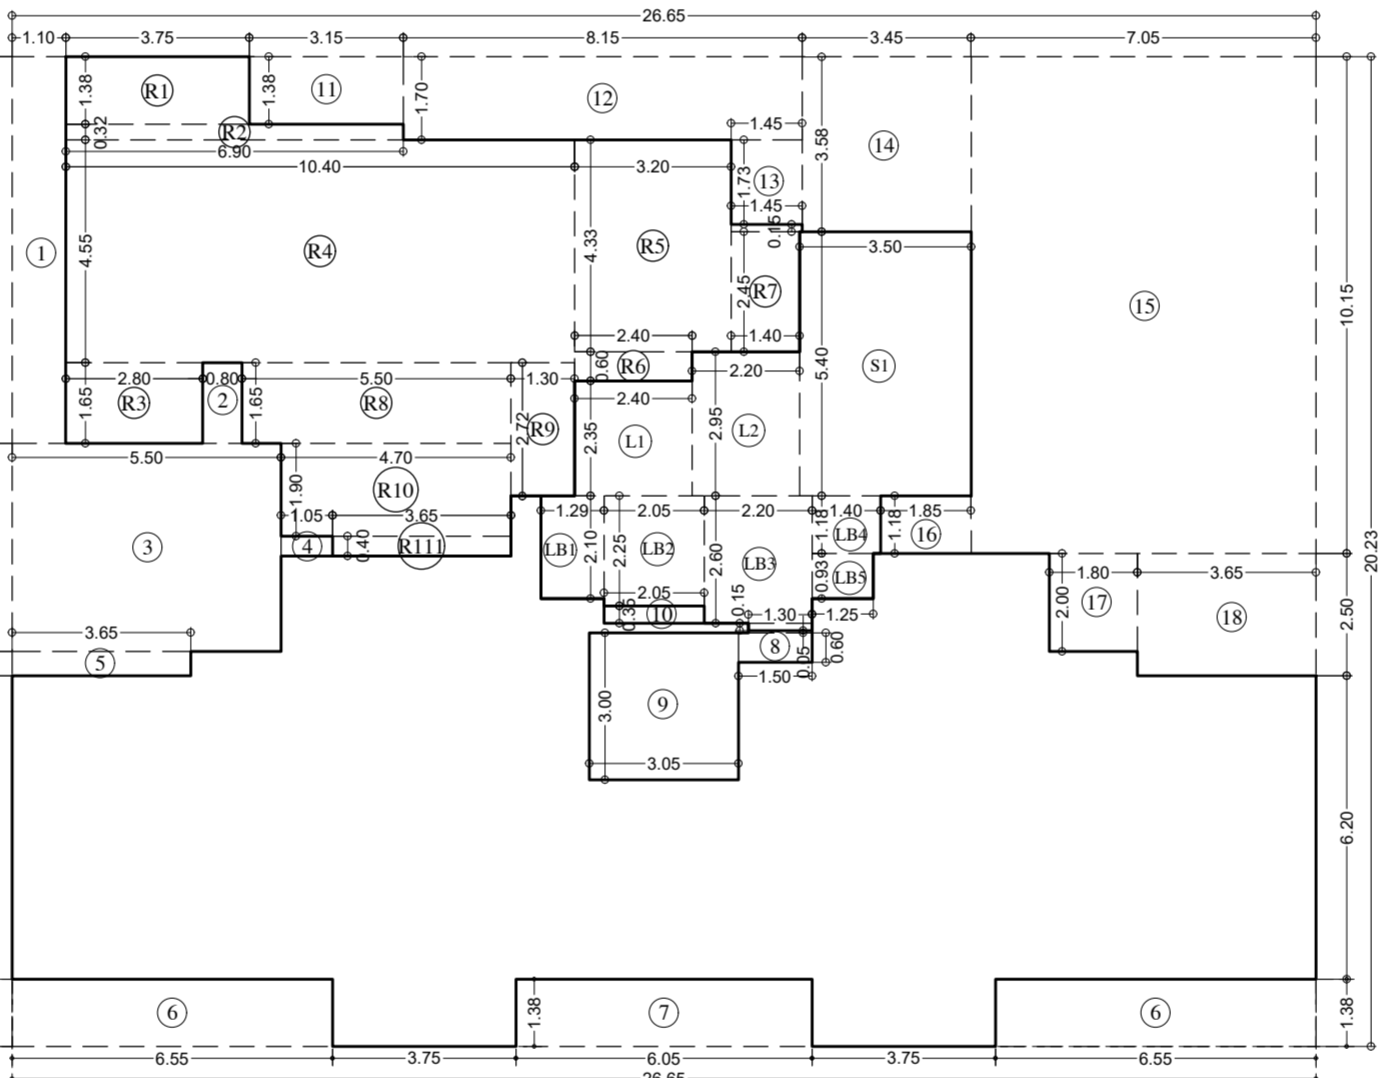

LINE AREA DIAGRAM FOR 8TH REFUGE FLOOR (TOWER-8)
SCALE: 1:100

LINE AREA DIAGRAM FOR 8TH REFUGE FLOOR (TOWER-8)

ADDITION (X)	Area
A	26.65 X 20.23 X 100 X 1 = 539.13 SQ.MT.
TOTAL	= 539.13 SQ.MT.
STANDARD DEDUCTION (Y1)	
1	1.10 X 7.90 X 100 X 1 = 8.69 SQ.MT.
2	0.80 X 1.65 X 100 X 1 = 1.32 *
3	5.50 X 4.25 X 100 X 1 = 23.38 *
4	1.05 X 0.40 X 100 X 1 = 0.42 *
5	3.65 X 0.50 X 100 X 1 = 1.83 *
6	6.55 X 1.38 X 100 X 2 = 18.08 *
7	6.05 X 1.38 X 100 X 1 = 8.35 *
8	1.50 X 0.60 X 100 X 1 = 0.90 *
9	1.30 X 0.05 X 100 X 1 = 0.07 *
10	3.05 X 3.00 X 100 X 1 = 9.15 *
11	2.05 X 0.35 X 100 X 1 = 0.72 *
12	8.15 X 1.70 X 100 X 1 = 13.86 *
13	1.45 X 1.73 X 100 X 1 = 2.51 *
14	3.45 X 3.58 X 100 X 1 = 12.35 *
15	7.05 X 10.15 X 100 X 1 = 71.56 *
16	1.85 X 1.18 X 100 X 1 = 2.18 *
17	1.80 X 2.00 X 100 X 1 = 3.60 *
18	3.65 X 2.50 X 100 X 1 = 9.13 *
TOTAL	= 192.42 SQ.MT.
STAIRCASE, LIFT, LOBBY & PASSAGE DEDUCTION (Y2)	
S1	3.50 X 5.40 X 100 X 1 = 18.90 SQ.MT.
L1	2.40 X 2.35 X 100 X 1 = 5.64 *
L2	2.20 X 2.95 X 100 X 1 = 6.49 *
LB1	1.29 X 2.10 X 100 X 1 = 2.71 *
LB2	2.05 X 2.25 X 100 X 1 = 4.61 *
LB3	2.20 X 2.60 X 100 X 1 = 5.72 *
LB4	1.30 X 0.15 X 100 X 1 = 0.20 *
LB5	1.40 X 1.18 X 100 X 1 = 1.65 *
LB6	1.25 X 0.93 X 100 X 1 = 1.16 *
TOTAL	= 47.08 SQ.MT.
REFUGE AREA DEDUCTION (Y3)	
R1	3.75 X 1.38 X 100 X 1 = 5.18 SQ.MT.
R2	6.90 X 0.32 X 100 X 1 = 2.21 *
R3	2.80 X 1.65 X 100 X 1 = 4.62 *
R4	10.40 X 4.55 X 100 X 1 = 47.32 *
R5	3.20 X 4.53 X 100 X 1 = 13.86 *
R6	2.40 X 0.60 X 100 X 1 = 1.44 *
R7	1.40 X 2.45 X 100 X 1 = 3.43 *
R8	1.45 X 0.15 X 100 X 1 = 0.22 *
R9	5.50 X 1.65 X 100 X 1 = 9.08 *
R10	1.30 X 2.72 X 100 X 1 = 3.54 *
R11	4.70 X 1.90 X 100 X 1 = 8.93 *
R12	3.65 X 0.40 X 100 X 1 = 1.46 *
TOTAL	= 101.27 SQ.MT.
TOTAL DEDUCTION (Y4) (Y1+Y2+Y3)	= 340.77 SQ.MT.
TOTAL BUILT UP AREA (Y5) (X+Y4)	= 198.36 SQ.MT.
EXCESS REFUGE AREA (Y6)	= 3.70 SQ.MT.
TOTAL BUILT UP AREA (Y5+Y6)	= 202.06 SQ.MT.

LEGENDS:-
AREA SHOWN FOR OC OBTAINED

STAMP AND DATE OF APPROVAL OF PLAN
THIS CANCELS APPROVAL TO PREVIOUS PLANS SANCTION UNDER NO. P-5303/2020/ 24 And Other/L Ward/CHANDIVALI/337/10/Amended dt. 25.06.2024

APPROVED SUBJECT TO THE CONDITIONS MENTIONED IN THIS OFFICE LETTER NO. P-5303/2020/ 24 And Other/L Ward/CHANDIVALI/337/11/AMENDED



S.E.(B.P) N A.E.(B.P) 'L' WARD E.E. (B.P.) ES-1
DESCRIPTION OF PROPOSAL & PROPERTY
PROPOSED DEVELOPMENT ON PLOT BEARING C.T.S. NO. 24/A TO 24/E & OLD CTS NO. 24/1, 24/2 & 24/3 OF VILLAGE CHANDIVALI, CHANDIVALI ROAD, 'L' WARD, MUMBAI.

NORTH	JOB. NO.	DRG. NO.	DRAWN BY
	525	14/23	
	SCALE	DATE	CHECKED BY
	1:200		


REVISIONS DESCRIPTION:
NAME AND ADDRESS OF DESIGN ARCHITECT
EDIFICE CONSULTANTS PVT. LTD.
FIRST FLOOR PLOT #2A UJAGAR INFOTECH PARK, OPPOSITE DEONAR BUS DEPOT SUNDER BAUG, GOVANDI EAST, MUMBAI, MAHARASHTRA 400088

NAME OF THE OWNER SIGNATURE
M/S. GODREJ PROPERTIES, LTD.

AUTHORIZED SIGNATORY SIGNATURE
NAME AND ADDRESS OF LICENSED SURVEYOR (L.S.) SIGNATURE

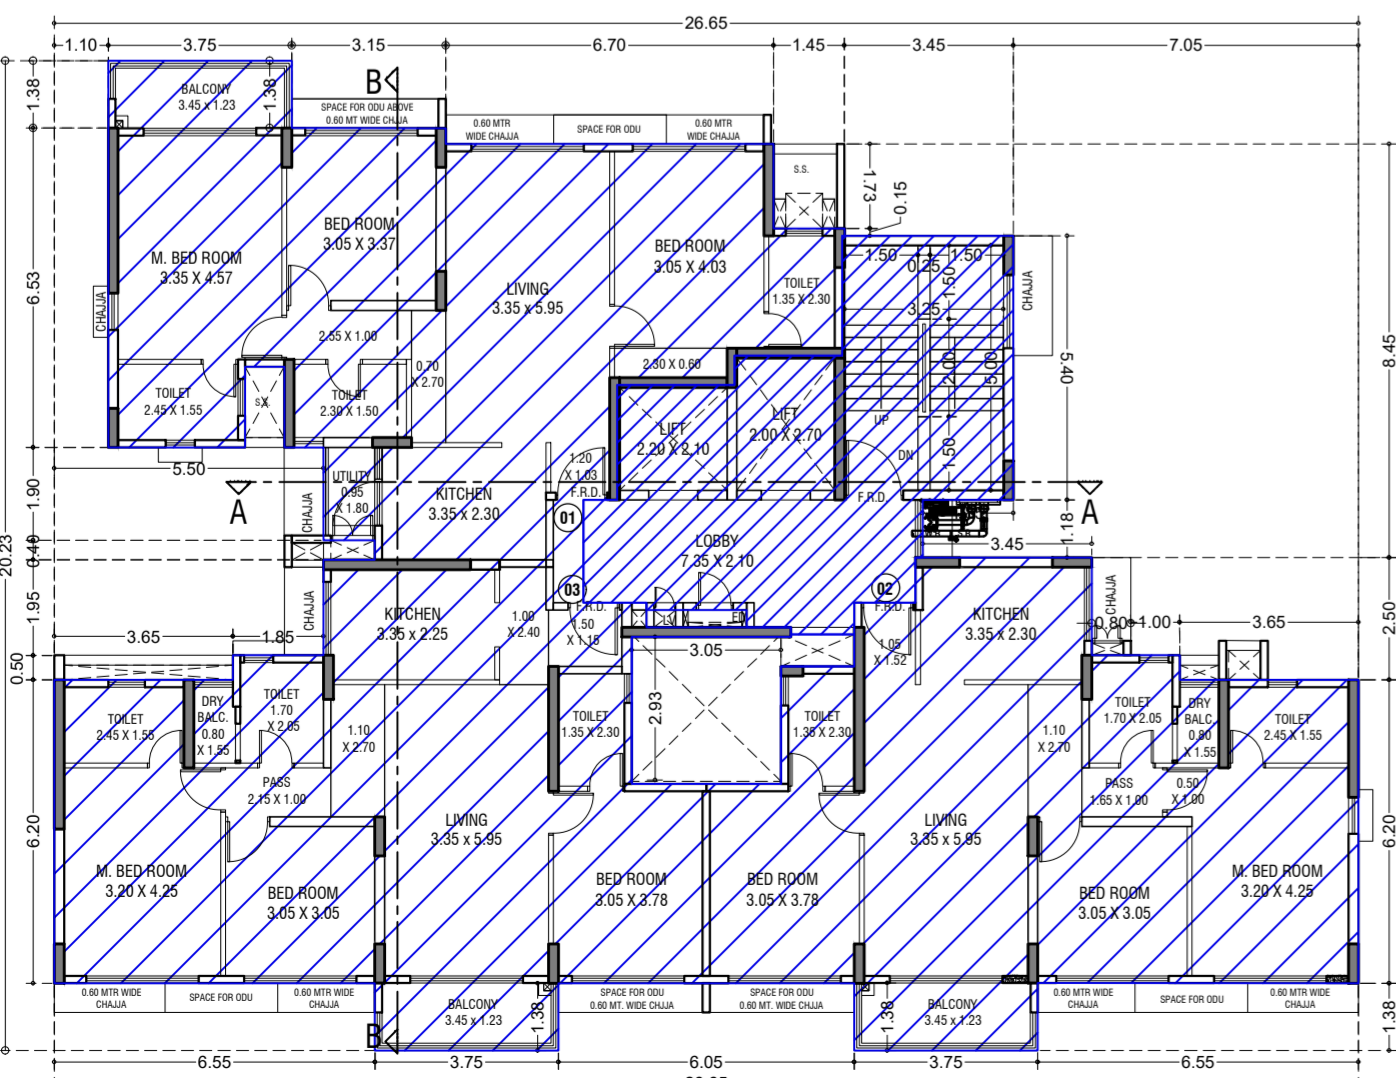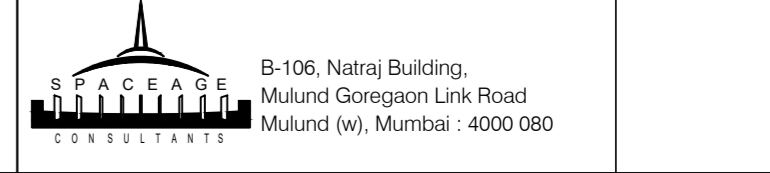

5TH TO 7TH & 9TH TO 14TH TYPICAL FLOOR PLAN (TOWER-8)
SCALE: 1:100

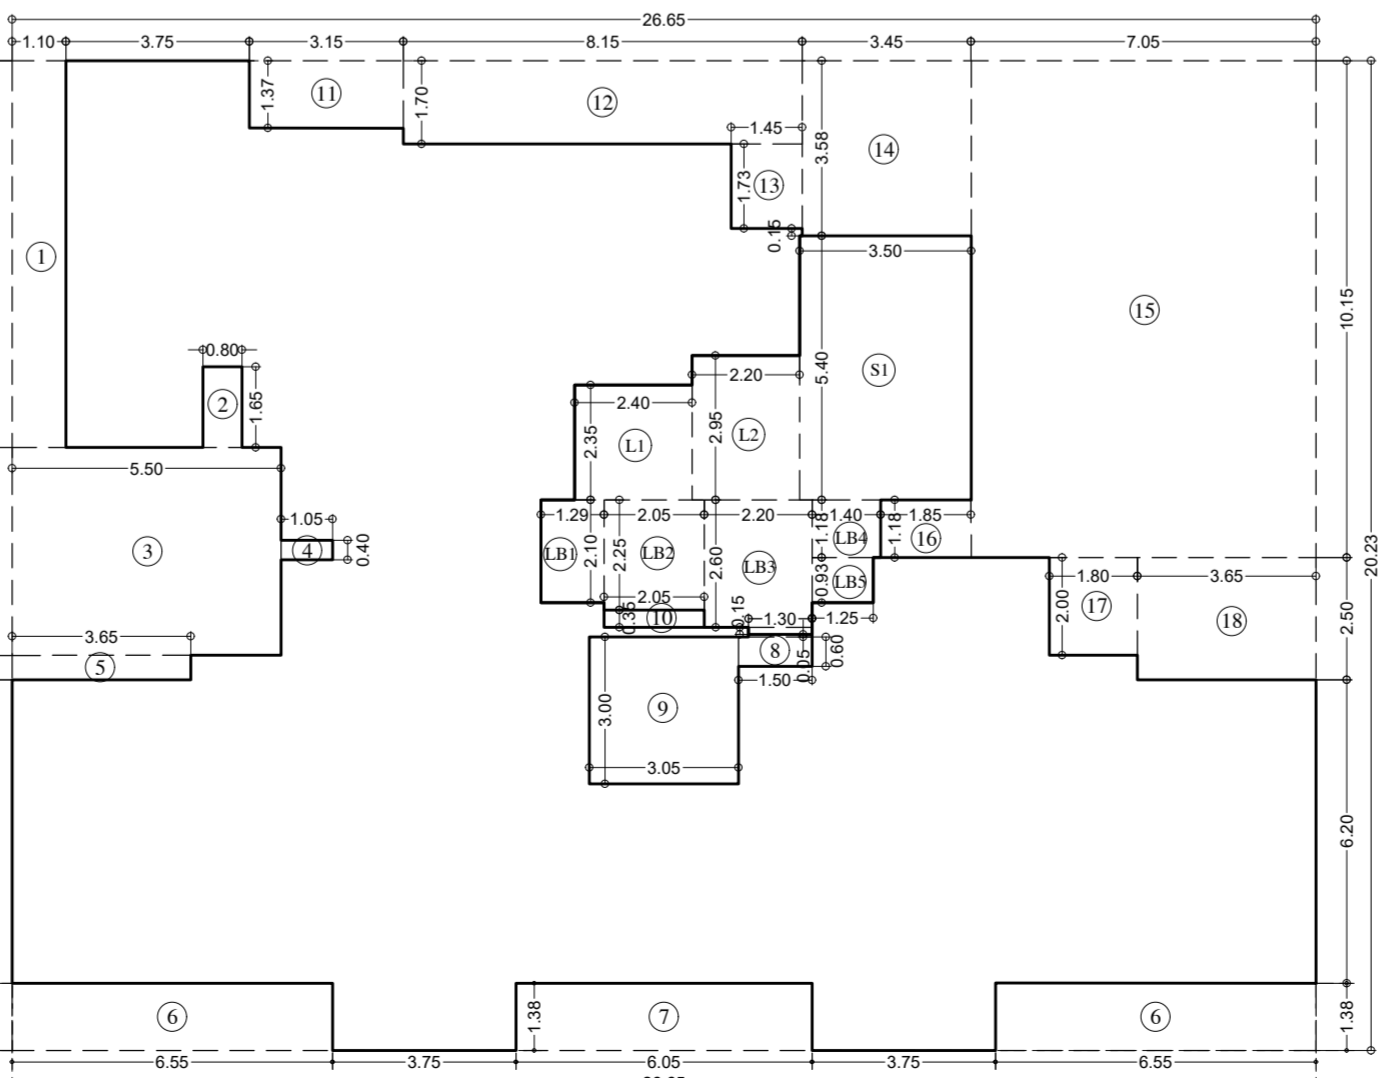






LINE AREA DIAGRAM FOR 4TH TO 7TH & 9TH TO 15TH TYPICAL FLOOR (TOWER-8)
SCALE: 1:100

LINE AREA DIAGRAM FOR 4TH TO 7TH & 9TH TO 15TH TYPICAL FLOOR (TOWER-8)

ADDITION (X)	Area
A	26.65 X 20.23 X 100 X 1 = 539.13 SQ.MT.
TOTAL	= 539.13 SQ.MT.
STANDARD DEDUCTION (Y1)	
1	1.10 X 7.90 X 100 X 1 = 8.69 SQ.MT.
2	0.80 X 1.65 X 100 X 1 = 1.32 *
3	5.50 X 4.25 X 100 X 1 = 23.38 *
4	1.05 X 0.40 X 100 X 1 = 0.42 *
5	3.65 X 0.50 X 100 X 1 = 1.83 *
6	6.55 X 1.38 X 100 X 2 = 18.08 *
7	6.05 X 1.38 X 100 X 1 = 8.35 *
8	1.50 X 0.60 X 100 X 1 = 0.90 *
9	1.30 X 0.05 X 100 X 1 = 0.07 *
10	3.05 X 3.00 X 100 X 1 = 9.15 *
11	2.05 X 0.35 X 100 X 1 = 0.72 *
12	8.15 X 1.70 X 100 X 1 = 13.86 *
13	1.45 X 1.73 X 100 X 1 = 2.51 *
14	3.45 X 3.58 X 100 X 1 = 12.35 *
15	7.05 X 10.15 X 100 X 1 = 71.56 *
16	1.85 X 1.18 X 100 X 1 = 2.18 *
17	1.80 X 2.00 X 100 X 1 = 3.60 *
18	3.65 X 2.50 X 100 X 1 = 9.13 *
TOTAL	= 192.42 SQ.MT.
STAIRCASE, LIFT, LOBBY & PASSAGE DEDUCTION (Y2)	
S1	3.50 X 5.40 X 100 X 1 = 18.90 SQ.MT.
L1	2.40 X 2.35 X 100 X 1 = 5.64 *
L2	2.20 X 2.95 X 100 X 1 = 6.49 *
LB1	1.29 X 2.10 X 100 X 1 = 2.71 *
LB2	2.05 X 2.25 X 100 X 1 = 4.61 *
LB3	2.20 X 2.60 X 100 X 1 = 5.72 *
LB4	1.30 X 0.15 X 100 X 1 = 0.20 *
LB5	1.40 X 1.18 X 100 X 1 = 1.65 *
LB6	1.25 X 0.93 X 100 X 1 = 1.16 *
TOTAL	= 47.08 SQ.MT.
TOTAL DEDUCTION (Y3) (Y1+Y2)	= 239.50 SQ.MT.
TOTAL BUILT UP AREA (Y4) (X+Y3)	= 299.63 SQ.MT.

CONTENTS OF SHEET
TOWER 9
FLOOR PLAN & AREA DIAGRAM, FLAT RERA CARPET

BUILT UP AREA SUMMARY (Tower-9)					Tower-9 Tenements
FLOOR	RESI. BUILT UP AREA	Total	STAIRCASE AREA		
	Base FSI	Fungible FSI	per floor	per floor	
BASEMENT	11.56	4.04	11.56	0.00	0
GROUND	4.14	1.45	5.59	0.00	4
1ST FLOOR	157.18	55.01	212.19	68.96	4
2nd FLOOR	151.74	53.11	204.85	70.06	4
3rd FLOOR	201.01	70.36	271.37	70.65	5
4th FLOOR	201.01	70.36	271.37	70.65	5
5th FLOOR	201.01	70.36	271.37	70.65	5
6th FLOOR	201.01	70.36	271.37	70.65	5
7th FLOOR	201.01	70.36	271.37	70.65	5
8th FLOOR (Refuge)	142.81	49.98	192.79	70.65	4
9th FLOOR	201.01	70.36	271.37	70.65	5
10th FLOOR	201.01	70.36	271.37	70.65	5
11th FLOOR	201.01	70.36	271.37	70.65	5
12th FLOOR	201.01	70.36	271.37	55.72	5
13th FLOOR	201.01	70.36	271.37	55.72	5
14th FLOOR	201.01	70.36	271.37	55.72	5
15th FLOOR	201.01	70.36	271.37	55.72	5
TOTAL	2879.60	1007.86	3887.46	997.75	72
TOTAL			3887.46		

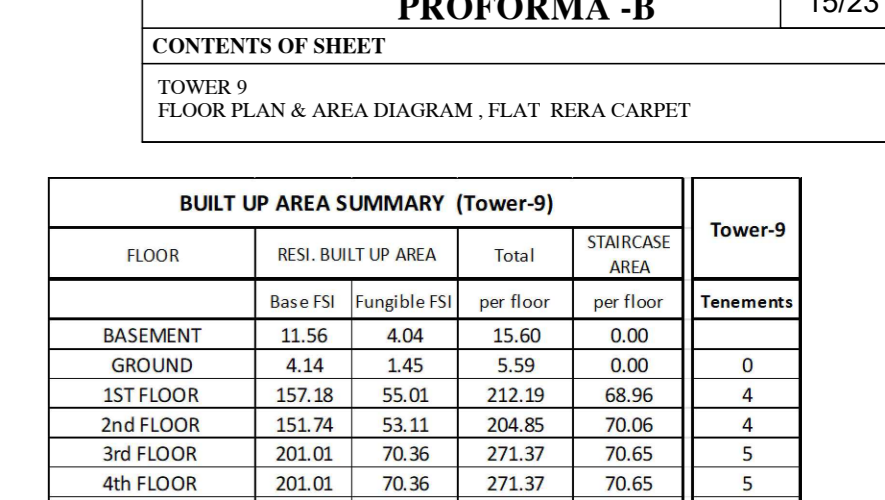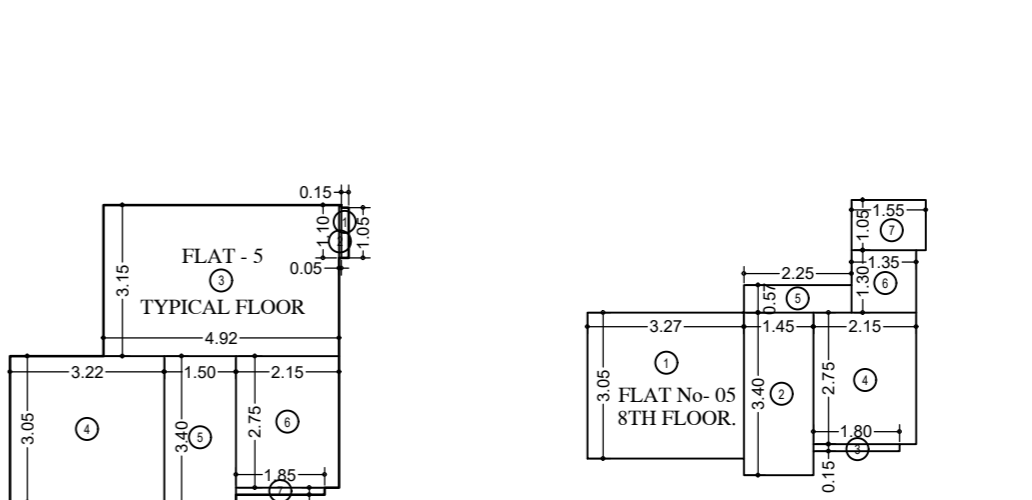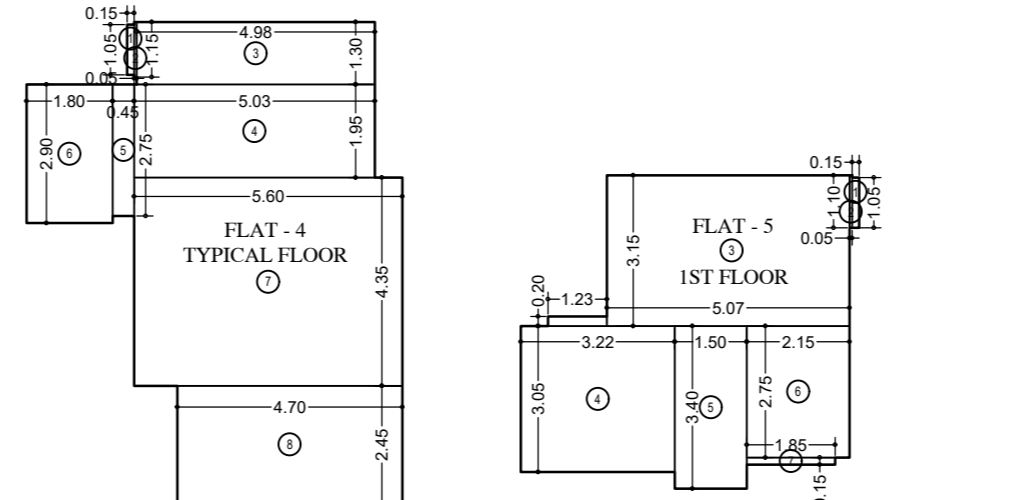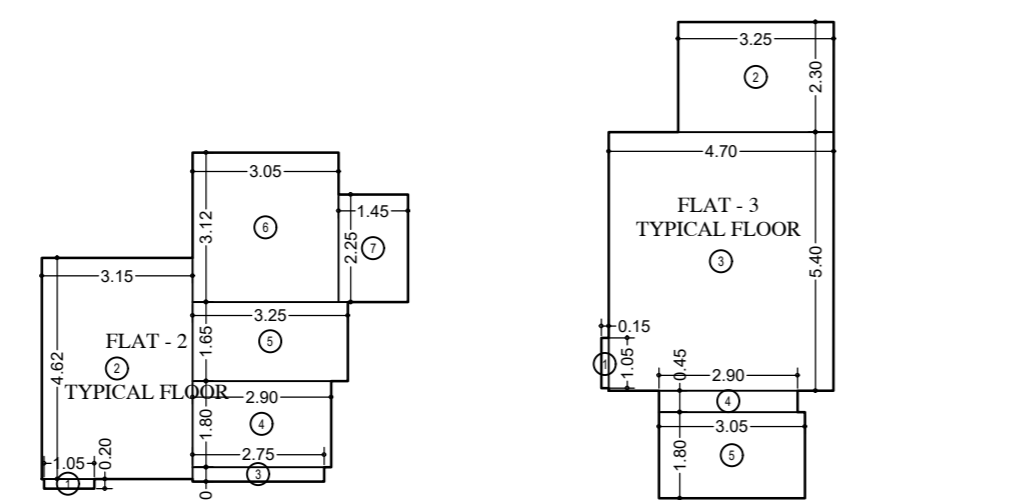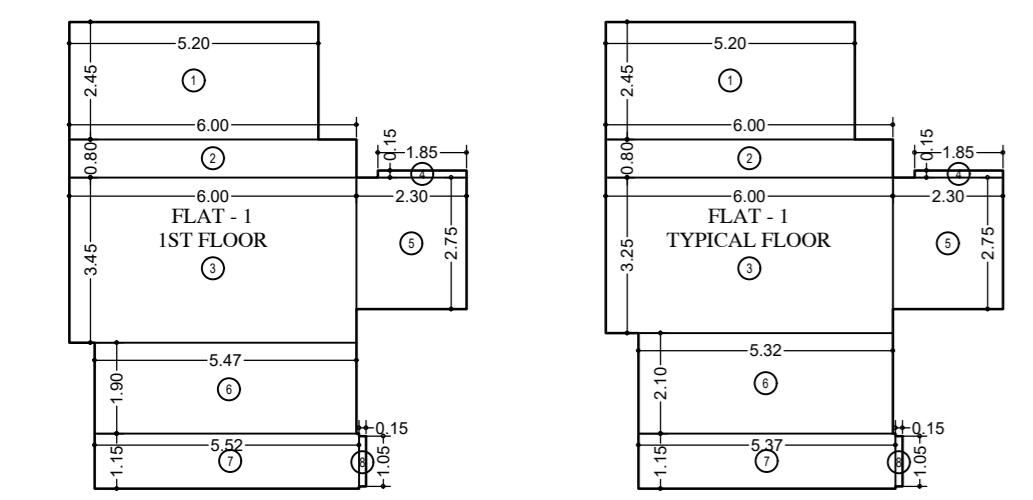

CARPET AREA CALCULATION (FOR PARKING PURPOSE) FOR 1ST FLOOR (TOWER-9)

1	8.20 X 2.45 X 1 NO	=	12.74	Sq.Mt
2	6.00 X 0.90 X 1 NO	=	4.80	Sq.Mt
3	6.00 X 3.45 X 1 NO	=	20.70	Sq.Mt
4	1.85 X 0.15 X 1 NO	=	0.28	Sq.Mt
5	2.30 X 2.75 X 1 NO	=	6.33	Sq.Mt
6	5.47 X 1.90 X 1 NO	=	10.39	Sq.Mt
7	6.52 X 1.15 X 1 NO	=	6.36	Sq.Mt
8	6.15 X 1.05 X 1 NO	=	6.46	Sq.Mt
TOTAL RERA AREA		=	61.75	Sq.Mt

CARPET AREA CALCULATION (FOR PARKING PURPOSE) FOR 2ND TO 7TH & 11TH FLR. (TOWER-9)

1	5.20 X 2.45 X 1 NO	=	12.74	Sq.Mt
2	6.00 X 0.90 X 1 NO	=	4.80	Sq.Mt
3	6.00 X 3.25 X 1 NO	=	19.50	Sq.Mt
4	1.85 X 0.15 X 1 NO	=	0.28	Sq.Mt
5	2.30 X 2.75 X 1 NO	=	6.33	Sq.Mt
6	5.32 X 2.10 X 1 NO	=	11.17	Sq.Mt
7	6.37 X 1.15 X 1 NO	=	6.18	Sq.Mt
8	6.15 X 1.05 X 1 NO	=	6.46	Sq.Mt
TOTAL RERA AREA		=	61.16	Sq.Mt

CARPET AREA CALCULATION (FOR PARKING PURPOSE) FOR 1ST TO 11TH FLOOR (TOWER-9)

1	1.05 X 0.30 X 1 NO	=	0.31	Sq.Mt
2	3.15 X 4.82 X 1 NO	=	14.35	Sq.Mt
3	2.75 X 0.30 X 1 NO	=	0.83	Sq.Mt
4	2.90 X 1.80 X 1 NO	=	5.22	Sq.Mt
5	3.25 X 1.65 X 1 NO	=	5.36	Sq.Mt
6	3.65 X 3.12 X 1 NO	=	11.39	Sq.Mt
7	1.45 X 2.25 X 1 NO	=	3.26	Sq.Mt
TOTAL RERA AREA		=	38.95	Sq.Mt

CARPET AREA CALCULATION (FOR PARKING PURPOSE) FOR 1ST TO 11TH FLOOR (TOWER-9)

1	0.15 X 1.05 X 1 NO	=	0.16	Sq.Mt
2	3.95 X 1.95 X 1 NO	=	7.70	Sq.Mt
3	4.98 X 1.30 X 1 NO	=	6.47	Sq.Mt
4	5.03 X 1.95 X 1 NO	=	9.81	Sq.Mt
5	1.50 X 0.25 X 1 NO	=	0.38	Sq.Mt
6	1.80 X 2.90 X 1 NO	=	5.22	Sq.Mt
7	4.30 X 4.25 X 1 NO	=	18.26	Sq.Mt
8	4.70 X 2.45 X 1 NO	=	11.52	Sq.Mt
TOTAL RERA AREA		=	58.84	Sq.Mt

CARPET AREA CALCULATION (FOR PARKING PURPOSE) FOR 3RD TO 11TH FLOOR (TOWER-9)

1	0.15 X 1.05 X 1 NO	=	0.16	Sq.Mt
2	0.95 X 1.10 X 1 NO	=	0.96	Sq.Mt
3	5.07 X 3.15 X 1 NO	=	15.97	Sq.Mt
4	1.23 X 0.20 X 1 NO	=	0.25	Sq.Mt
5	4.32 X 3.05 X 1 NO	=	13.18	Sq.Mt
6	1.50 X 3.40 X 1 NO	=	5.10	Sq.Mt
7	6.25 X 2.75 X 1 NO	=	17.19	Sq.Mt
8	1.85 X 0.15 X 1 NO	=	0.28	Sq.Mt
9	1.85 X 0.15 X 1 NO	=	0.28	Sq.Mt
TOTAL RERA AREA		=	37.55	Sq.Mt

CARPET AREA CALCULATION (FOR PARKING PURPOSE) FOR 1ST FLOOR (TOWER-9)



1	0.15 X 1.05 X 1 NO	=	0.16	Sq.Mt
2	0.95 X 1.10 X 1 NO	=	0.96	Sq.Mt
3	5.07 X 3.15 X 1 NO	=	15.97	Sq.Mt
4	1.23 X 0.20 X 1 NO	=	0.25	Sq.Mt
5	4.32 X 3.05 X 1 NO	=	13.18	Sq.Mt
6	1.50 X 3.40 X 1 NO	=	5.10	Sq.Mt
7	6.25 X 2.75 X 1 NO	=	17.19	Sq.Mt
8	1.85 X 0.15 X 1 NO	=	0.28	Sq.Mt
9	1.85 X 0.15 X 1 NO	=	0.28	Sq.Mt
TOTAL RERA AREA		=	37.55	Sq.Mt

CARPET AREA CALCULATION (FOR PARKING PURPOSE) FOR 2ND TO 7TH & 11TH FLR. (TOWER-9)

1	0.15 X 1.05 X 1 NO	=	0.16	Sq.Mt
2	0.95 X 1.10 X 1 NO	=	0.96	Sq.Mt
3	4.92 X 3.15 X 1 NO	=	15.50	Sq.Mt
4	1.23 X 0.20 X 1 NO	=	0.25	Sq.Mt
5	4.32 X 3.05 X 1 NO	=	13.18	Sq.Mt
6	1.50 X 3.40 X 1 NO	=	5.10	Sq.Mt
7	6.25 X 2.75 X 1 NO	=	17.19	Sq.Mt
8	1.85 X 0.15 X 1 NO	=	0.28	Sq.Mt
9	1.85 X 0.15 X 1 NO	=	0.28	Sq.Mt
TOTAL RERA AREA		=	36.83	Sq.Mt

CARPET AREA CALCULATION (FOR PARKING PURPOSE) FOR 8TH REFUGE FLOOR (TOWER-9)

1	3.27 X 3.05 X 1 NO	=	9.97	Sq.Mt
2	1.45 X 3.40 X 1 NO	=	4.93	Sq.Mt
3	1.80 X 0.15 X 1 NO	=	0.27	Sq.Mt
4	2.15 X 2.75 X 1 NO	=	5.91	Sq.Mt
5	2.25 X 0.57 X 1 NO	=	1.28	Sq.Mt
6	1.59 X 1.90 X 1 NO	=	3.02	Sq.Mt
7	1.55 X 1.05 X 1 NO	=	1.63	Sq.Mt
TOTAL RERA AREA		=	25.75	Sq.Mt

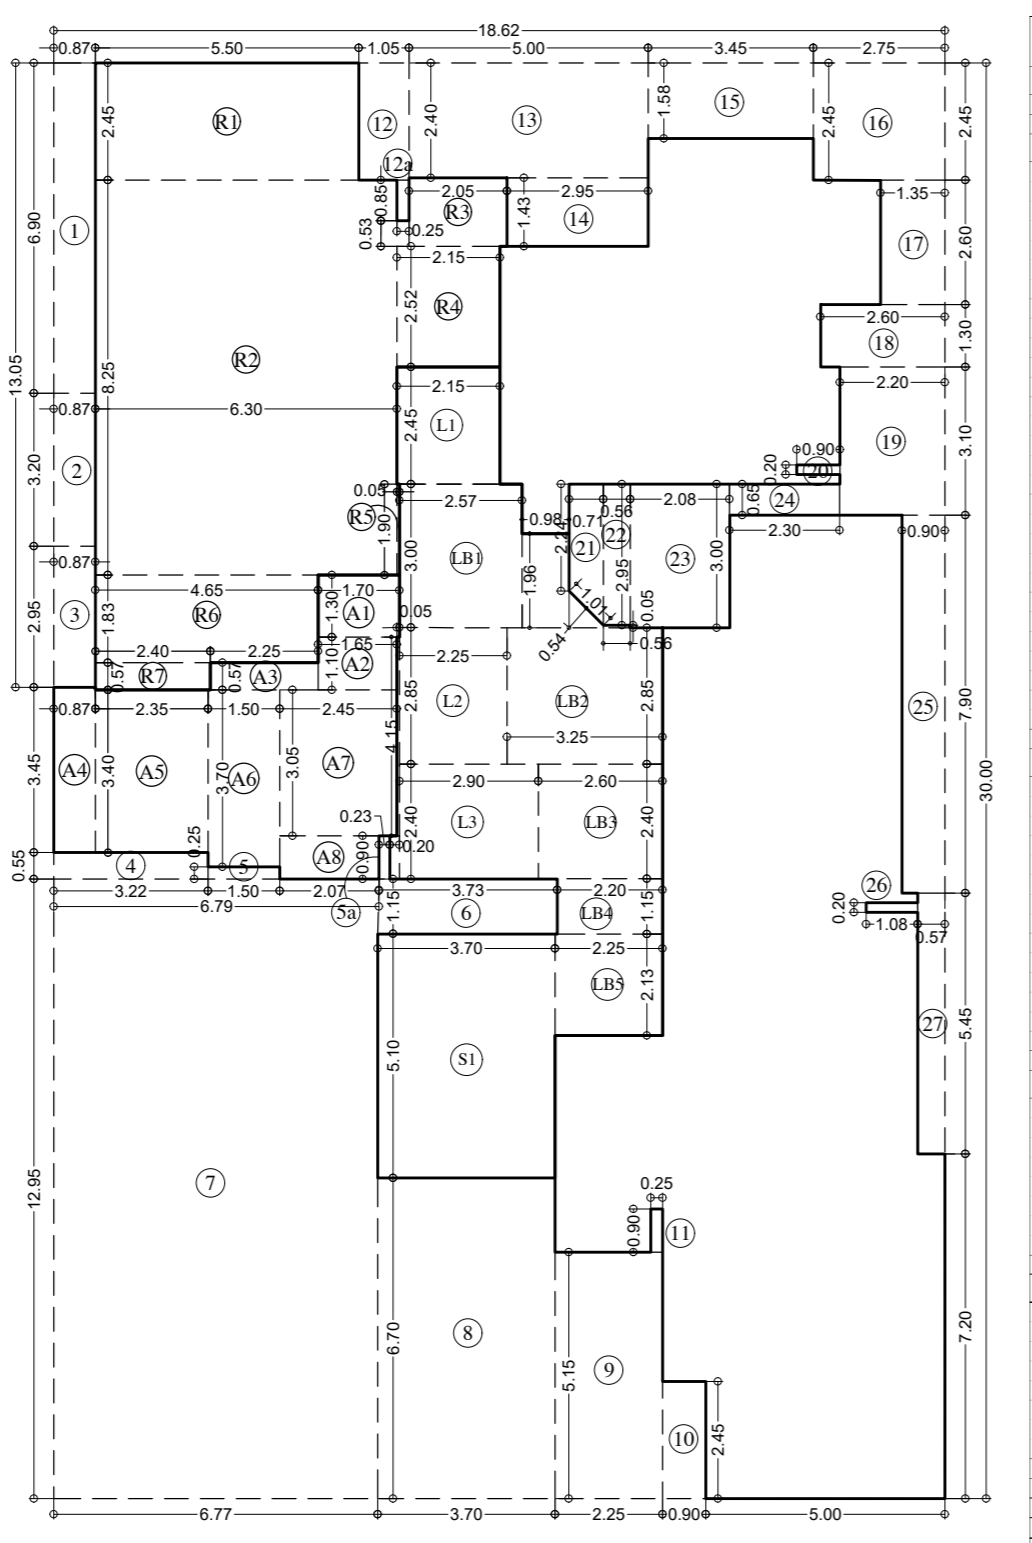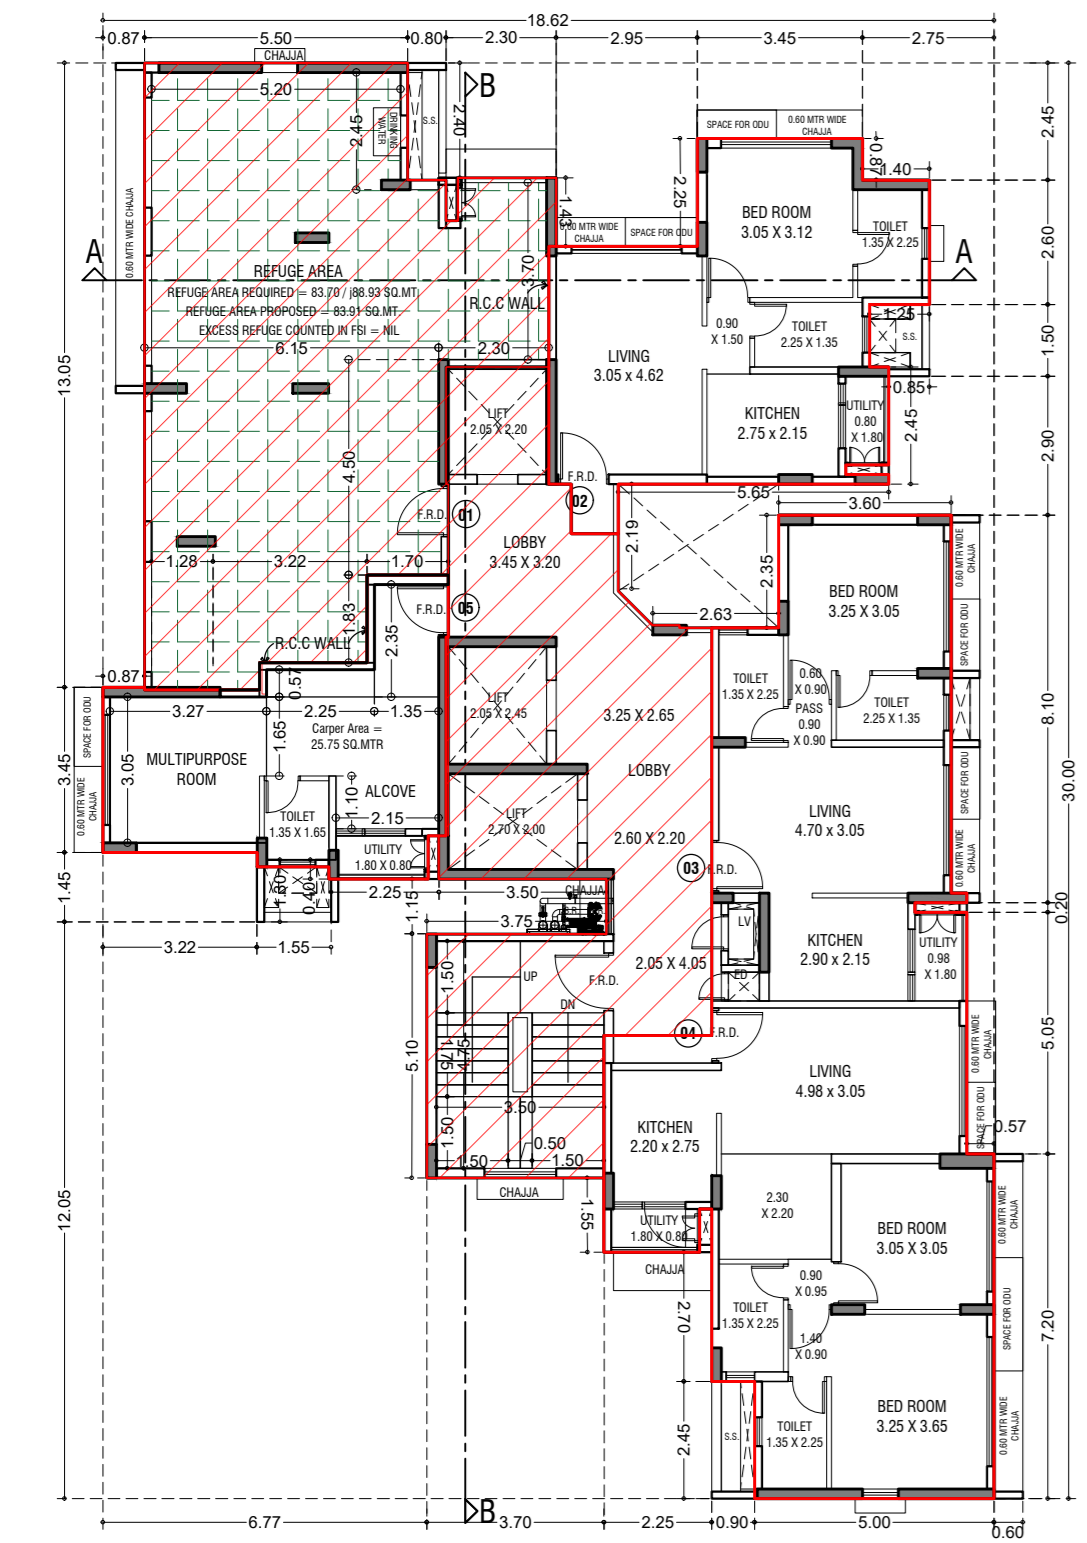

LINE AREA DIAGRAM FOR 8TH REFUGE FLOOR (TOWER-9)

ADDITION (X)

1	18.62 X 30.00 X 1.00 X 1	=	558.60	SQ.MT.
TOTAL		=	558.60	SQ.MT.

STANDARD DEDUCTION (Y1)

1	6.87 X 6.90 X 1.00 X 1	=	6.00	SQ.MT.
2	6.87 X 2.95 X 1.00 X 1	=	2.78	SQ.MT.
3	6.87 X 2.95 X 1.00 X 1	=	2.57	SQ.MT.
4	3.22 X 0.55 X 1.00 X 1	=	1.77	SQ.MT.
5	1.50 X 0.25 X 1.00 X 1	=	0.38	SQ.MT.
6	6.23 X 0.90 X 1.00 X 1	=	0.21	SQ.MT.
7	6.37 X 1.15 X 1.00 X 1	=	4.31	SQ.MT.
8	3.70 X 6.70 X 1.00 X 1	=	24.79	SQ.MT.
9	2.25 X 5.15 X 1.00 X 1	=	11.59	SQ.MT.
10	6.90 X 2.45 X 1.00 X 1	=	2.21	SQ.MT.
11	6.25 X 0.90 X 1.00 X 1	=	0.23	SQ.MT.
12	1.60 X 2.45 X 1.00 X 1	=	1.65	SQ.MT.
13	6.25 X 0.85 X 1.00 X 1	=	0.21	SQ.MT.
14	2.95 X 1.43 X 1.00 X 1	=	4.22	SQ.MT.
15	3.45 X 1.58 X 1.00 X 1	=	5.45	SQ.MT.
16	2.75 X 2.45 X 1.00 X 1	=	6.74	SQ.MT.
17	1.35 X 2.60 X 1.00 X 1	=	3.51	SQ.MT.
18	2.60 X 3.20 X 1.00 X 1	=	3.38	SQ.MT.
19	2.90 X 3.10 X 1.00 X 1	=	6.82	SQ.MT.
20	6.90 X 2.20 X 1.00 X 1	=	0.18	SQ.MT.
21	0.71 X (2.24 + 2.95) X 2.00 X 1	=	1.98	SQ.MT.
22	6.56 X 2.95 X 1.00 X 1	=	1.95	SQ.MT.
23	2.08 X 3.00 X 1.00 X 1	=	6.24	SQ.MT.
24	2.30 X 0.65 X 1.00 X 1	=	1.50	SQ.MT.
25	6.90 X 7.90 X 1.00 X 1	=	7.11	SQ.MT.
26	1.98 X 0.20 X 1.00 X 1	=	0.22	SQ.MT.
27	6.57 X 5.45 X 1.00 X 1	=	1.11	SQ.MT.
TOTAL		=	213.24	SQ.MT.

STAIRCASE, LIFT, LOBBY & PASSAGE DEDUCTION (Y2)

S1	3.70 X 5.10 X 1.00 X 1	=	18.87	SQ.MT.
L1	2.15 X 2.45 X 1.00 X 1	=	5.27	SQ.MT.
L2	2.25 X 2.85 X 1.00 X 1	=	6.41	SQ.MT.
L3	2.90 X 2.40 X 1.00 X 1	=	6.96	SQ.MT.
L4	6.20 X 0.90 X 1.00 X 1	=	0.18	SQ.MT.
L5	2.57 X 3.00 X 1.00 X 1	=	7.71	SQ.MT.
L6	0.98 X 1.96 X 1.00 X 1	=	1.92	SQ.MT.
L7	1.01 X 0.95 X 1.00 X 0.5	=	0.27	SQ.MT.
L8	0.56 X 0.65 X 1.00 X 1	=	0.03	SQ.MT.
L9	3.25 X 2.85 X 1.00 X 1	=	9.26	SQ.MT.
L10	2.60 X 2.40 X 1.00 X 1	=	6.24	SQ.MT.
L11	2.20 X 1.15 X 1.00 X 1	=	2.53	SQ.MT.
L12	2.25 X 2.13 X 1.00 X 1	=	4.79	SQ.MT.
TOTAL		=	78.65	SQ.MT.

MULTIPURPOSE ROOM AREA DEDUCTIONS (Y3)

A1	1.70 X 1.30 X 1.00 X 1	=	2.20	SQ.MT.
A2	1.65 X 1.10 X 1.00 X 1	=	1.82	SQ.MT.
A3	2.25 X 0.57 X 1.00 X 1	=	1.28	SQ.MT.
A4	0.87 X 3.45 X 1.00 X 1	=	3.00	SQ.MT.
A5	2.35 X 2.40 X 1.00 X 1	=	5.64	SQ.MT.
A6	1.50 X 3.70 X 1.00 X 1	=	5.55	SQ.MT.
A7	2.45 X 3.05 X 1.00 X 1	=	7.47	SQ.MT.
A8	2.07 X 0.90 X 1.00 X 1	=	1.86	SQ.MT.
TOTAL		=	31.17	SQ.MT.

REFUGE AREA DEDUCTIONS (Y4)





R1	5.50 X 2.45 X 1.00 X 1	=	13.48	SQ.MT.
R2	6.30 X 6.25 X 1.00 X 1	=	51.98	SQ.MT.
R3	2.95 X 1.43 X 1.00 X 1	=	2.99	SQ.MT.
R4	6.25 X 0.53 X 1.00 X 1	=	0.14	SQ.MT.
R5	2.15 X 2.52 X 1.00 X 1	=	5.42	SQ.MT.
R6	6.05 X 1.90 X 1.00 X 1	=	0.10	SQ.MT.
R7	4.60 X 1.83 X 1.00 X 1	=	8.51	SQ.MT.
R8	2.40 X 0.57 X 1.00 X 1	=	1.37	SQ.MT.
TOTAL		=	83.91	SQ.MT.

TOTAL DEDUCTIONS (Y1+Y2+Y3+Y4)

TOTAL BUILT UP AREA (X-Y)

TOTAL REFUGE AREA (Y1+Y2+Y3+Y4)

TOTAL BUILT UP AREA (Y1+Y2+Y3+Y4)

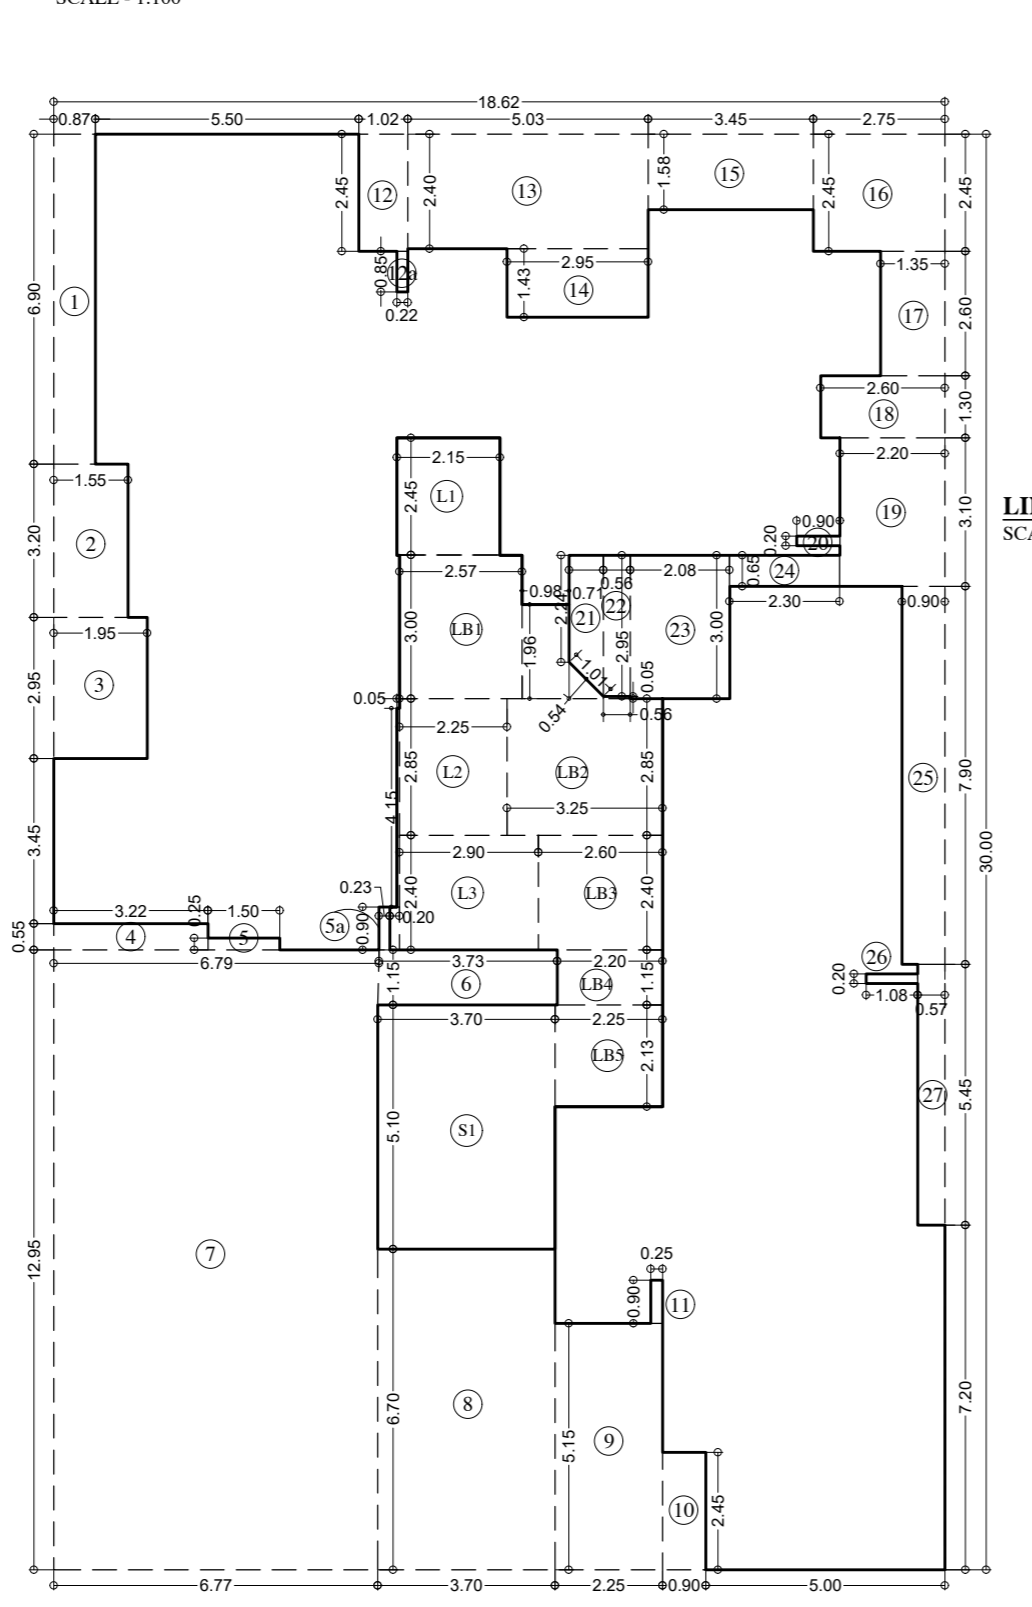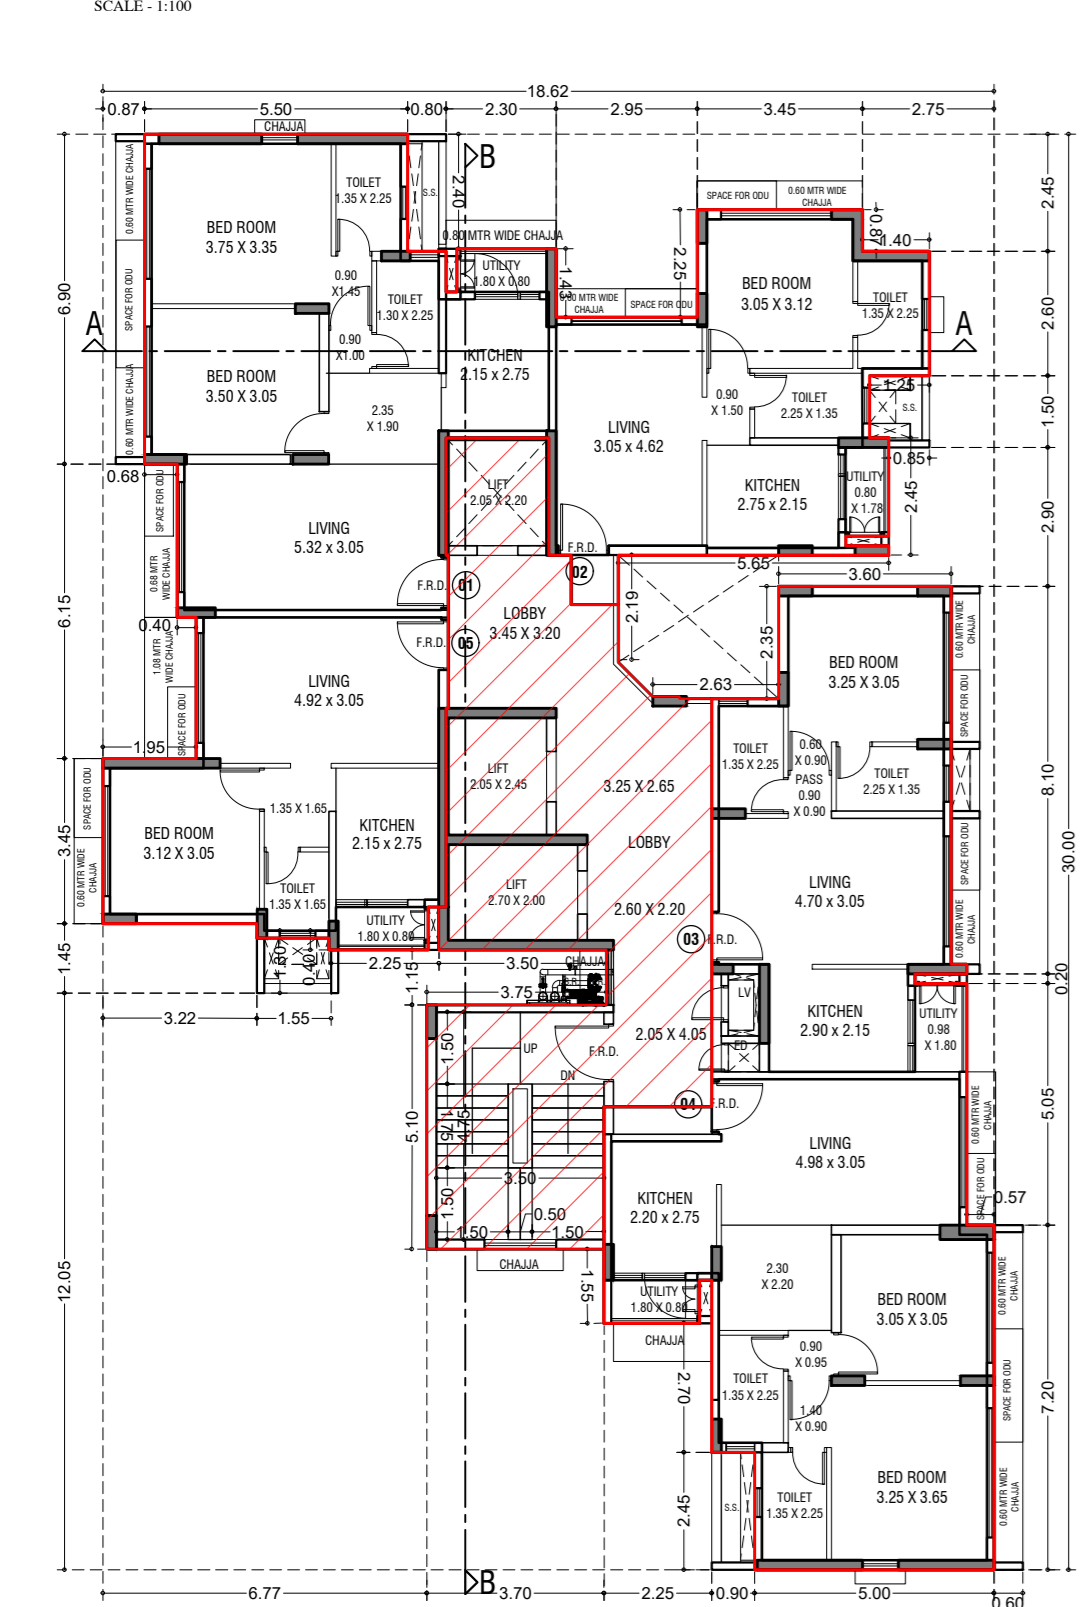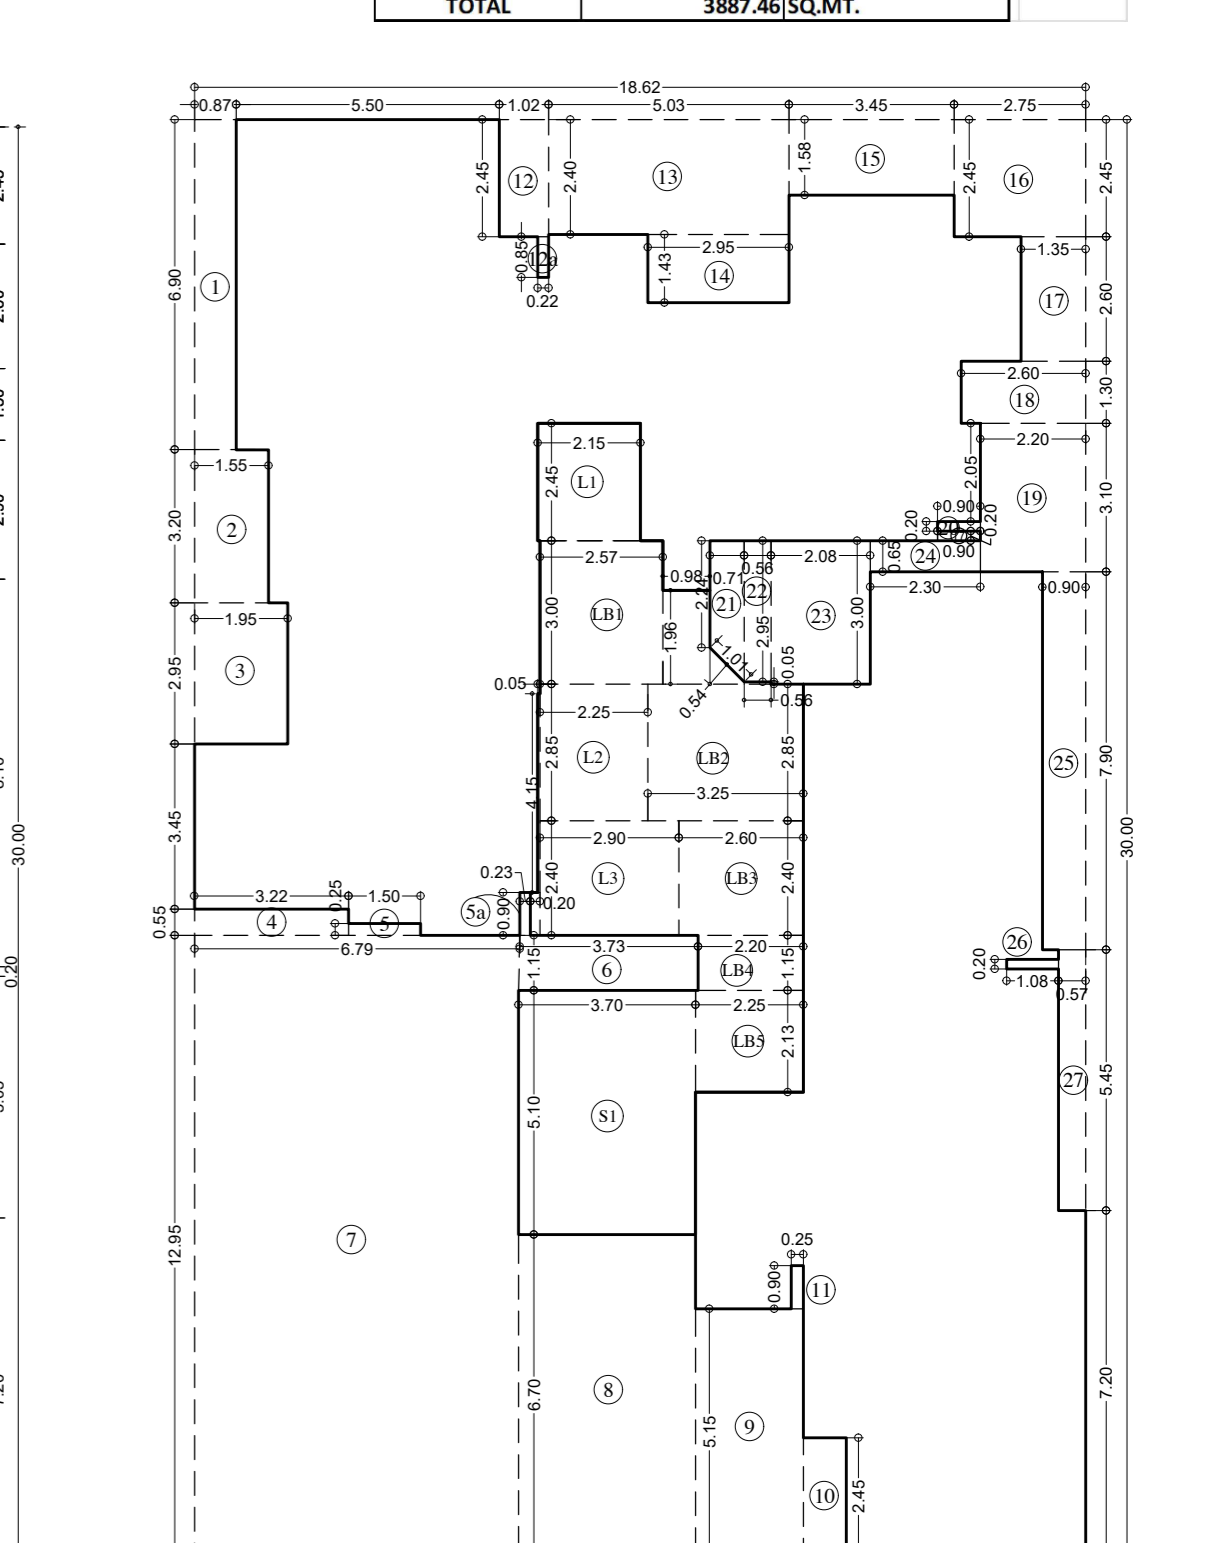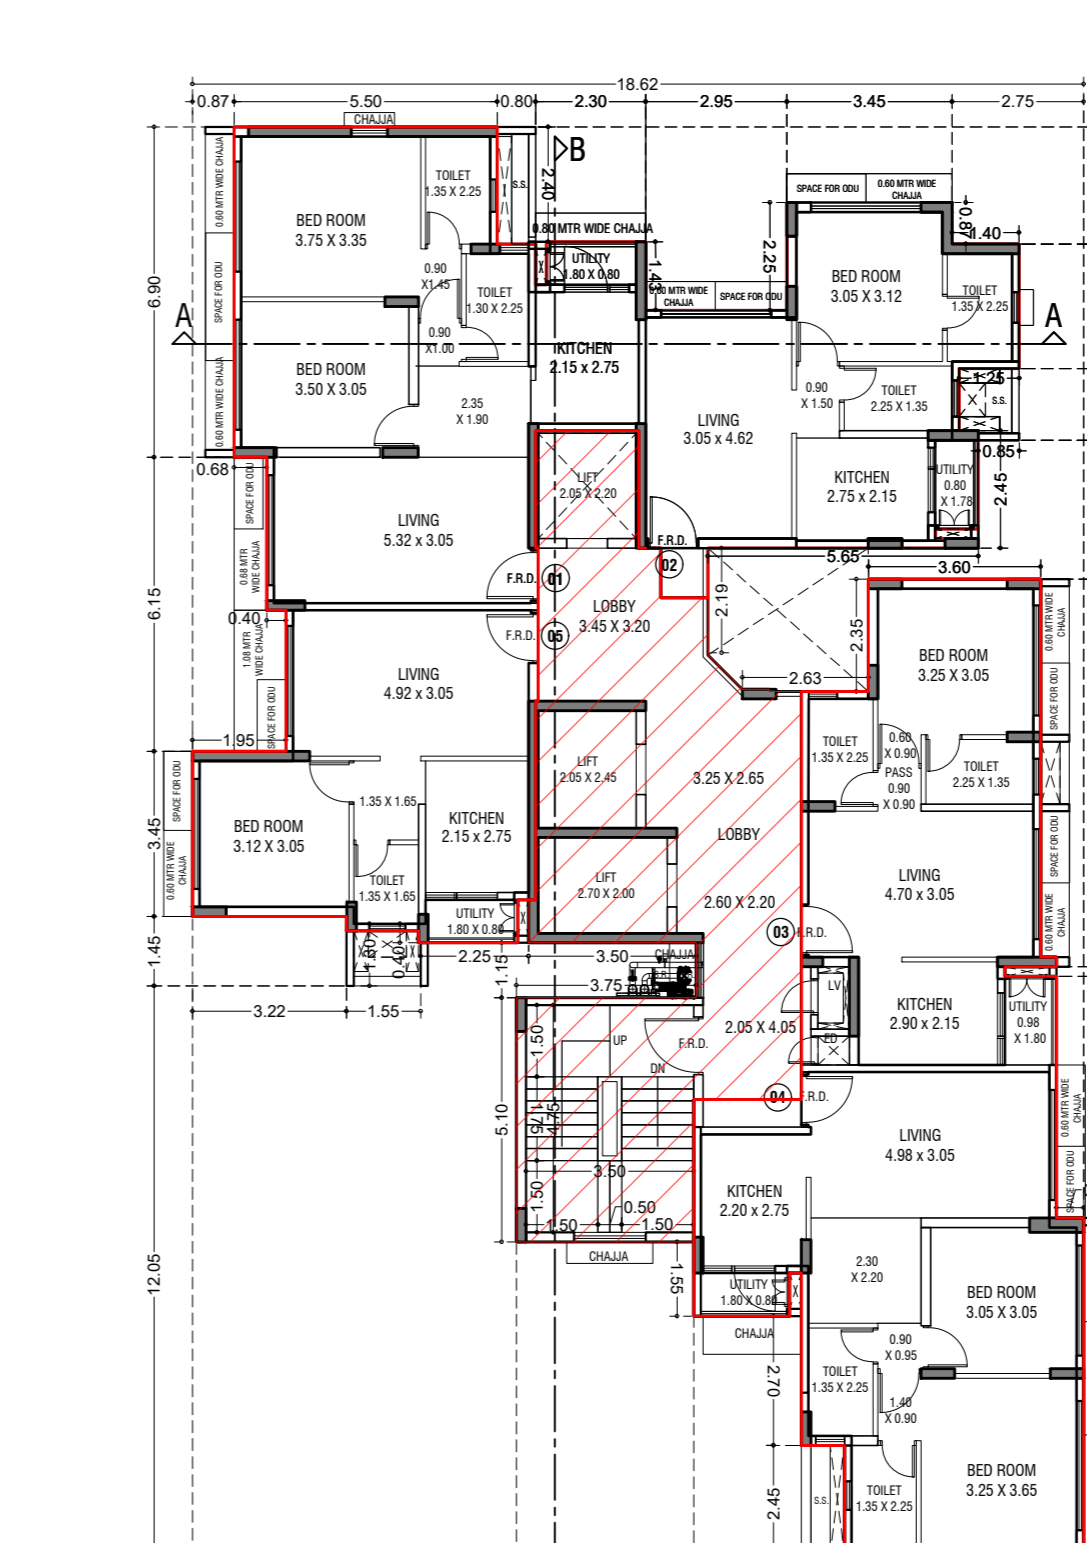

LINE AREA DIAGRAM FOR LIFT VOID AREA 12TH TO 15TH FLOOR

ADDITION (X)

1	2.05 X 2.20 X 1 NO	=	4.51	SQ.MT.
2	2.05 X 2.45 X 1 NO	=	5.02	SQ.MT.
3	2.70 X 2.00 X 1 NO	=	5.40	SQ.MT.
TOTAL ADDITION		=	14.93	SQ.MT.

LINE AREA DIAGRAM FOR 4TH TO 7TH & 9TH TO 14TH TYPICAL FLOOR (TOWER-9)

ADDITION (X)

1	18.62 X 30.00 X 1.00 X 1	=	558.60	SQ.MT.
TOTAL		=	558.60	SQ.MT.


STANDARD DEDUCTION (Y1)

1	1.55 X 3.20 X 1.00 X 1	=	4.96	SQ.MT.
2	1.95 X 2.95 X 1.00 X 1	=	5.75	SQ.MT.
3	0.95 X 4.15 X 1.00 X 1	=	3.98	SQ.MT.
4	1.50 X 0.25 X 1.00 X 1	=	0.38	SQ.MT.
5	6.23 X 0.90 X 1.00 X 1	=	0.21	SQ.MT.
6	6.37 X 1.15 X 1.00 X 1	=	4.31	SQ.MT.
7	3.70 X 6.70 X 1.00 X 1	=	24.79	SQ.MT.
8	2.25 X 5.15 X 1.00 X 1	=	11.59	SQ.MT.
9	6.90 X 2.45 X 1.00 X 1	=	2.21	SQ.MT.
10	6.25 X 0.90 X 1.00 X 1	=	0.23	SQ.MT.
11	1.60 X 2.45 X 1.00 X 1	=	1.65	SQ.MT.
12	6.25 X 0.85 X 1.00 X 1	=	0.19	SQ.MT.
13	2.95 X 1.43 X 1.00 X 1	=	4.22	SQ.MT.
14	3.45 X 1.58 X 1.00 X 1	=	5.45	SQ.MT.
15	2.75 X 2.45 X 1.00 X 1	=	6.74	SQ.MT.
16	1.35 X 2.60 X 1.00 X 1	=	3.51	SQ.MT.
17	2.60 X 3.20 X 1.00 X 1	=	3.38	SQ.MT.
18	2.90 X 3.10 X 1.00 X 1	=	6.82	SQ.MT.
19	2.90 X 3.10 X 1.00 X 1	=	6.82	SQ.MT.
20	6.90 X 2.20 X 1.00 X 1	=	0.18	SQ.MT.
21	0.71 X (2.24 + 2.95) X 2.00 X 1	=	1.98	SQ.MT.
22	6.56 X 2.95 X 1.00 X 1	=	1.95	SQ.MT.
23	2.08 X 3.00 X 1.00 X 1	=	6.24	SQ.MT.
24	2.30 X 0.65 X 1.00 X 1	=	1.50	SQ.MT.
25	6.90 X 7.90 X 1.00 X 1	=	7.11	SQ.MT.
26	1.98 X 0.20 X 1.00 X 1	=	0.22	SQ.MT.
27	6.57 X 5.45 X 1.00 X 1	=	1.11	SQ.MT.
TOTAL		=	213.24	SQ.MT.


STAIRCASE

CONTENTS OF SHEET

TOWER 1
SECTION - AA & BB

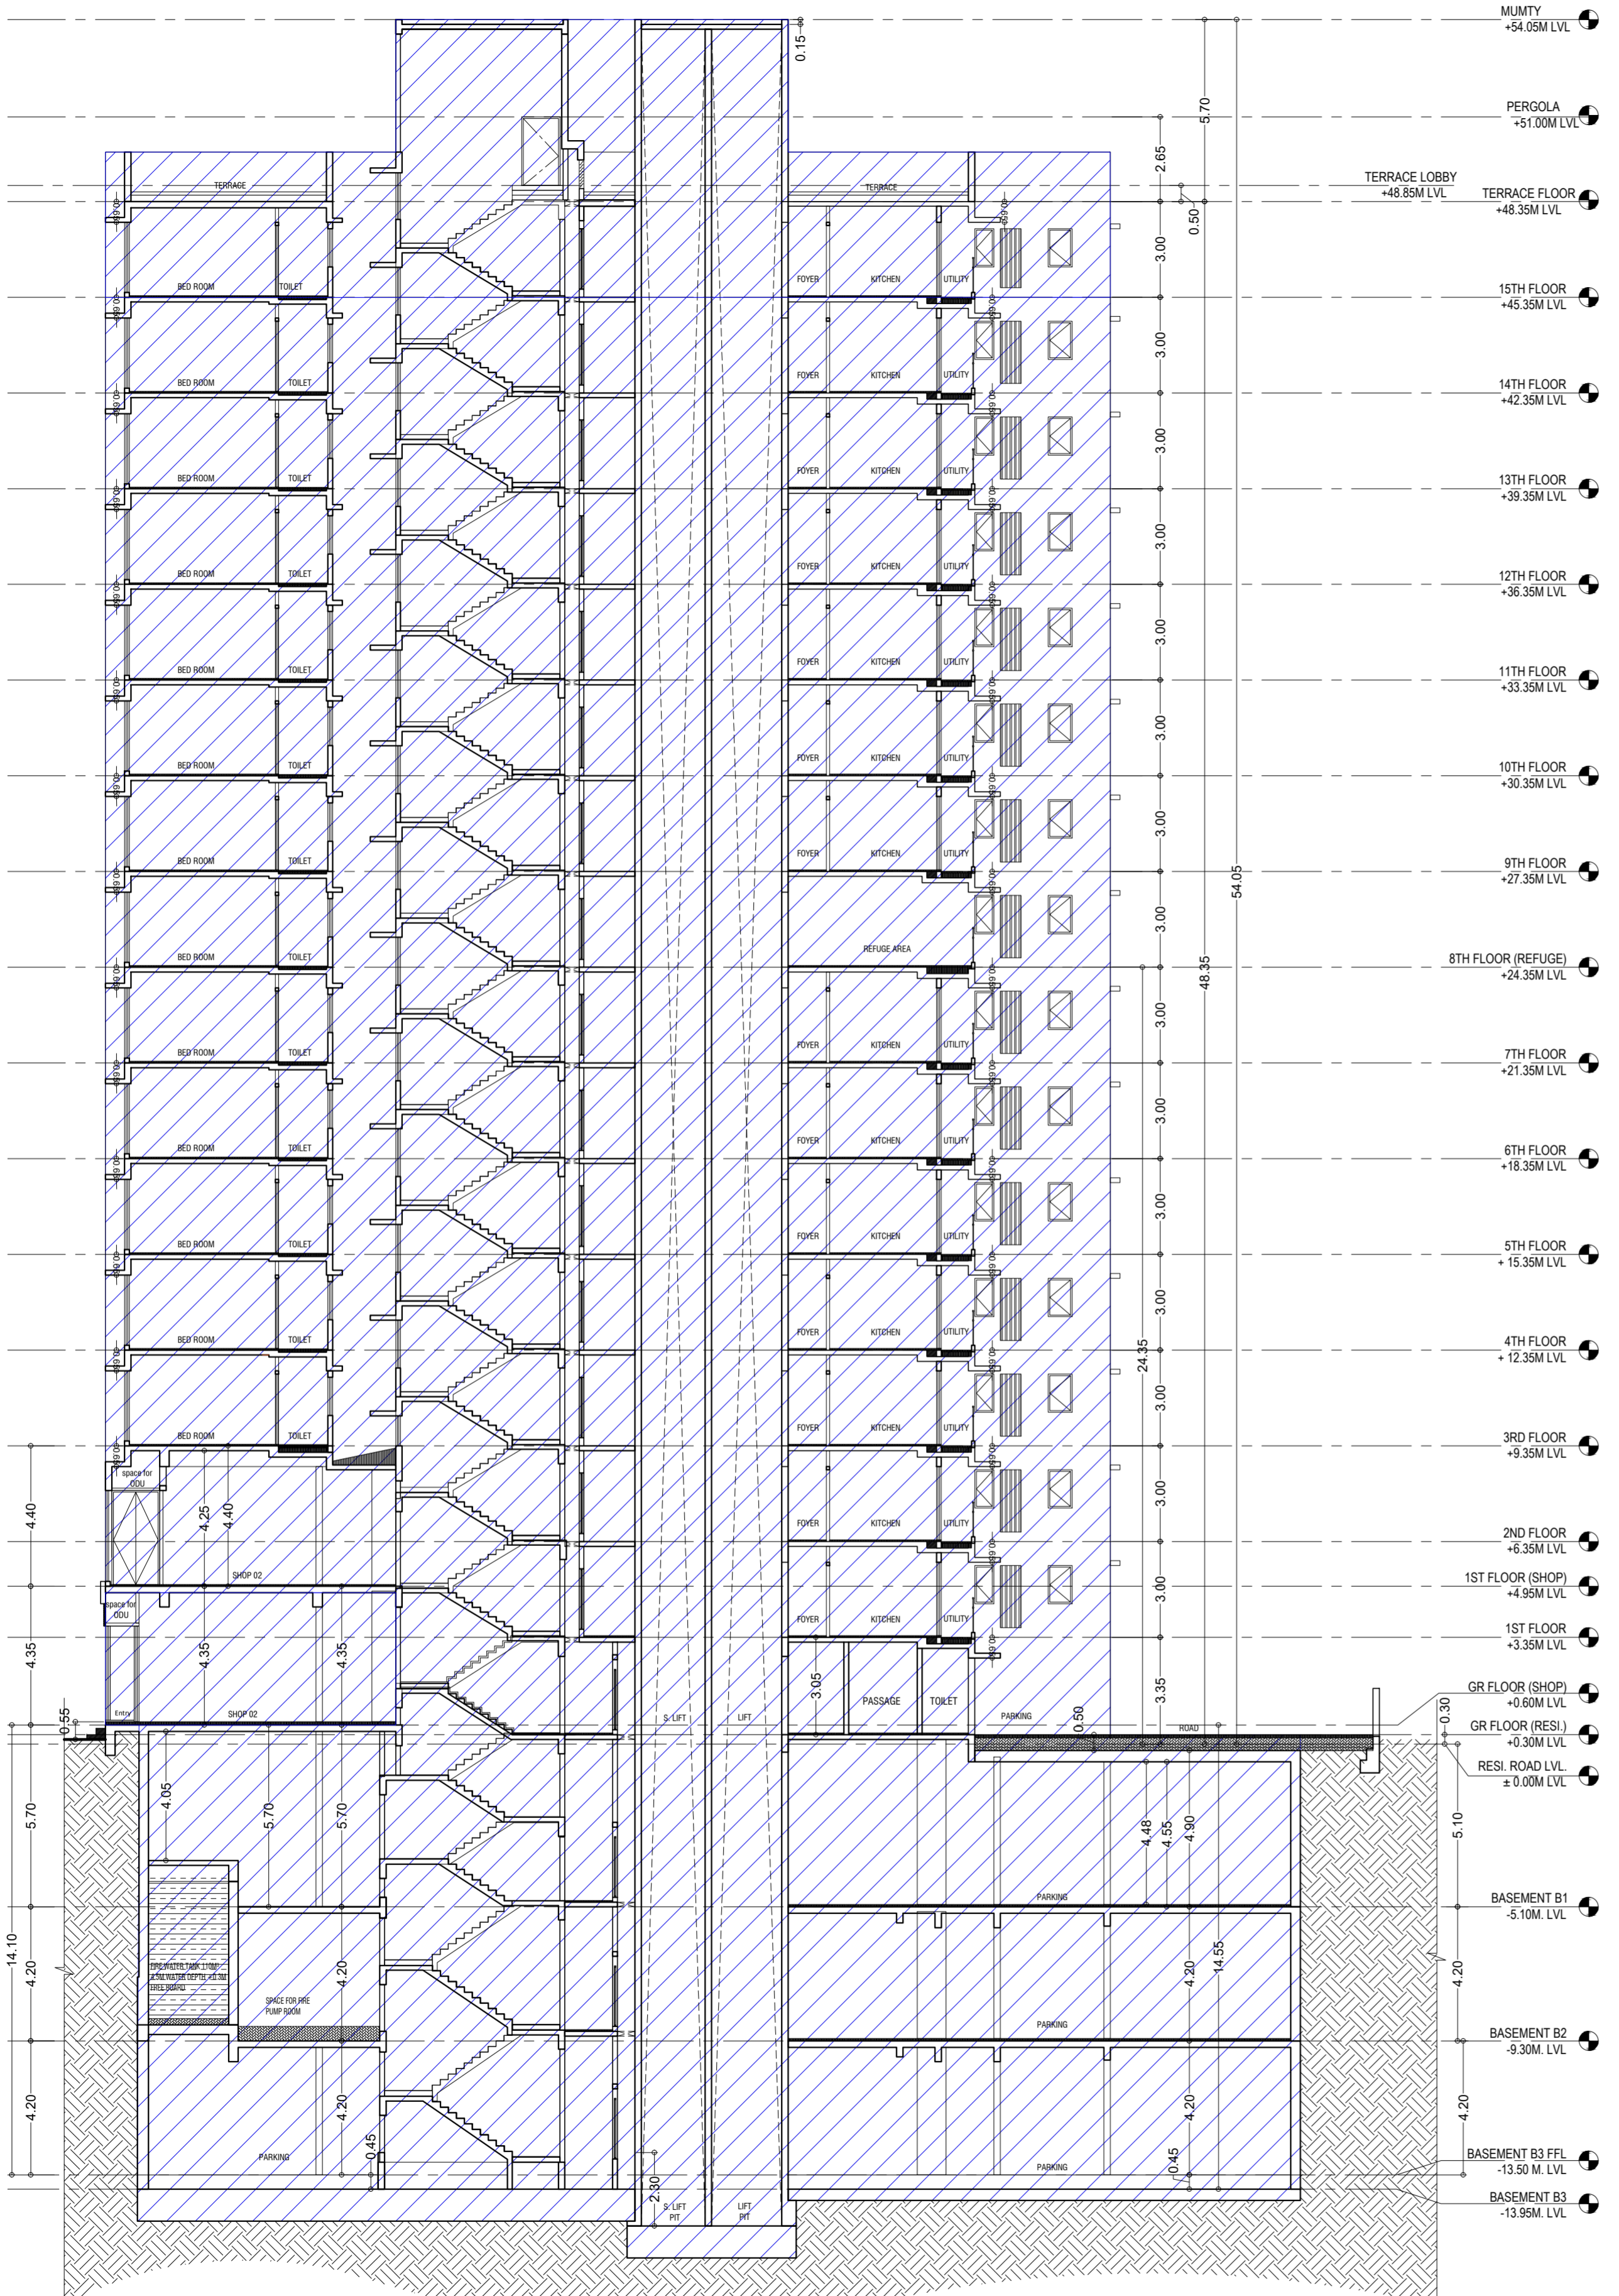

SECTION AA
(Tower-1)

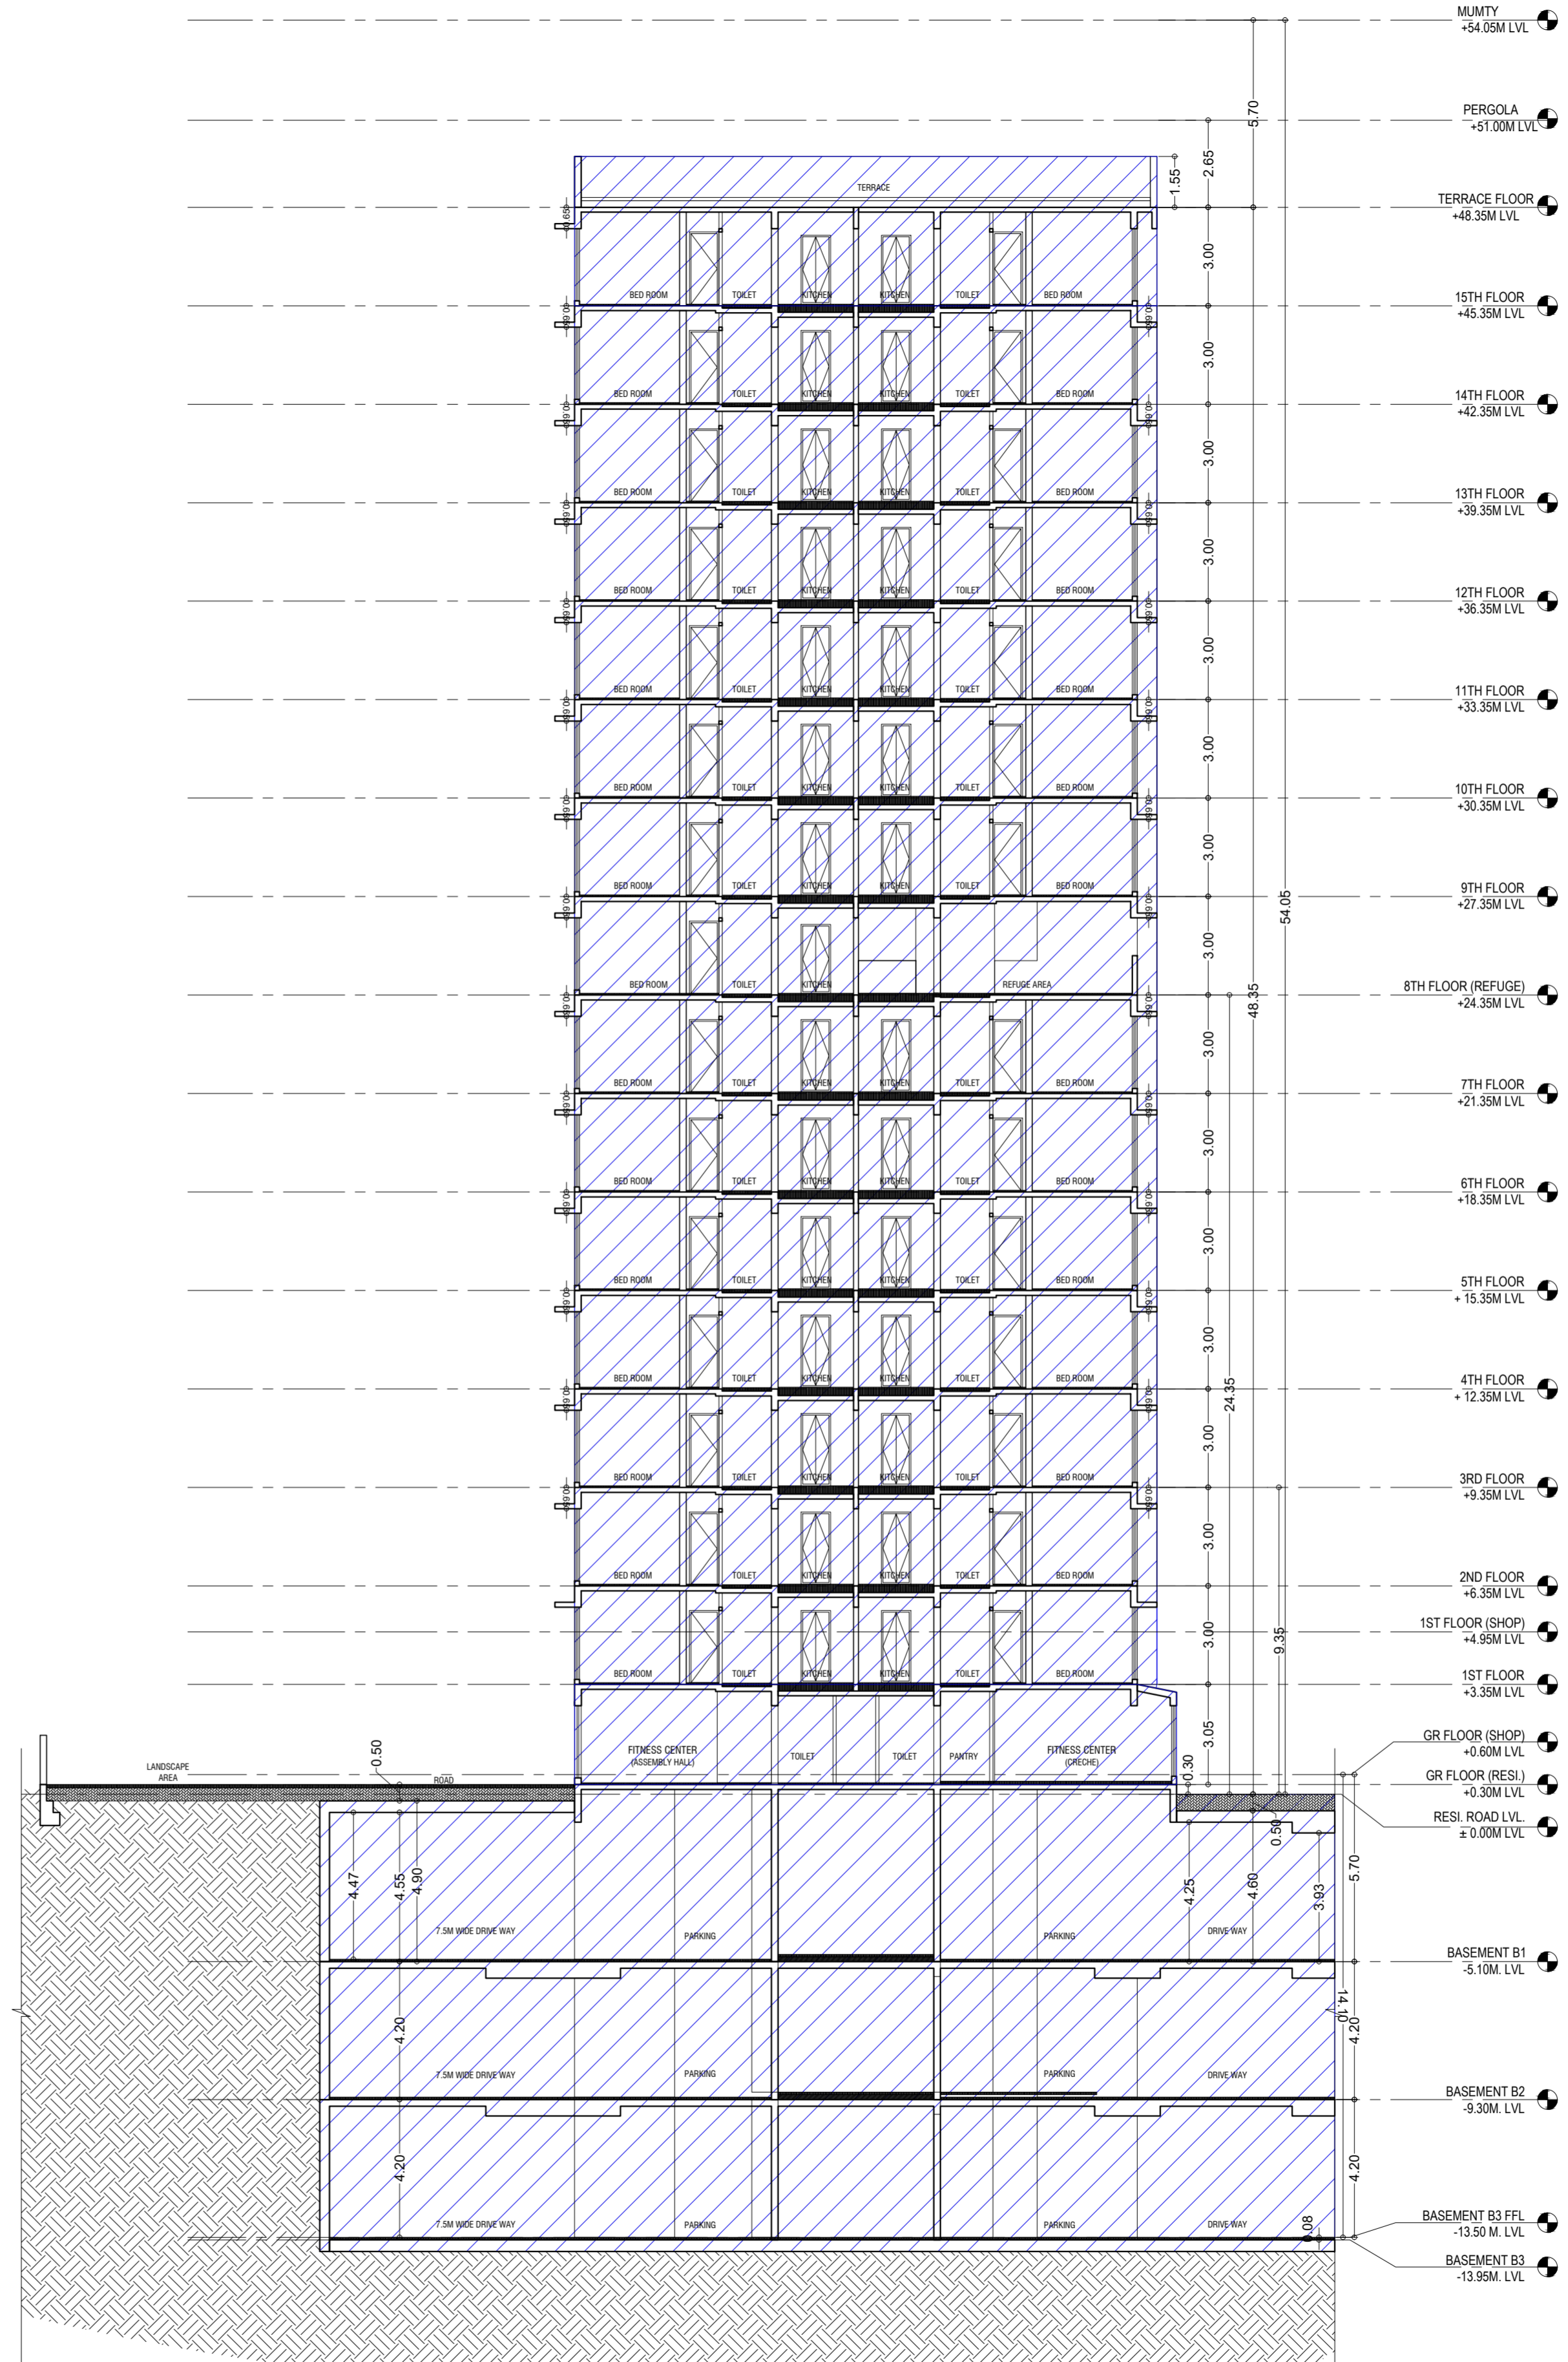

SECTION BB
(Tower-1)

LEGENDS:-
AREA SHOWN FOR OC OBTAINED

STAMP AND DATE OF APPROVAL OF PLAN
THIS CANCELS APPROVAL TO PREVIOUS PLANS SANCTION UNDER NO. P-5303/2020/(24 And Other)/L. Ward/CHANDIVALI/337/10/Amended dtd. 25.06.2024

APPROVED SUBJECT TO THE CONDITIONS MENTIONED IN THIS OFFICE LETTER NO. P-5303/2020/(24 And Other)/L. Ward/CHANDIVALI/337/10/AMENDED

S.E.(B.P) N	A.E.(B.P) 'L' WARD	E.E. (B.P) ES-1
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DESCRIPTION OF PROPOSAL & PROPERTY
PROPOSED DEVELOPMENT ON PLOT BEARING C.T.S. NO. 24/A TO 24/E & OLD CTS NO. 24/1, 24/2 & 24/3 OF VILLAGE CHANDIVALI, CHANDIVALI ROAD, 'L' WARD, MUMBAI.

NORTH	JOB. NO.	DRG. NO.	DRAWN BY
	525	16/23	-
	SCALE	DATE	CHECKED BY
	1:200	-	-

REVISIONS DESCRIPTION :

NAME AND ADDRESS OF DESIGN ARCHITECT
EDIFICE CONSULTANTS PVT. LTD.



FIRST FLOOR PLOT #2A WJAGAR INFOTECH PARK, OPPOSITE DEONAR BUS DEPOT SUNDER BAUG, GOVANDI EAST, MUMBAI, MAHARASHTRA 400088

NAME OF THE OWNER
M/S. GODREJ PROPERTIES. LTD.

AUTHORIZED SIGNATORY
NAME AND ADDRESS OF LICENSED SURVEYOR (L.S)

SIGNATURE

CONTENTS OF SHEET
TOWER 2
SECTION - AA & BB

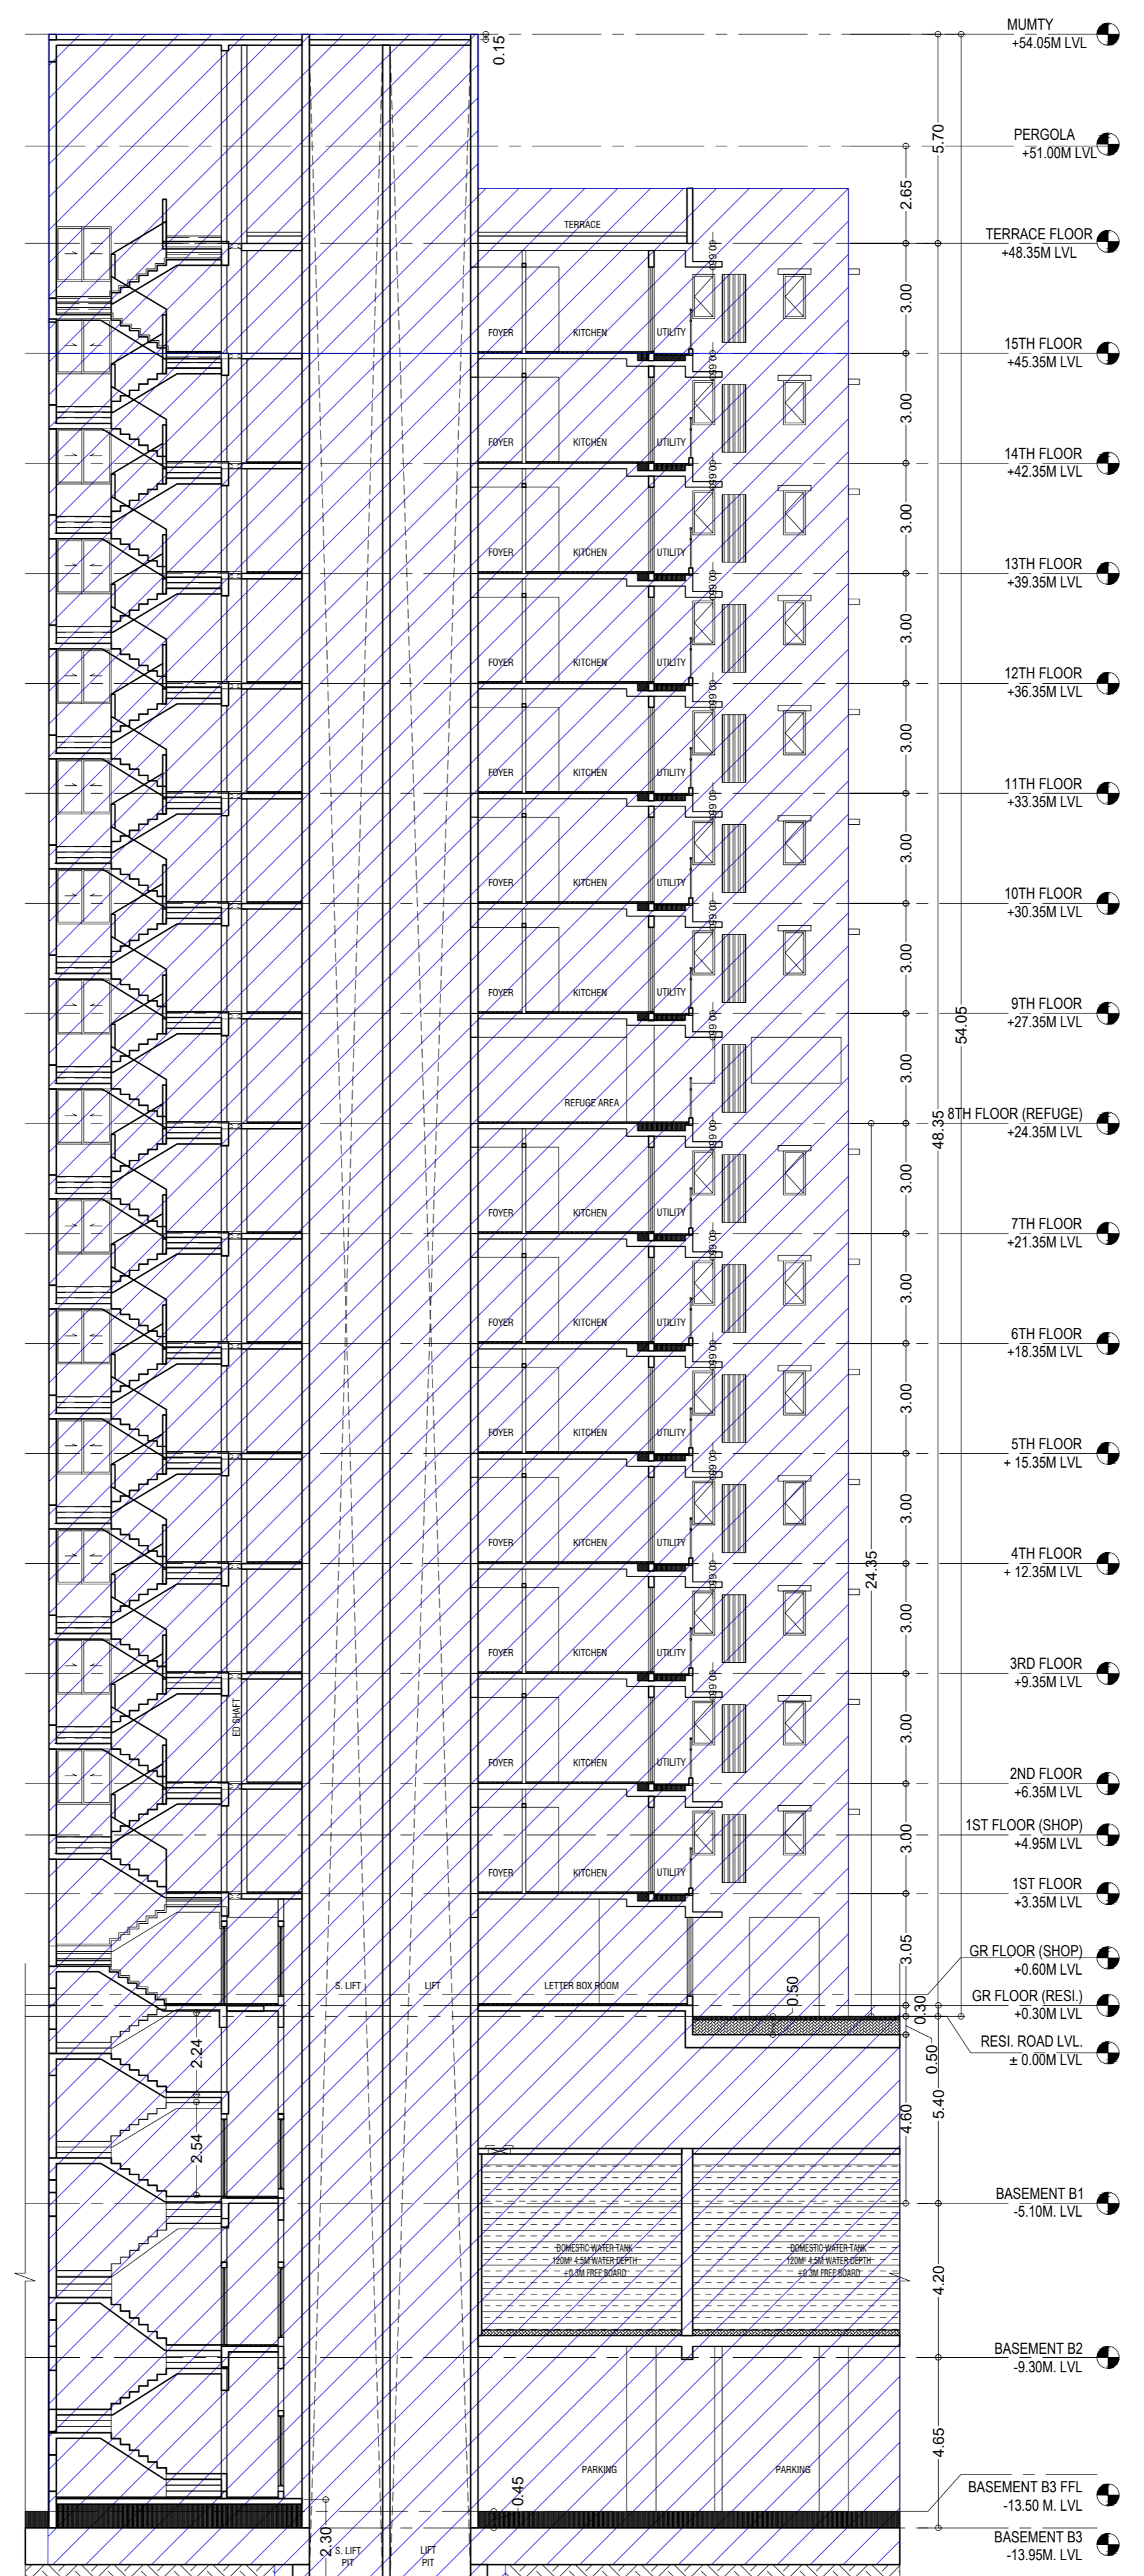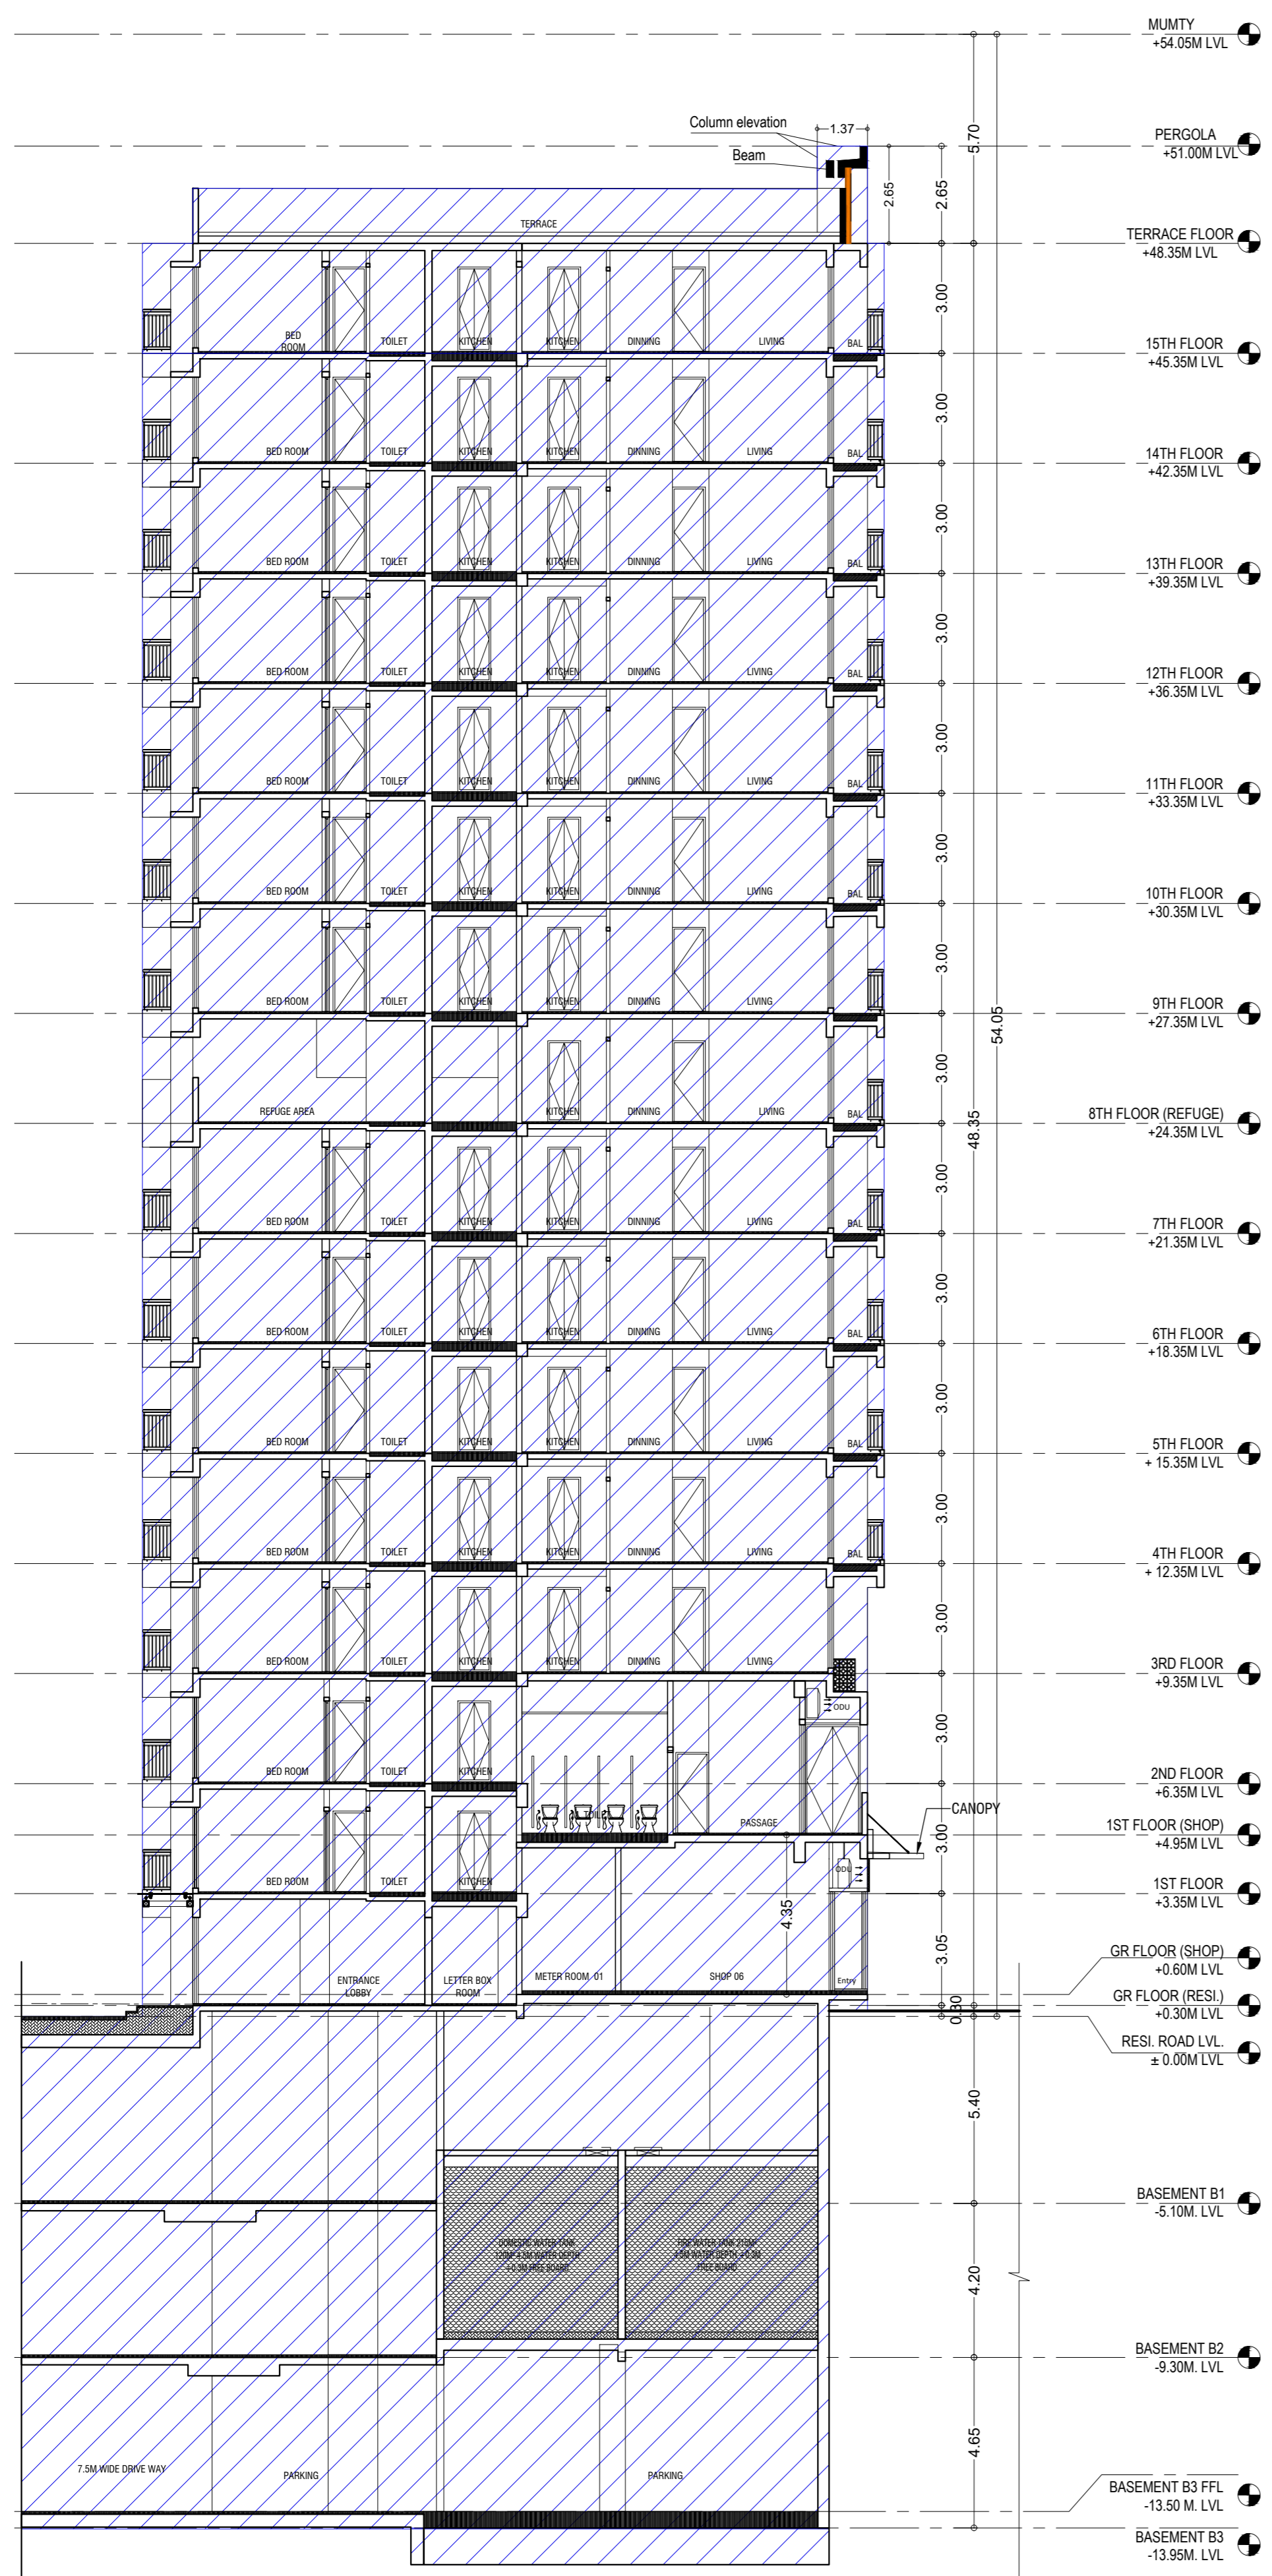

SECTION AA
(Tower-2)

SECTION BB
(Tower-2)

LEGENDS:-
 AREA SHOWN FOR OC OBTAINED

STAMP AND DATE OF APPROVAL OF PLAN
 THIS CANCELS APPROVAL TO PREVIOUS PLANS SANCTION UNDER NO. P-5303/2020/(. 24 And Other)/L Ward/CHANDIVALI/337/10/Amended dtd. 25.06.2024

APPROVED SUBJECT TO THE CONDITIONS MENTIONED IN THIS OFFICE LETTER NO. P-5303/2020/(. 24 And Other)/L Ward/CHANDIVALI/337/11/AMENDED

S.E.(B.P) N	A.E.(B.P) 'L' WARD	E.E. (B.P.) ES-1
-------------	--------------------	------------------

DESCRIPTION OF PROPOSAL & PROPERTY
 PROPOSED DEVELOPMENT ON PLOT BEARING C.T.S. NO. 24/A TO 24/E & OLD CTS NO. 24/1, 24/2 & 24/3 OF VILLAGE CHANDIVALI, CHANDIVALI ROAD, 'L' WARD, MUMBAI.

NORTH	JOB. NO.	DRG. NO.	DRAWN BY
	525	17/23	-
	SCALE	DATE	CHECKED BY
	1:200	-	-

REVISIONS	DESCRIPTION :
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NAME AND ADDRESS OF DESIGN ARCHITECT
 EDIFICE CONSULTANTS PVT. LTD.


FIRST FLOOR PLOT #2A UJAGAR INFOTECH PARK, OPPOSITE DEONAR BUS DEPOT SUNDER BAUG, GOVANDI EAST, MUMBAI, MAHARASHTRA 400088

NAME OF THE OWNER
 M/S. GODREJ PROPERTIES. LTD.


AUTHORIZED SIGNATORY
 NAME AND ADDRESS OF LICENSED SURVEYOR (L.S)

SIGNATURE

CONTENTS OF SHEET
TOWER 3
SECTION - AA & BB

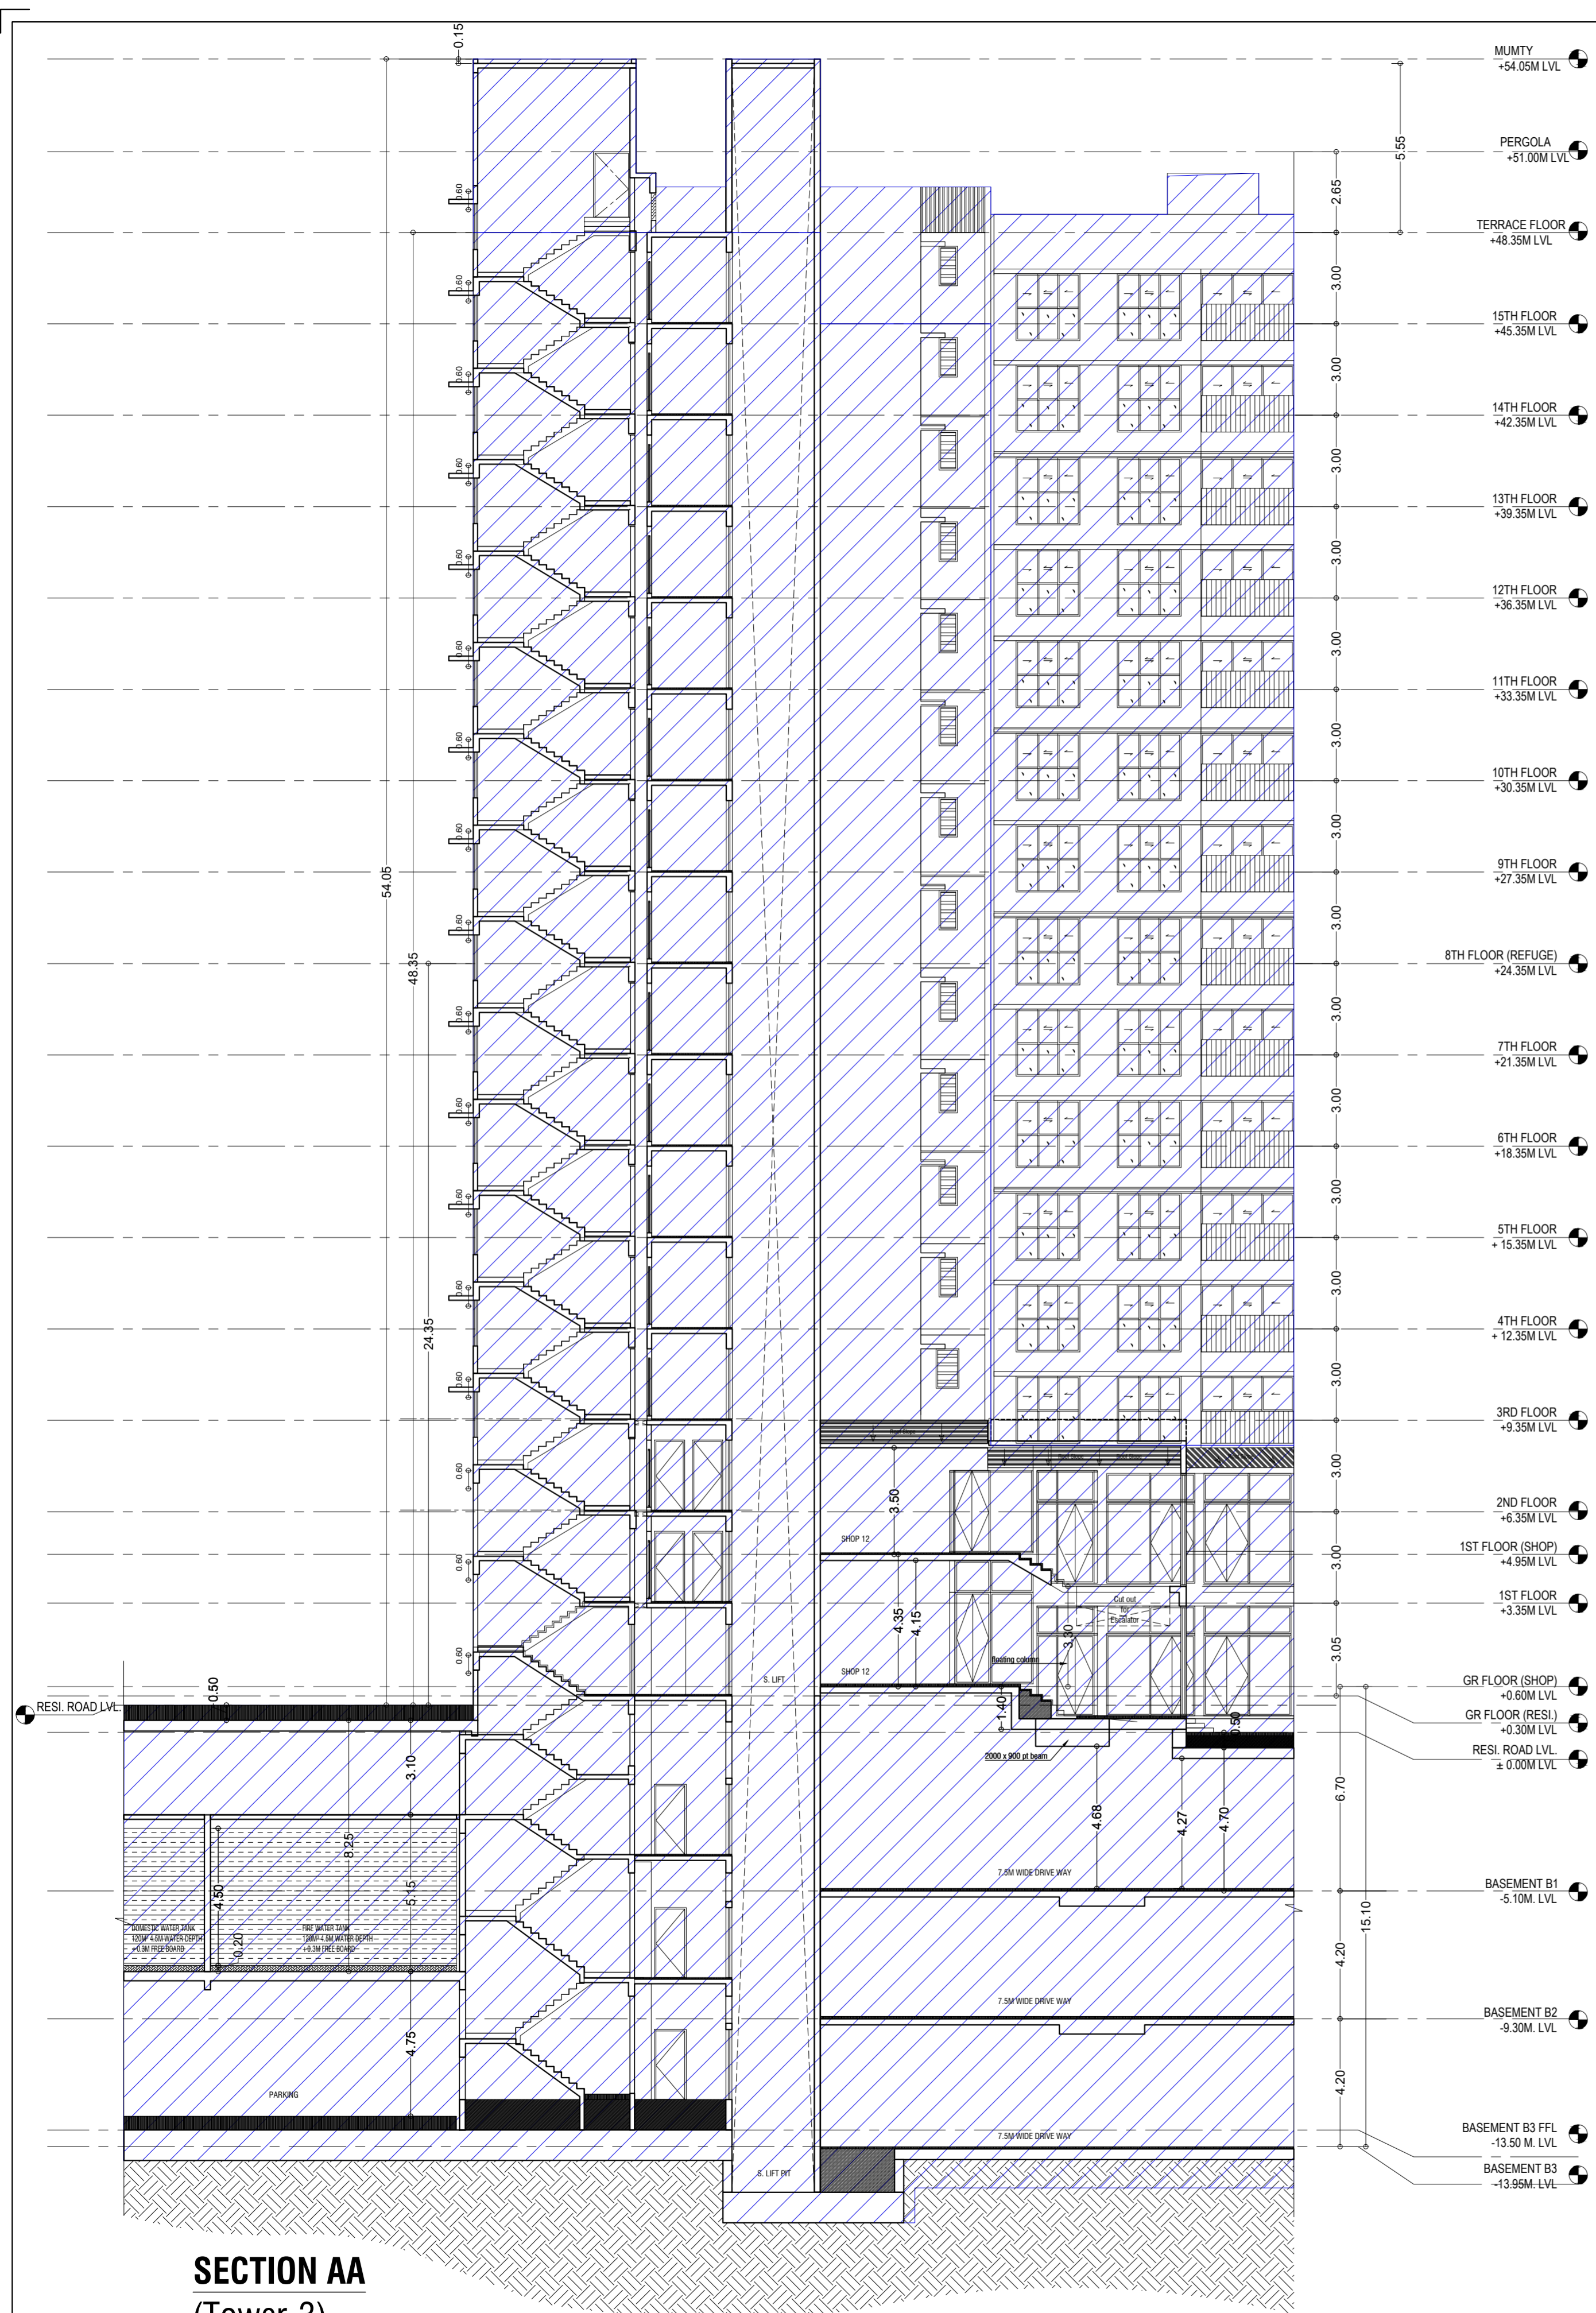

SECTION AA
(Tower-3)

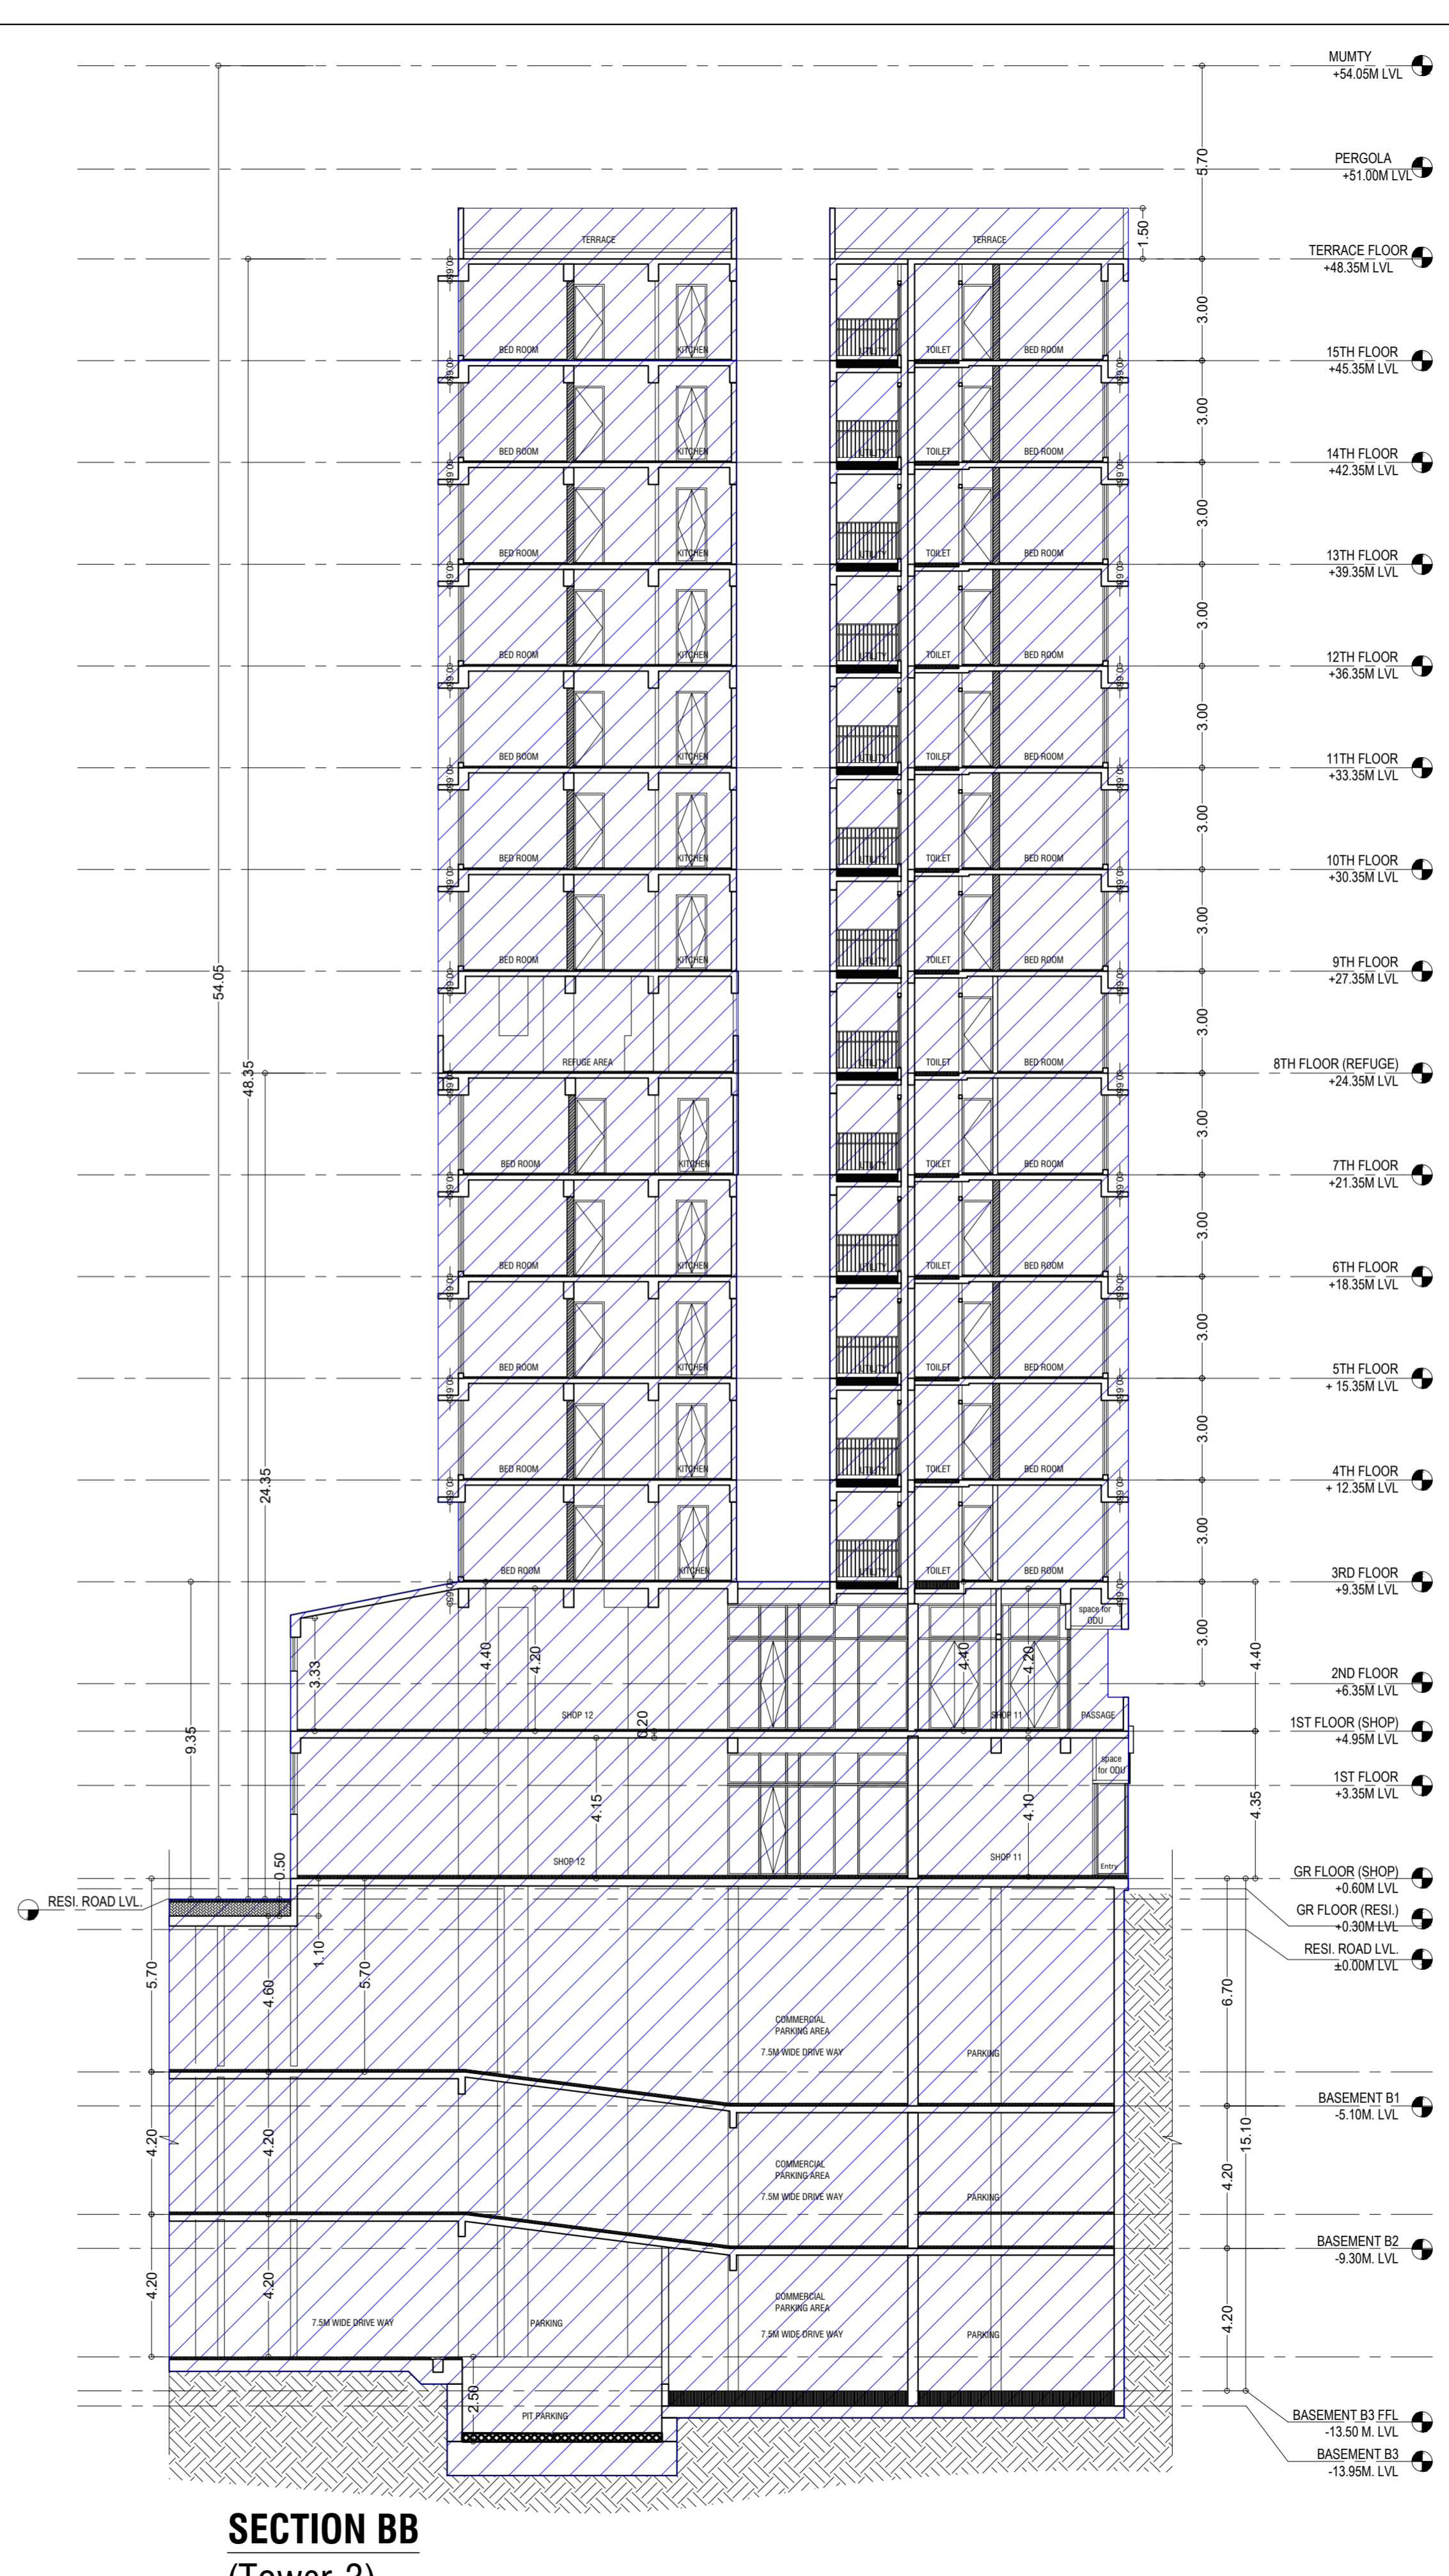

SECTION BB
(Tower-3)

LEGENDS:-
 AREA SHOWN FOR OC OBTAINED

STAMP AND DATE OF APPROVAL OF PLAN
 THIS CANCELS APPROVAL TO PREVIOUS PLANS SANCTION UNDER NO. P-5303/2020/ 24 And Other/L Ward/CHANDIVALI/337/10/Amended dtd. 25.06.2024

APPROVED SUBJECT TO THE CONDITIONS MENTIONED IN THIS OFFICE LETTER NO. P-5303/2020/ 24 And Other/L Ward/CHANDIVALI/337/11/AMENDED

S.E.(B.P) N	A.E.(B.P) 'L' WARD	E.E. (B.P.) ES-1
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DESCRIPTION OF PROPOSAL & PROPERTY
 PROPOSED DEVELOPMENT ON PLOT BEARING C.T.S. NO. 24/A TO 24/E & OLD CTS NO. 24/1, 24/2 & 24/3 OF VILLAGE CHANDIVALI, CHANDIVALI ROAD, 'L' WARD, MUMBAI.

NORTH	JOB. NO.	DRG. NO.	DRAWN BY
	525	18/23	-
	SCALE	DATE	CHECKED BY
	1:200	-	-

REVISIONS DESCRIPTION :

NAME AND ADDRESS OF DESIGN ARCHITECT
 EDIFICE CONSULTANTS PVT. LTD.

NAME OF THE OWNER
 M/S. GODREJ PROPERTIES. LTD.


AUTHORIZED SIGNATORY
 NAME AND ADDRESS OF LICENSED SURVEYOR (L.S)

SIGNATURE


SIGNATURE

SPACE AGE CONSULTANTS
 B-106, Natraj Building,
 Mulund Goregaon Link Road
 Mulund (w), Mumbai : 4000 080


CONTENTS OF SHEET
TOWER 4 & 5
SECTION - AA, BB & CC

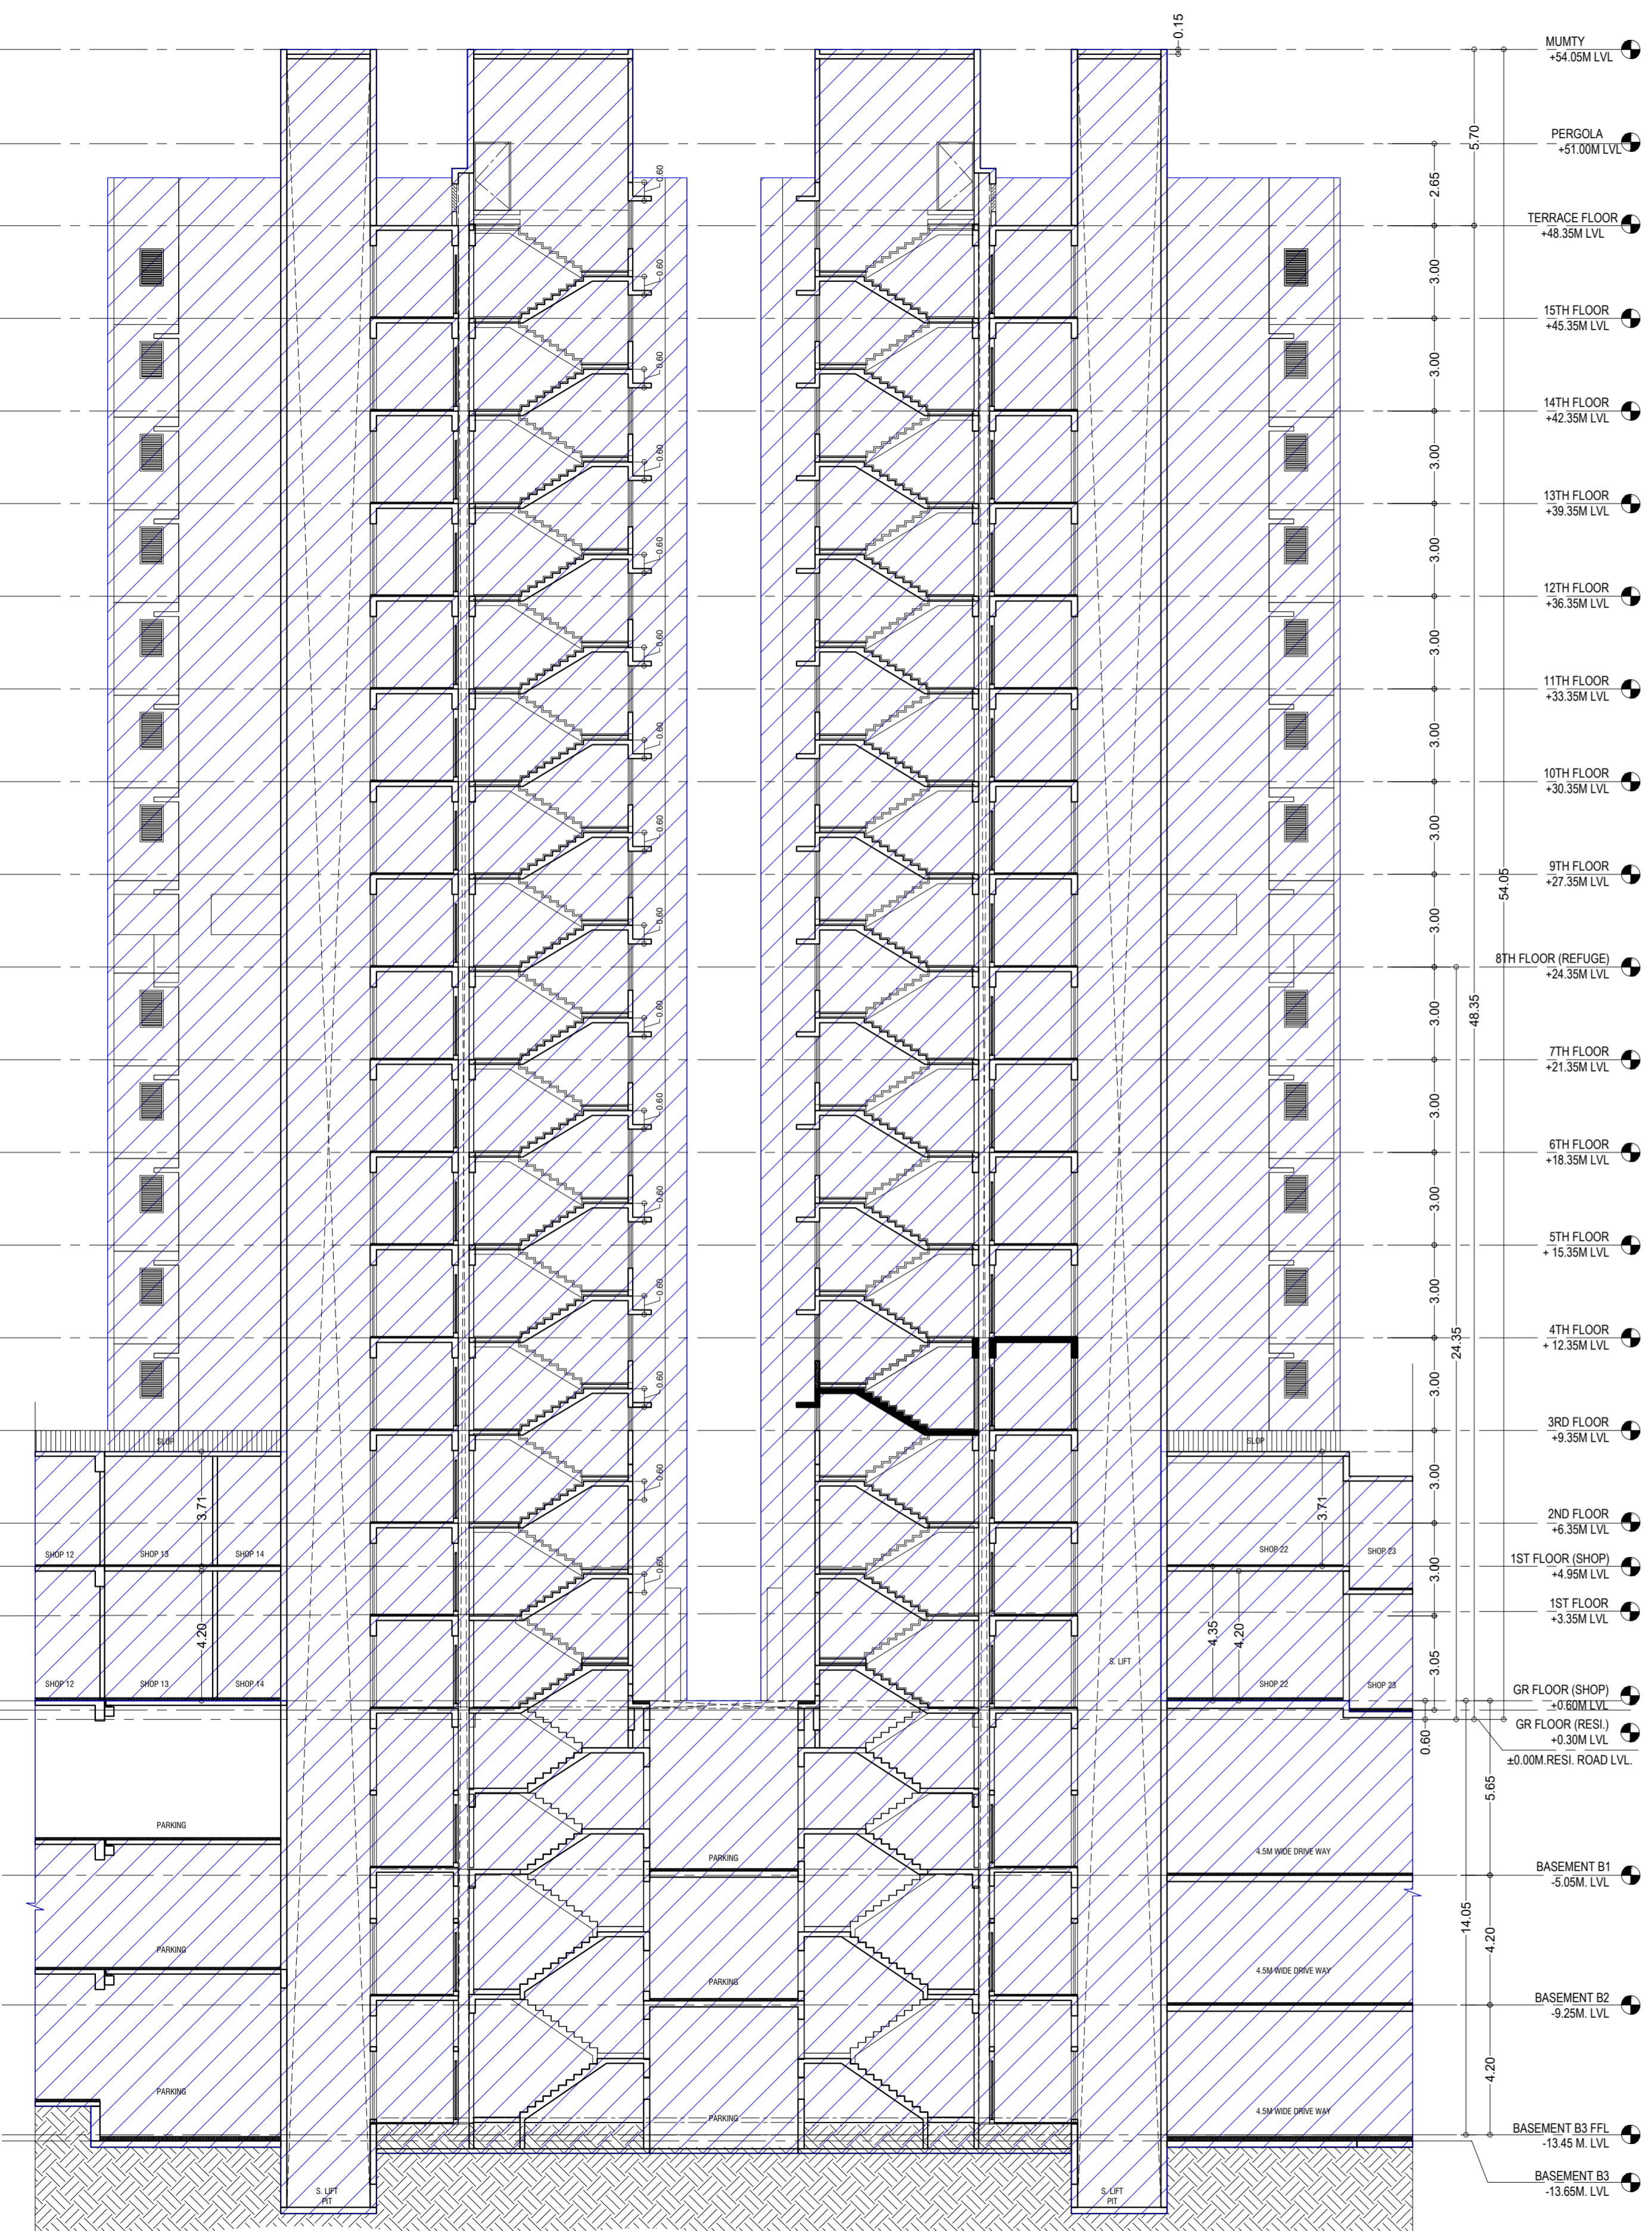

SECTION AA
(Tower-4 & 5)

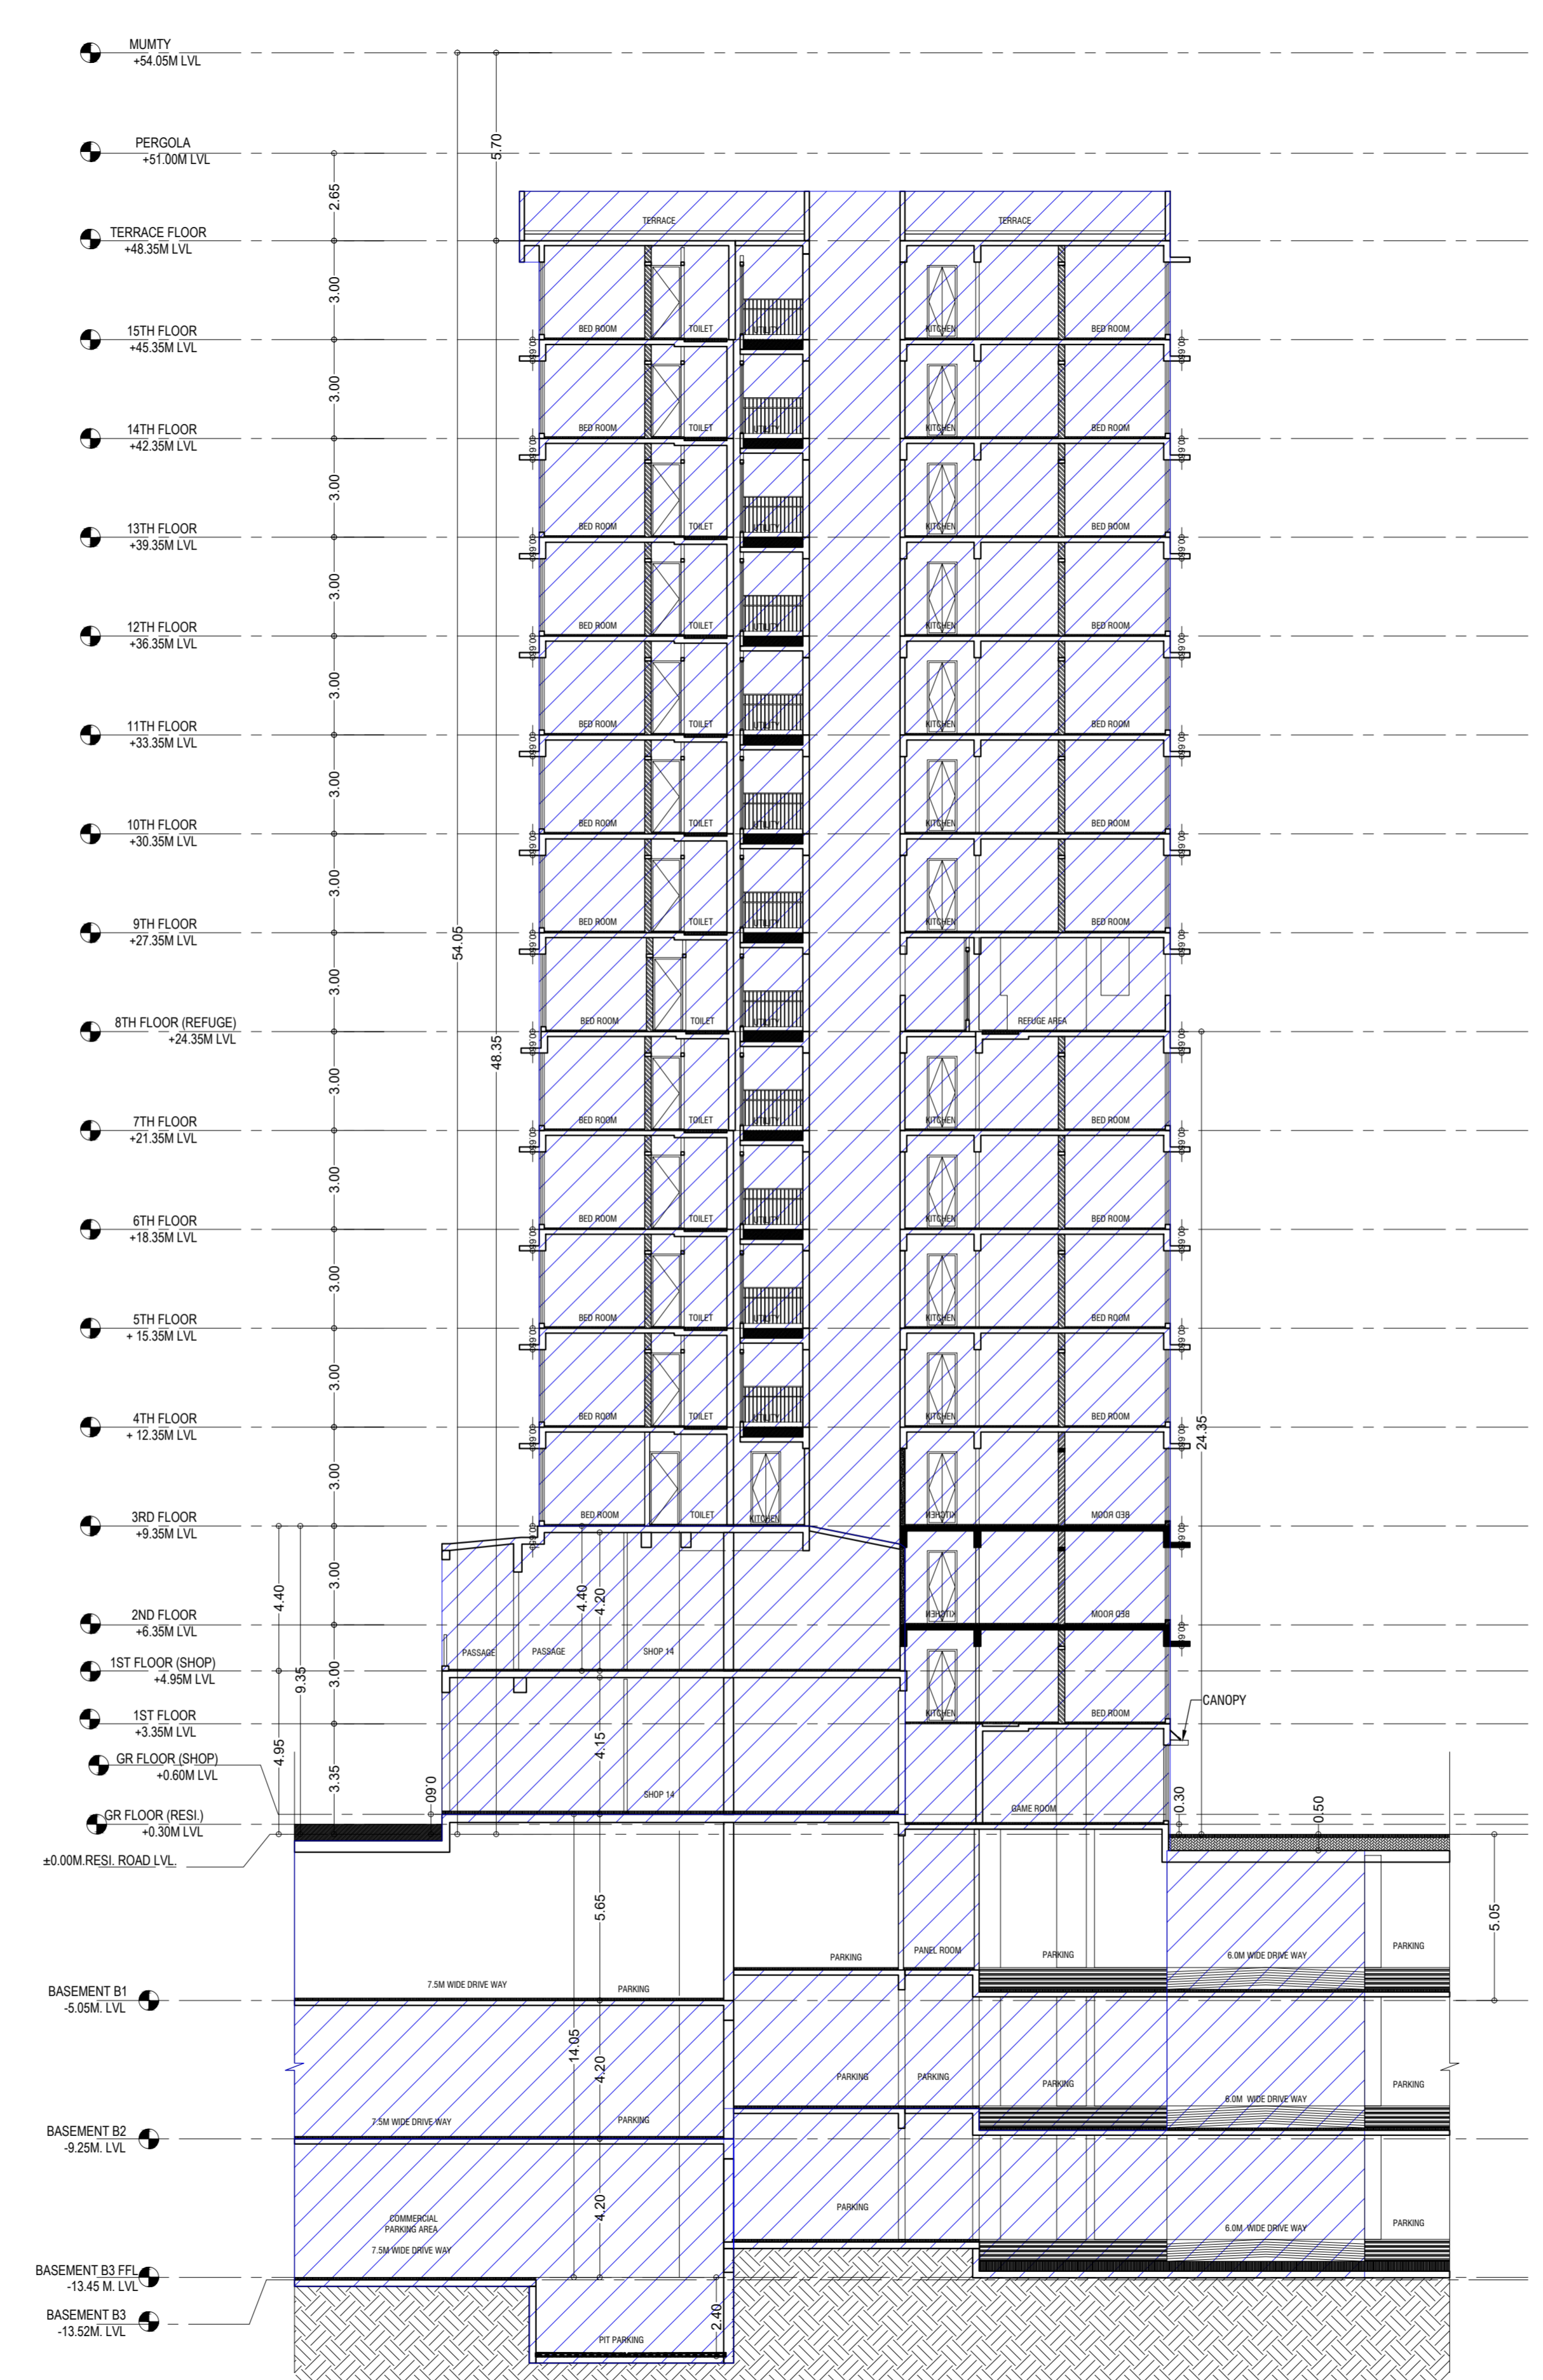

SECTION BB
(Tower-4)

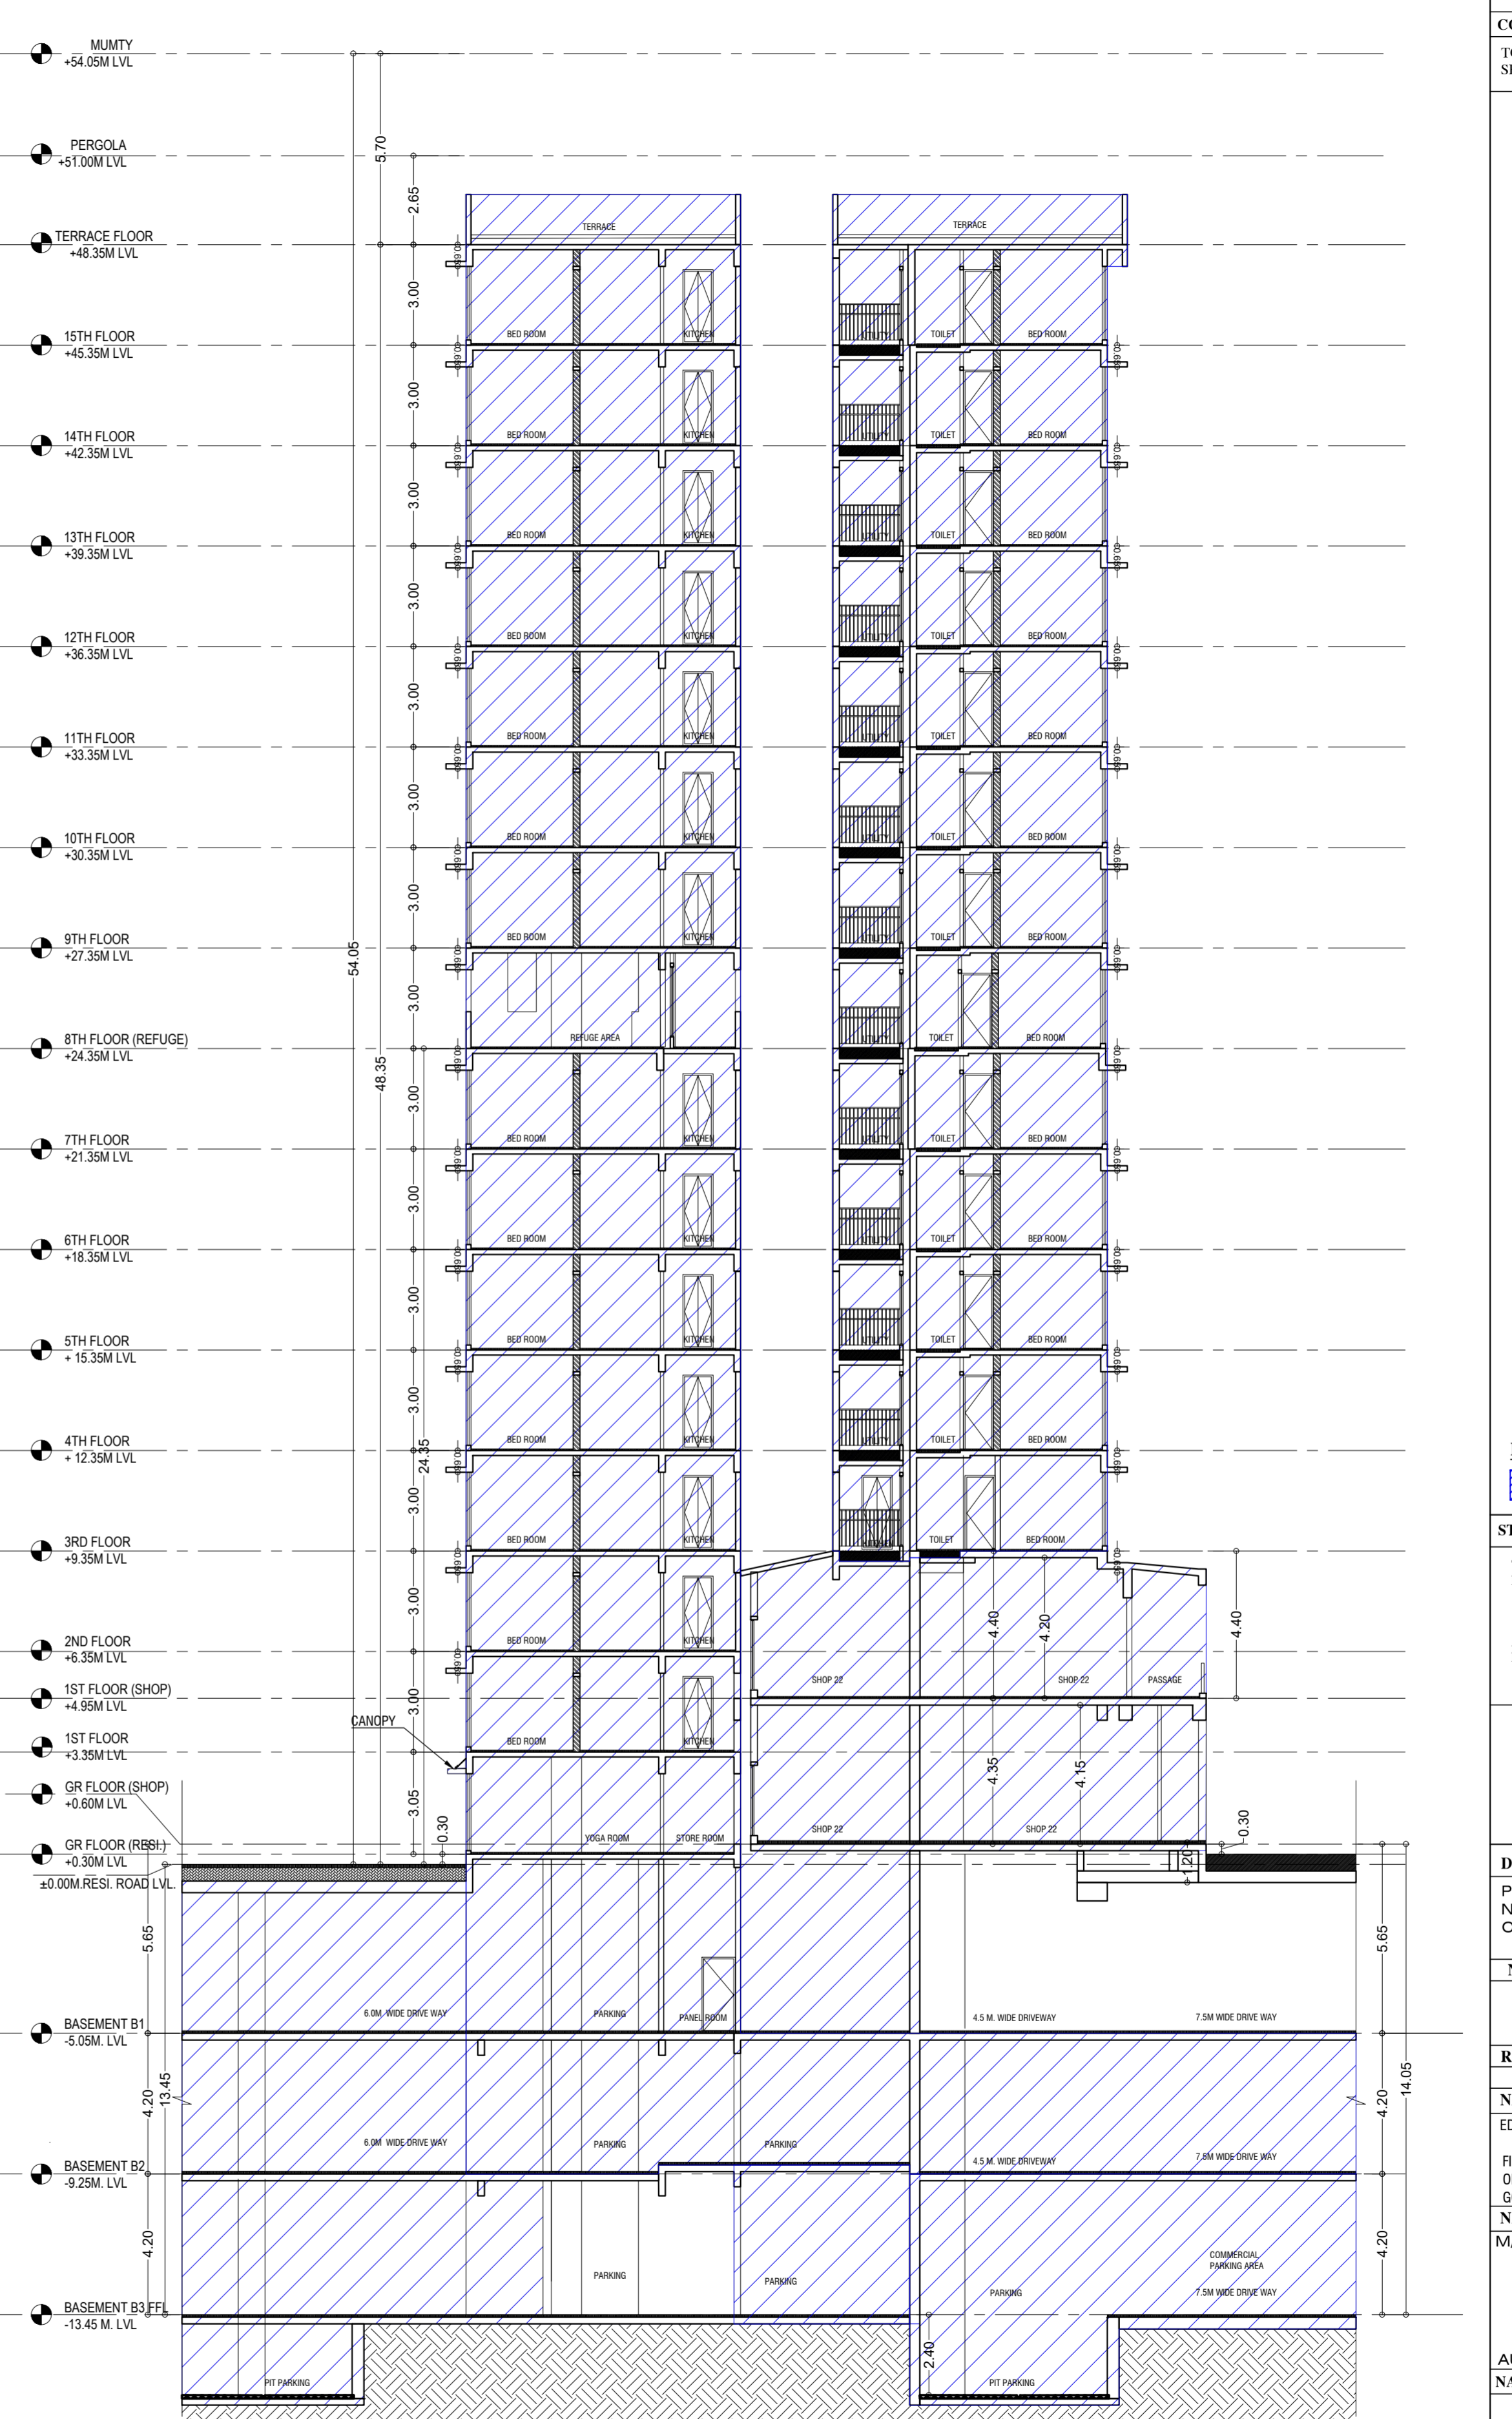

SECTION CC
(Tower-5)

LEGENDS:-
AREA SHOWN FOR OC OBTAINED

STAMP AND DATE OF APPROVAL OF PLAN

THIS SANCTION APPROVAL TO PREVIOUS PLANS SANCTION UNDER NO. P-5303/2020/1, 24 And Other/L. Ward/CHANDIVALI/13/17/10/Amended dtd. 23.06.2024

APPROVED SUBJECT TO THE CONDITIONS MENTIONED IN THIS OFFICE LETTER NO. P-5303/2020/1, 24 And Other/L. Ward/CHANDIVALI/13/17/10/AMENDED

S.E.(B.P) N	A.E.(B.P) 'L' WARD	E.E.(B.P.) ES-1
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DESCRIPTION OF PROPOSAL & PROPERTY
PROPOSED DEVELOPMENT ON PLOT BEARING C.T.S. NO. 24/A TO 24/E & OLD CTS NO. 24/1, 24/2 & 24/3 OF VILLAGE CHANDIVALI, CHANDIVALI ROAD, L. WARD, MUMBAI.

NORTH	JOB. NO.	DRG. NO.	DRAWN BY
	525	19/23	
SCALE	DATE	CHECKED BY	
1:200			


REVISIONS DESCRIPTION:

NAME AND ADDRESS OF DESIGN ARCHITECT
EDICE CONSULTANTS PVT. LTD.


FIRST FLOOR PLOT #2A ULGAR INFOTECH PARK, OPPOSITE DEONAR BUS DEPOT SUNDER BAUG, GOVANDI EAST, MUMBAI, MAHARASHTRA 400088

NAME OF THE OWNER
M/S. GODREJ PROPERTIES, LTD.

AUTHORIZED SIGNATORY
NAME AND ADDRESS OF LICENSED SURVEYOR (L.S)

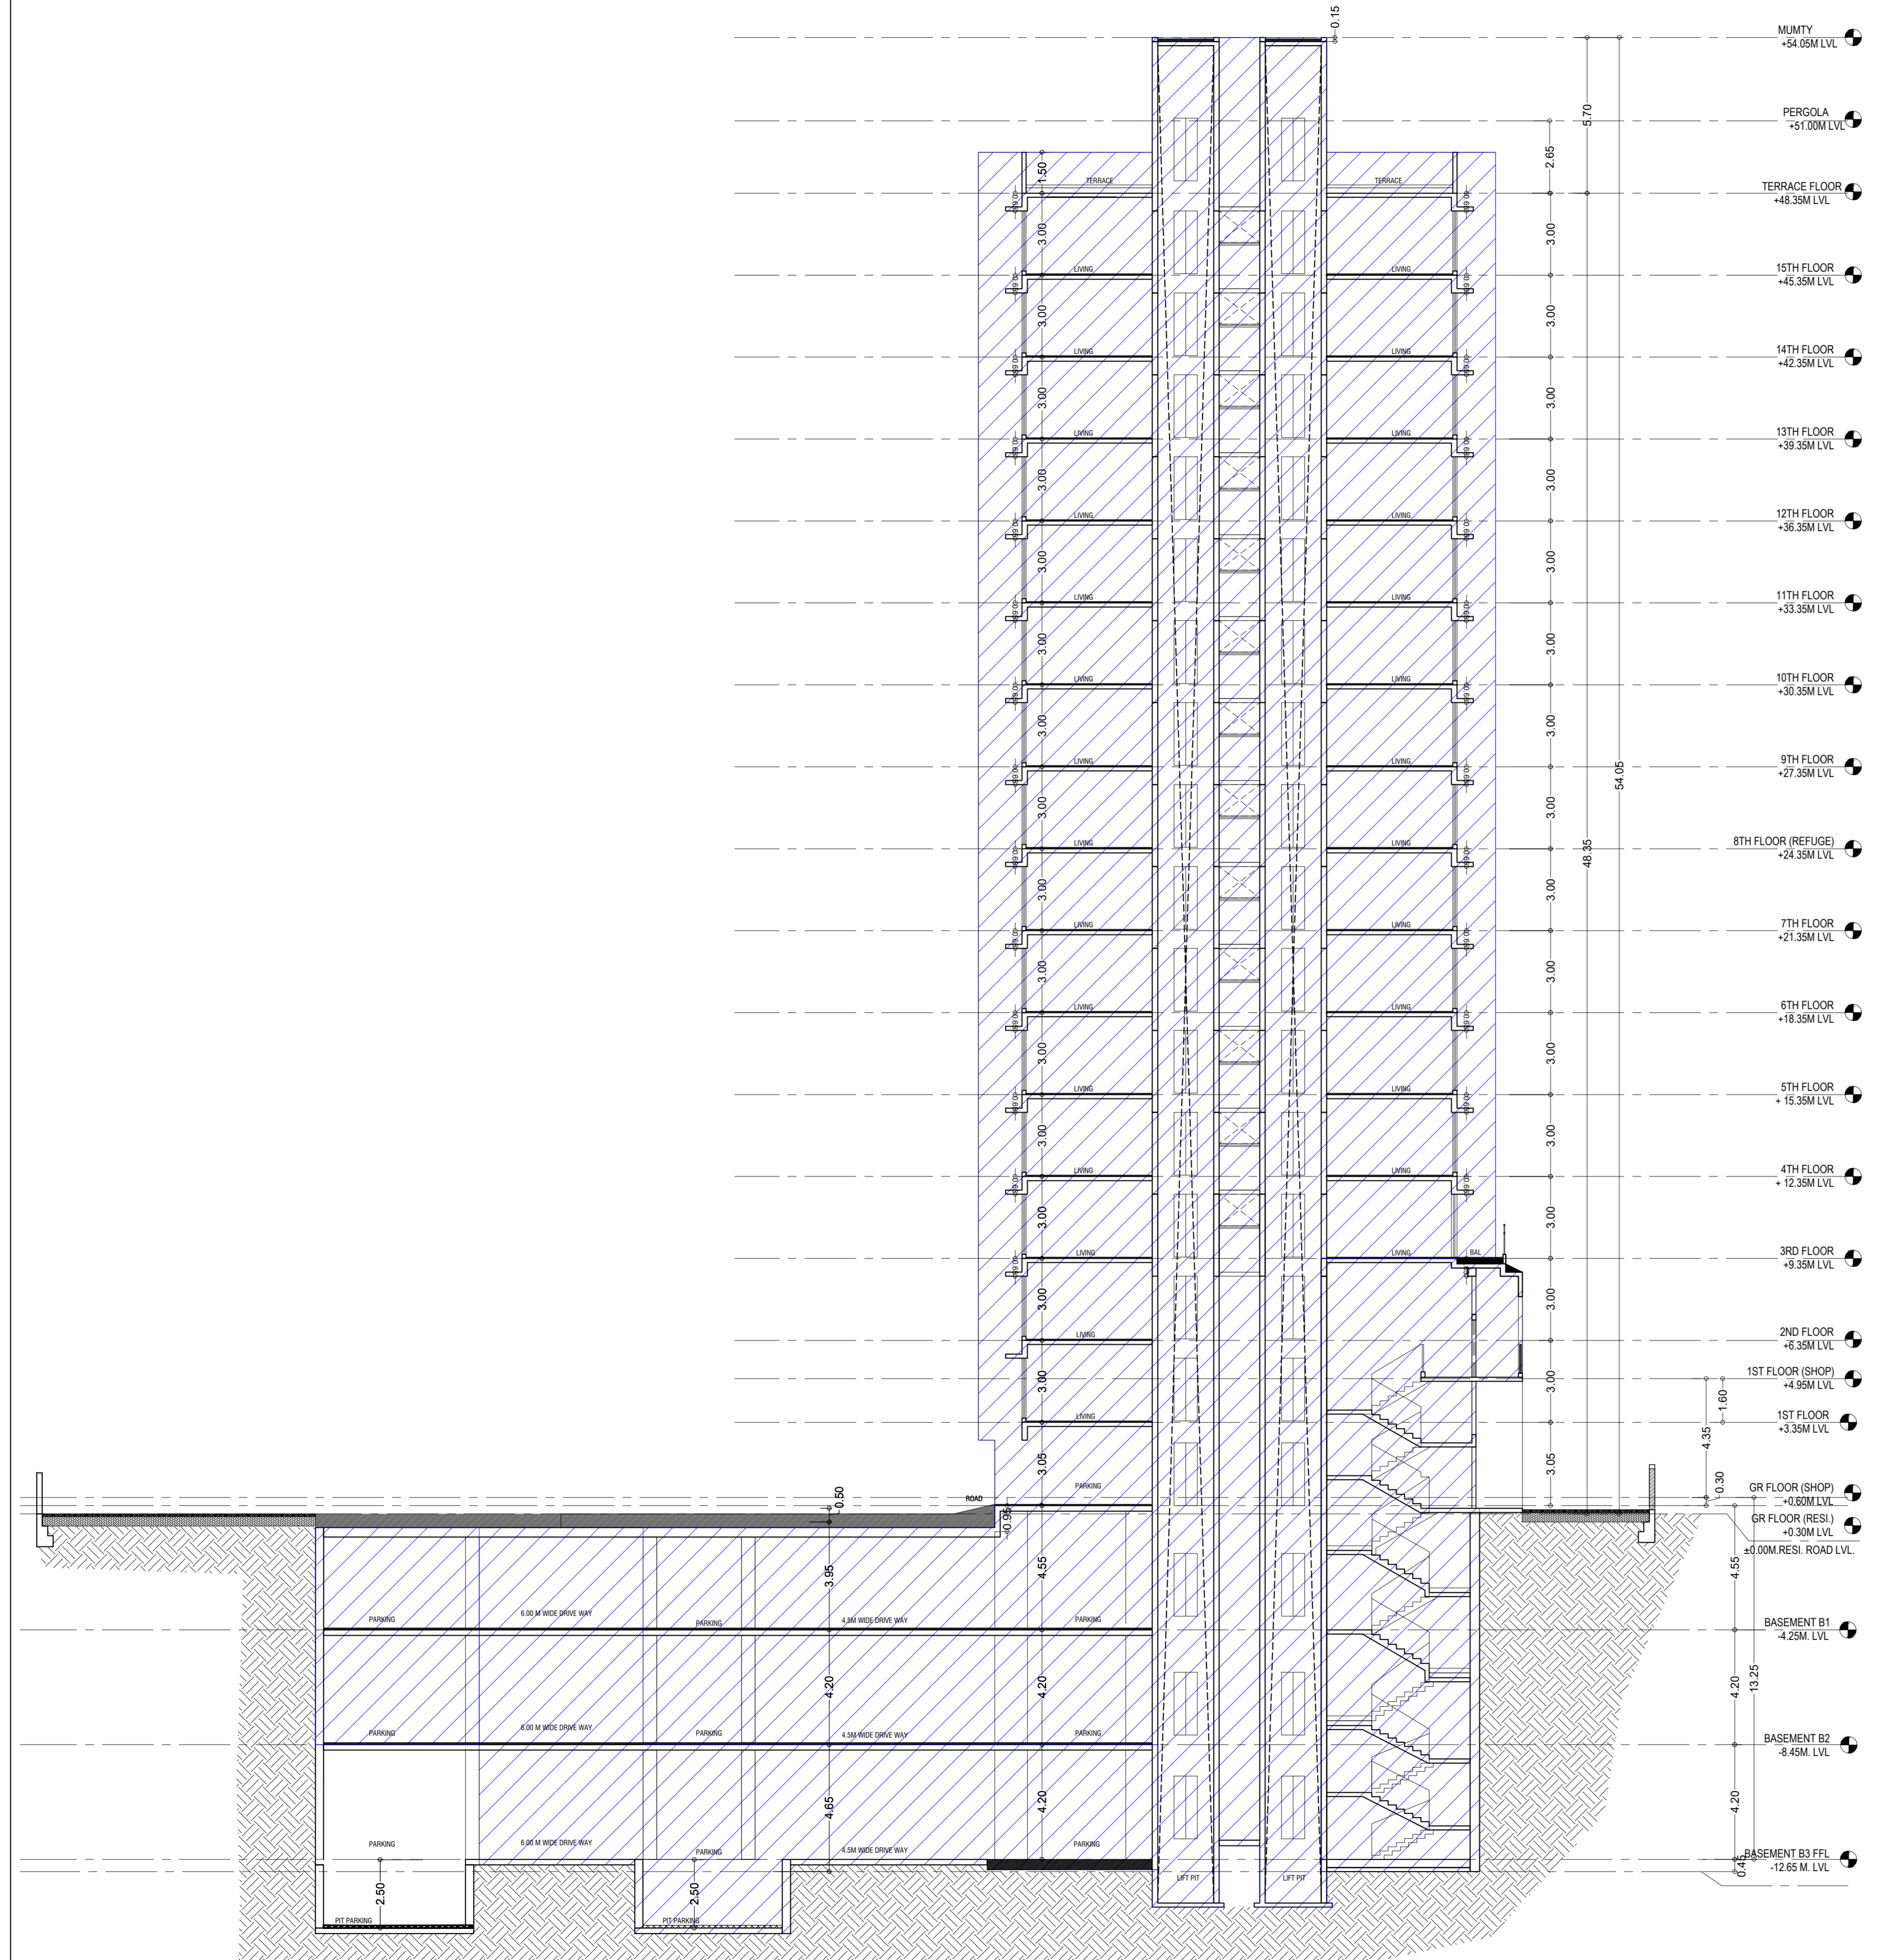

SECTION AA
(Tower-6)

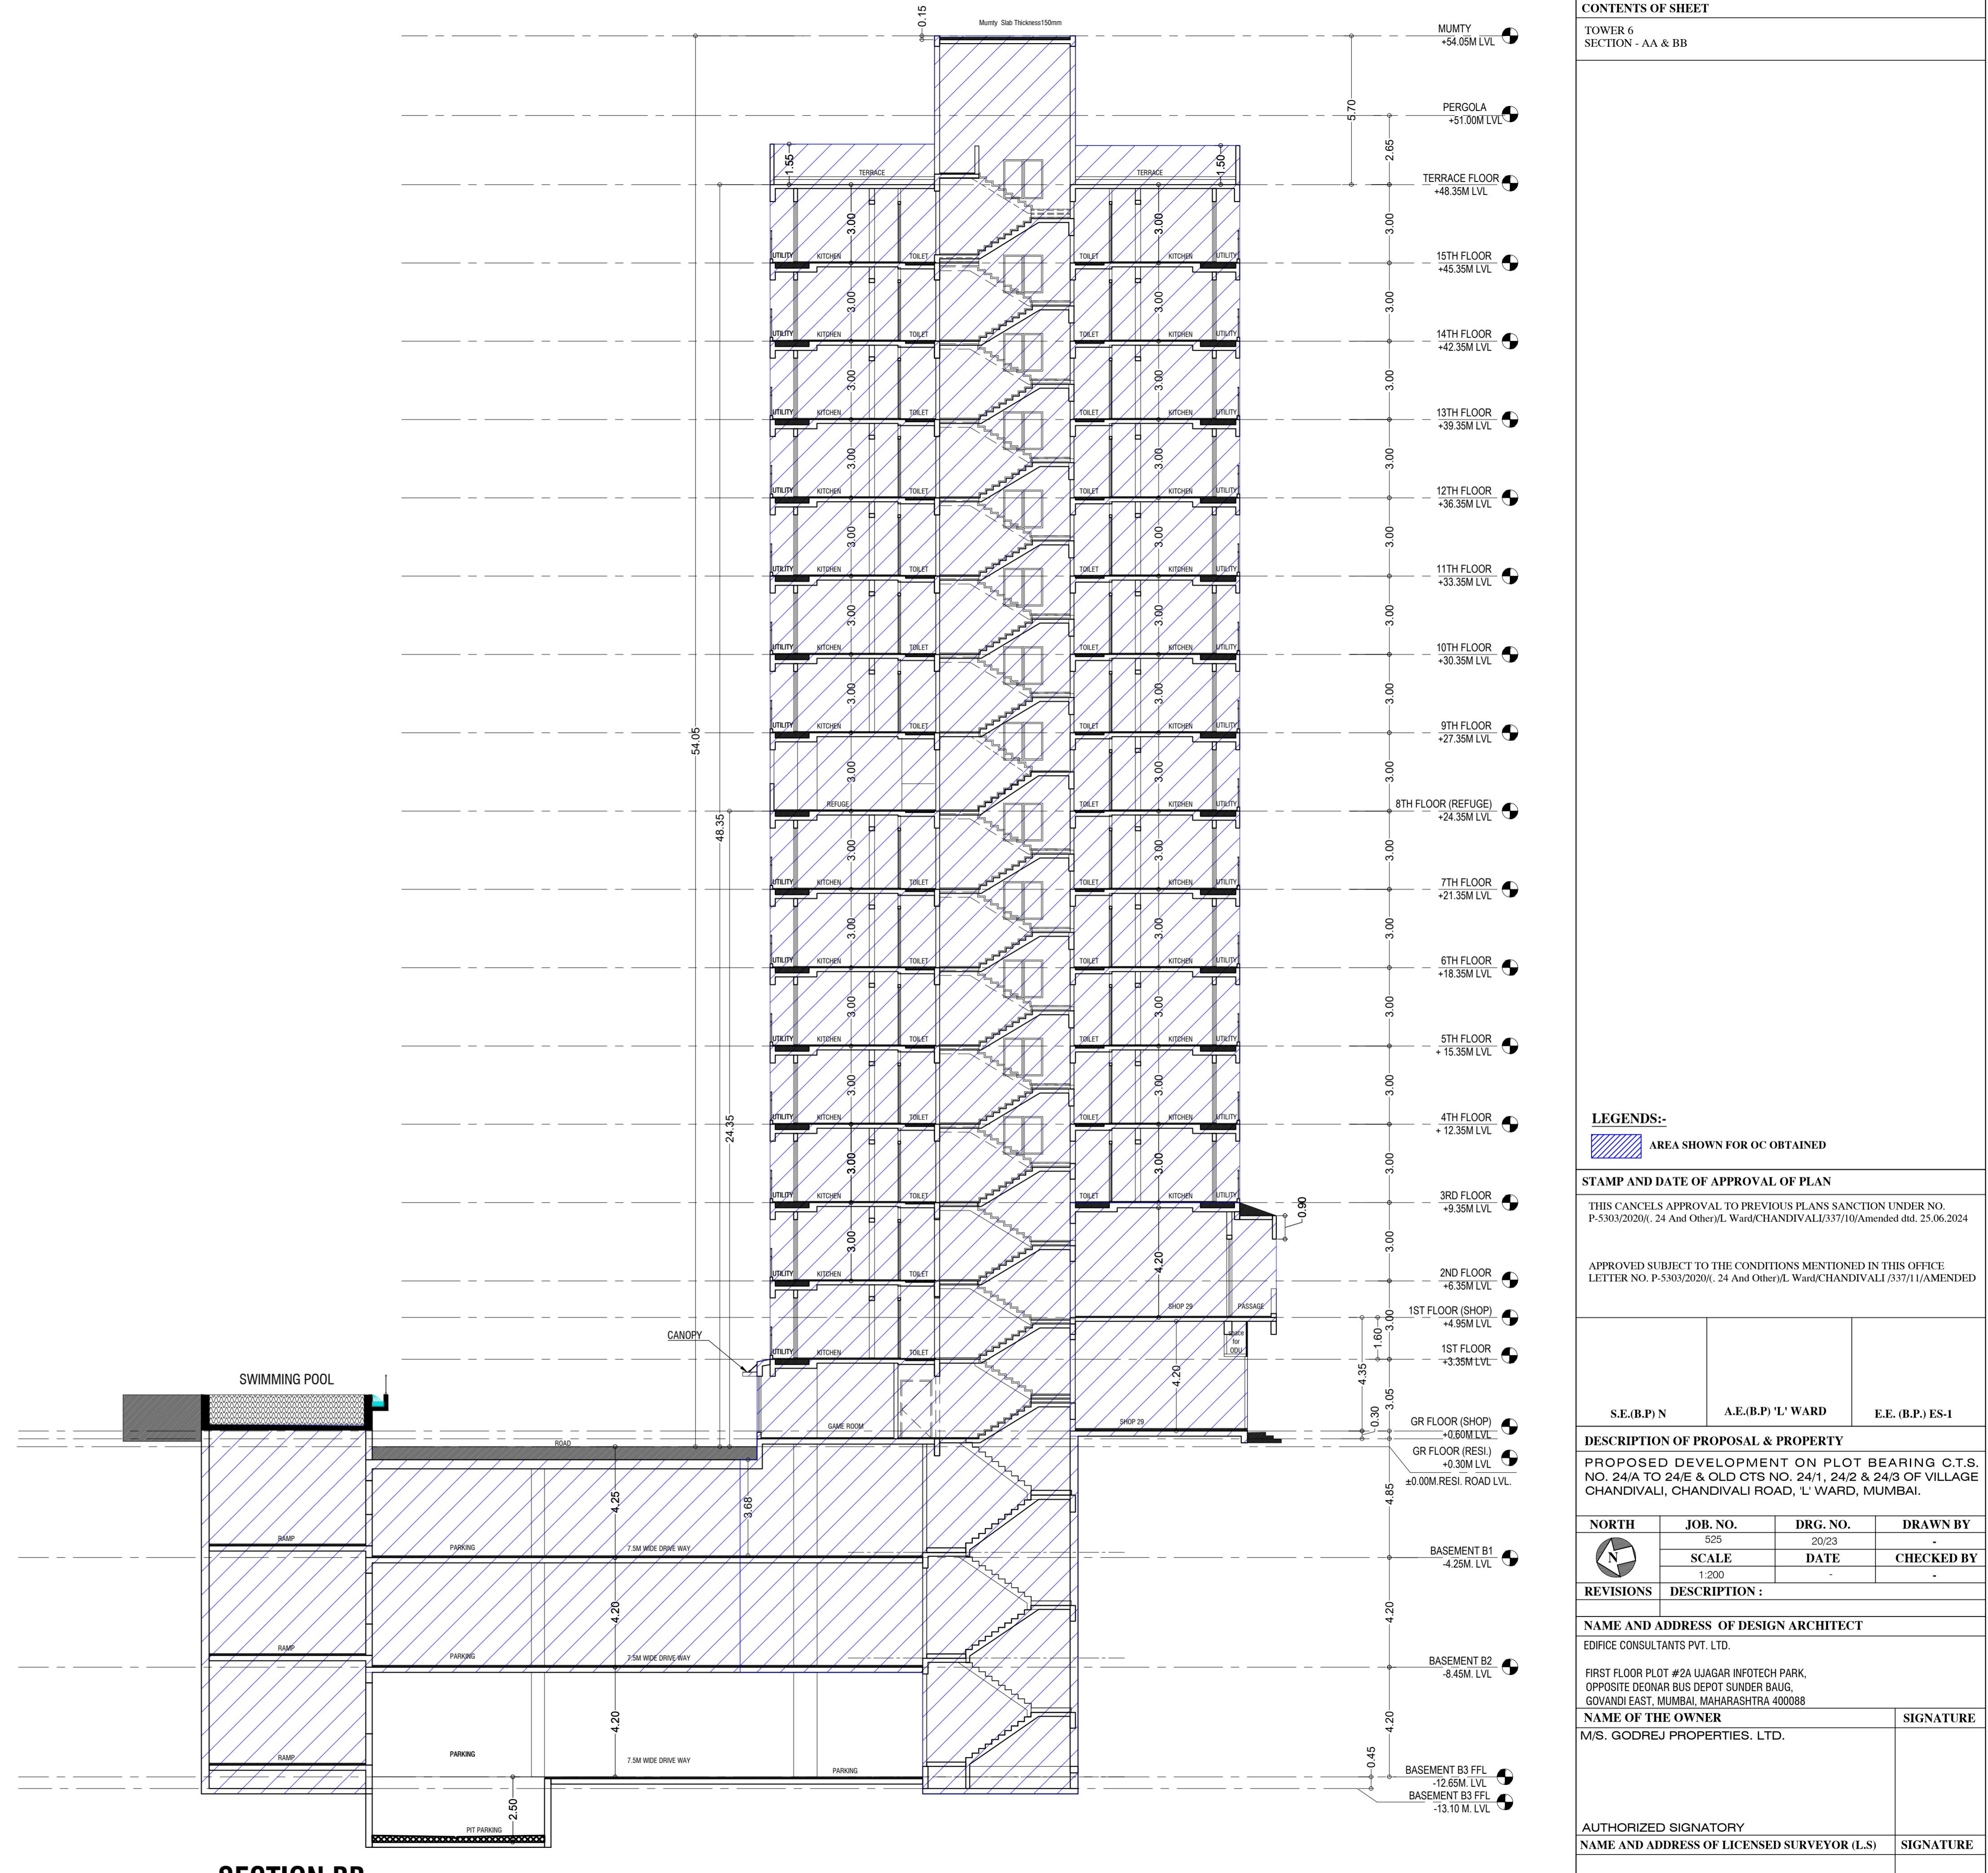

SECTION BB
(Tower-6)

LEGENDS:-
 AREA SHOWN FOR OC OBTAINED

STAMP AND DATE OF APPROVAL OF PLAN
 THIS CANCELS APPROVAL TO PREVIOUS PLANS SANCTION UNDER NO. P-5303/2020/L-24 And Other/L. Ward/CHANDIVALI/337/11/AMENDED dt. 25.06.2024

APPROVED SUBJECT TO THE CONDITIONS MENTIONED IN THIS OFFICE LETTER NO. P-5303/2020/L-24 And Other/L. Ward/CHANDIVALI/337/11/AMENDED

S.E.(P) N	A.E.(P) 'L' WARD	E.E. (B.P.) ES-1
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DESCRIPTION OF PROPOSAL & PROPERTY
 PROPOSED DEVELOPMENT ON PLOT BEARING C.T.S. NO. 24/A TO 24/E & OLD CTS NO. 24/1, 24/2 & 24/3 OF VILLAGE CHANDIVALI, CHANDIVALI ROAD, 'L' WARD, MUMBAI.

NORTH	JOB. NO.	DRG. NO.	DRAWN BY
	529	2023	
REVISIONS	SCALE	DATE	CHECKED BY
	1:200		

NAME AND ADDRESS OF DESIGN ARCHITECT
 EDIFICE CONSULTANTS PVT. LTD.
 FIRST FLOOR PLOT #2A UJAGAR INFOTECH PARK, OPPOSITE DEONAR BUS DEPOT SUNDER BAUG, GOVANDI EAST, MUMBAI, MAHARASHTRA 400088

NAME OF THE OWNER
 M/S. GODREJ PROPERTIES. LTD.

AUTHORIZED SIGNATORY
 NAME AND ADDRESS OF LICENSED SURVEYOR (L.S.)

CONTENTS OF SHEET

TOWER 7
SECTION - AA & BB


LEGENDS:-
 AREA SHOWN FOR OC OBTAINED

STAMP AND DATE OF APPROVAL OF PLAN
 THIS CANCELS APPROVAL TO PREVIOUS PLANS SANCTION UNDER NO. P-5303/2020/(24 And Other)/L Ward/CHANDIVALI/337/1/AMENDED dtd. 25.06.2024

APPROVED SUBJECT TO THE CONDITIONS MENTIONED IN THIS OFFICE LETTER NO. P-5303/2020/(24 And Other)/L Ward/CHANDIVALI/337/1/AMENDED

S.E.(B.P) N A.E.(B.P) 'L' WARD E.E.(B.P.) ES-1

DESCRIPTION OF PROPOSAL & PROPERTY
 PROPOSED DEVELOPMENT ON PLOT BEARING C.T.S. NO. 24/A TO 24/E & OLD CTS NO. 24/1, 24/2 & 24/3 OF VILLAGE CHANDIVALI, CHANDIVALI ROAD, 'L' WARD, MUMBAI.

NORTH	JOB. NO.	DRG. NO.	DRAWN BY
	525	21/23	-
	SCALE	DATE	CHECKED BY
	1:200	-	-



REVISIONS	DESCRIPTION :

NAME AND ADDRESS OF DESIGN ARCHITECT
 EDIFICE CONSULTANTS PVT. LTD.


FIRST FLOOR PLOT #2A UJAGAR INFOTECH PARK, OPPOSITE DEONAR BUS DEPOT SUNDER BAUG, GOVANDI EAST, MUMBAI, MAHARASHTRA 400088

NAME OF THE OWNER **SIGNATURE**
 M/S. GODREJ PROPERTIES. LTD.

AUTHORIZED SIGNATORY
NAME AND ADDRESS OF LICENSED SURVEYOR (L.S) **SIGNATURE**

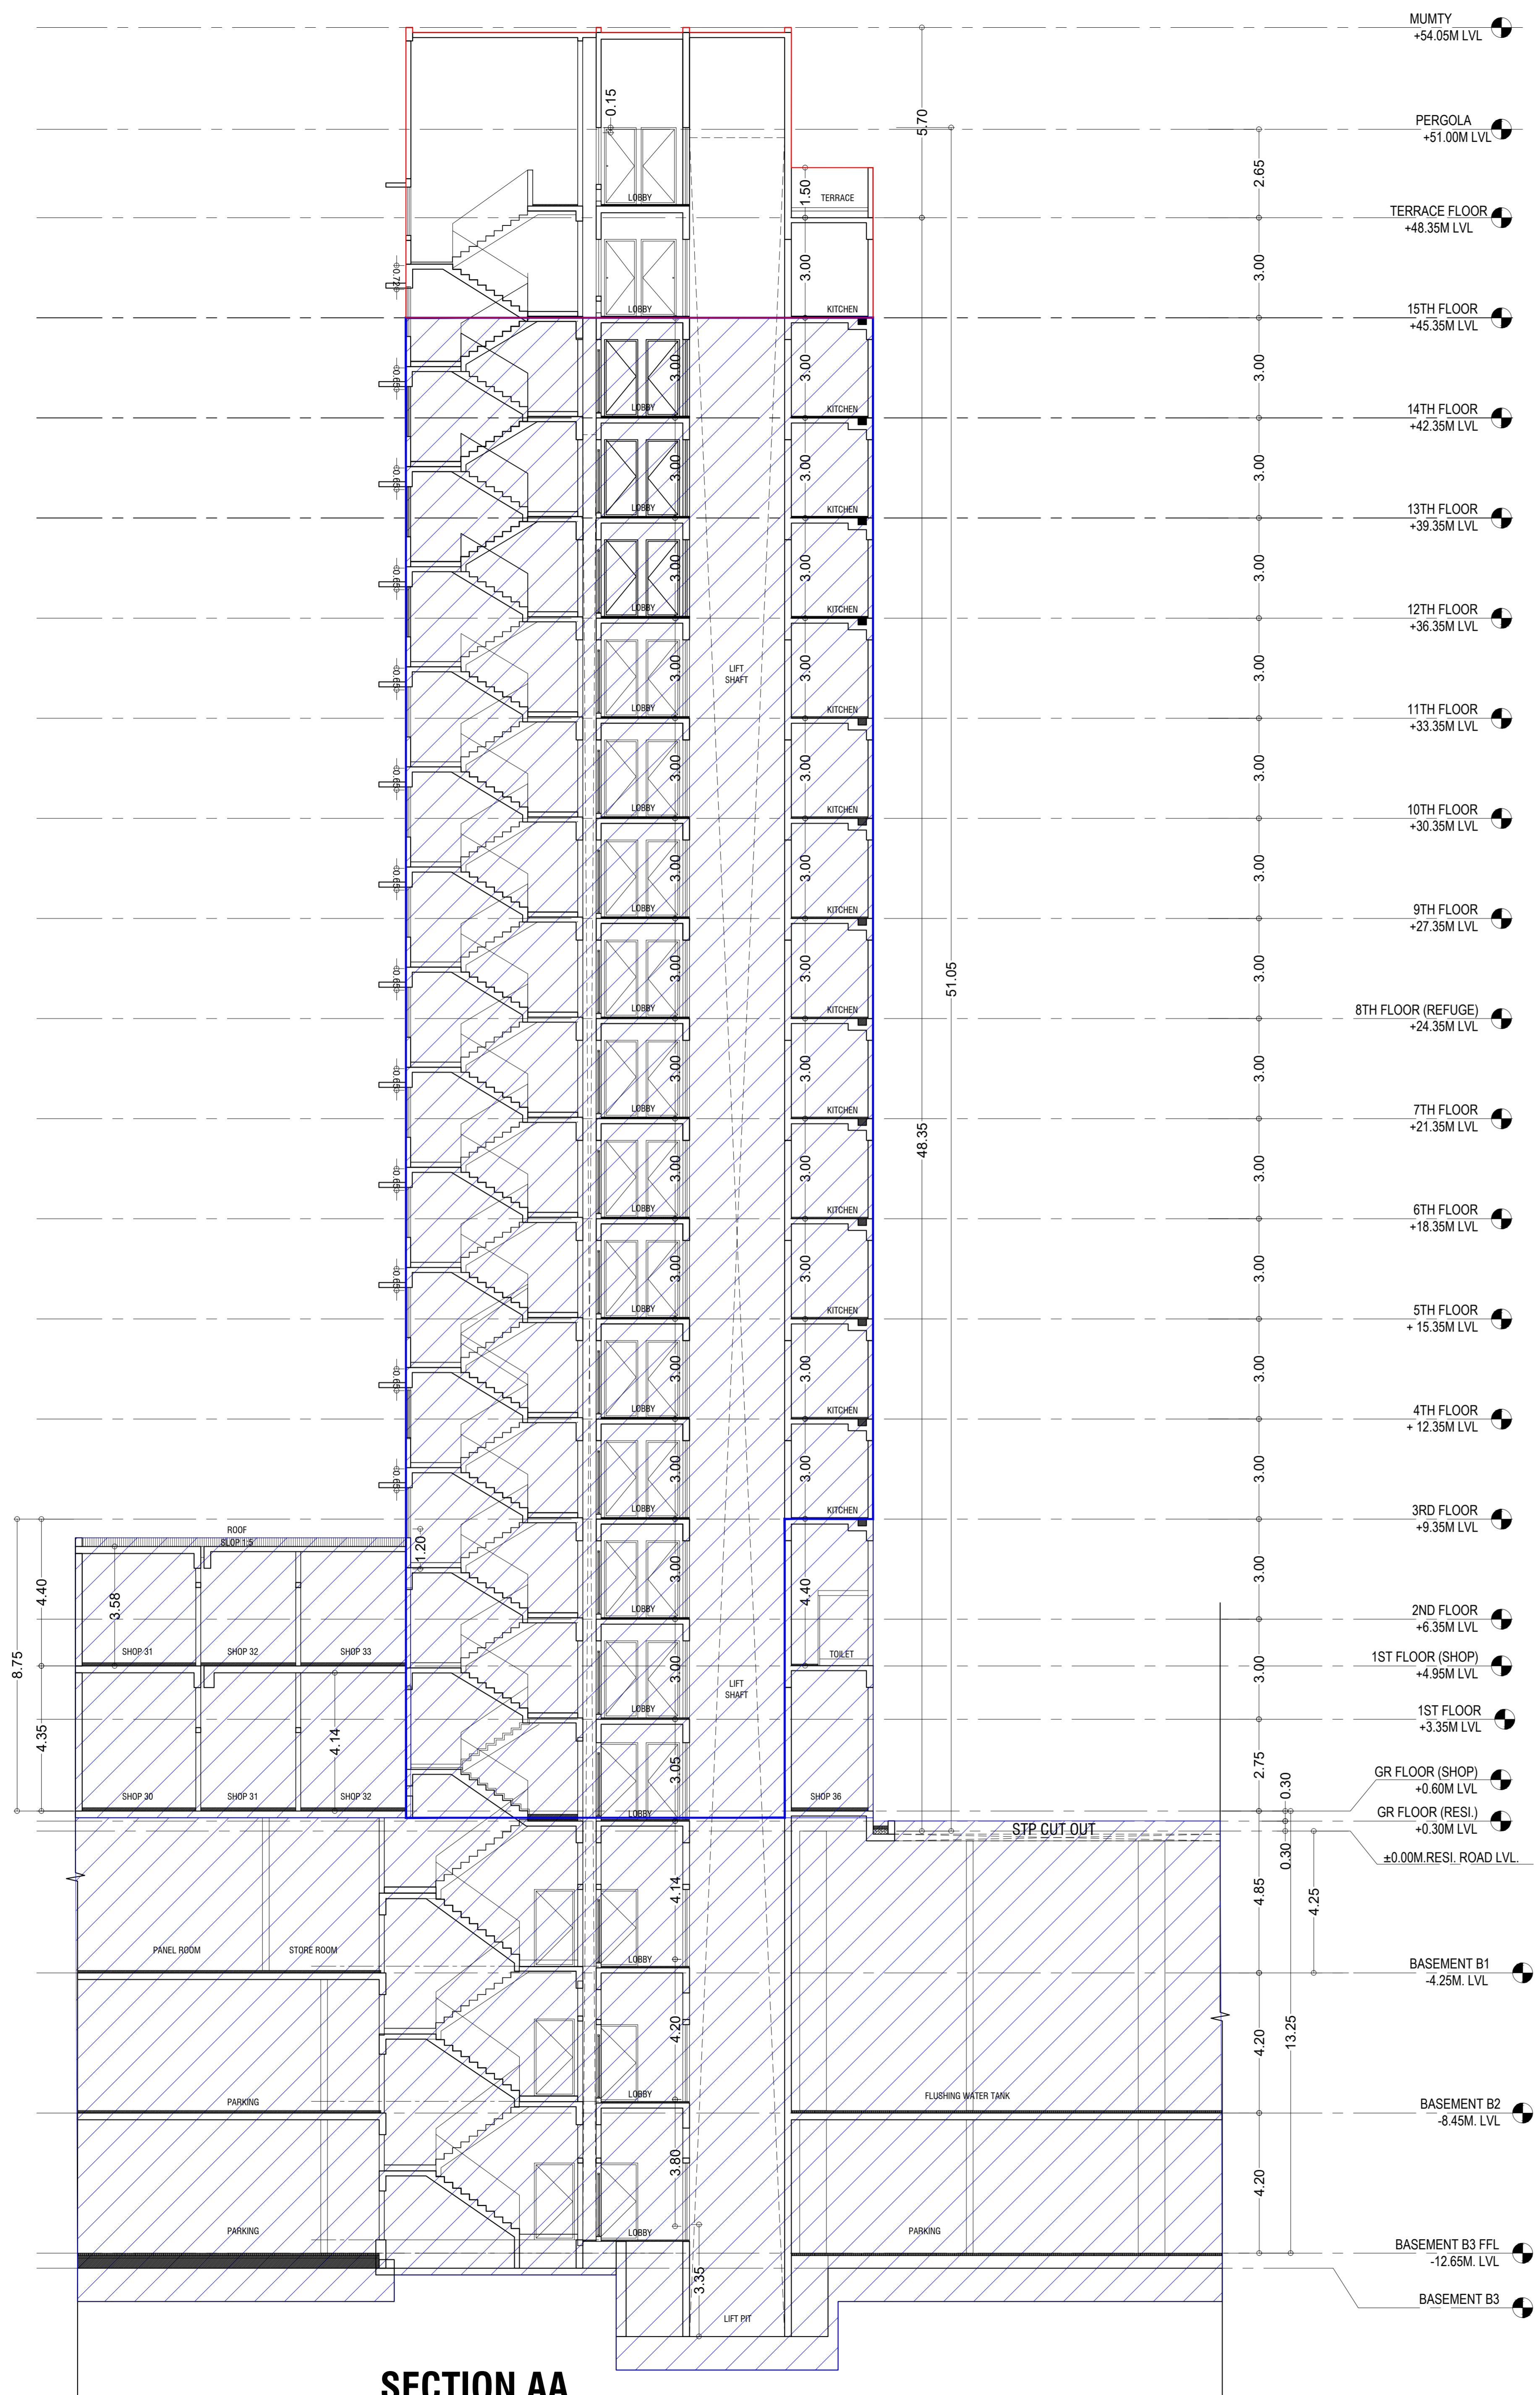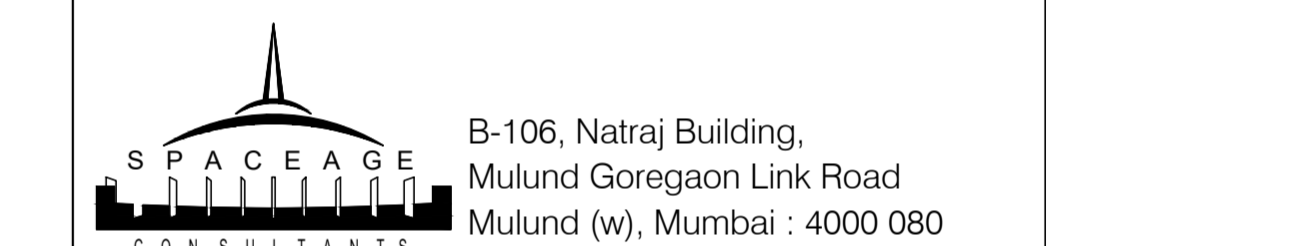

SECTION AA
(Tower-7)

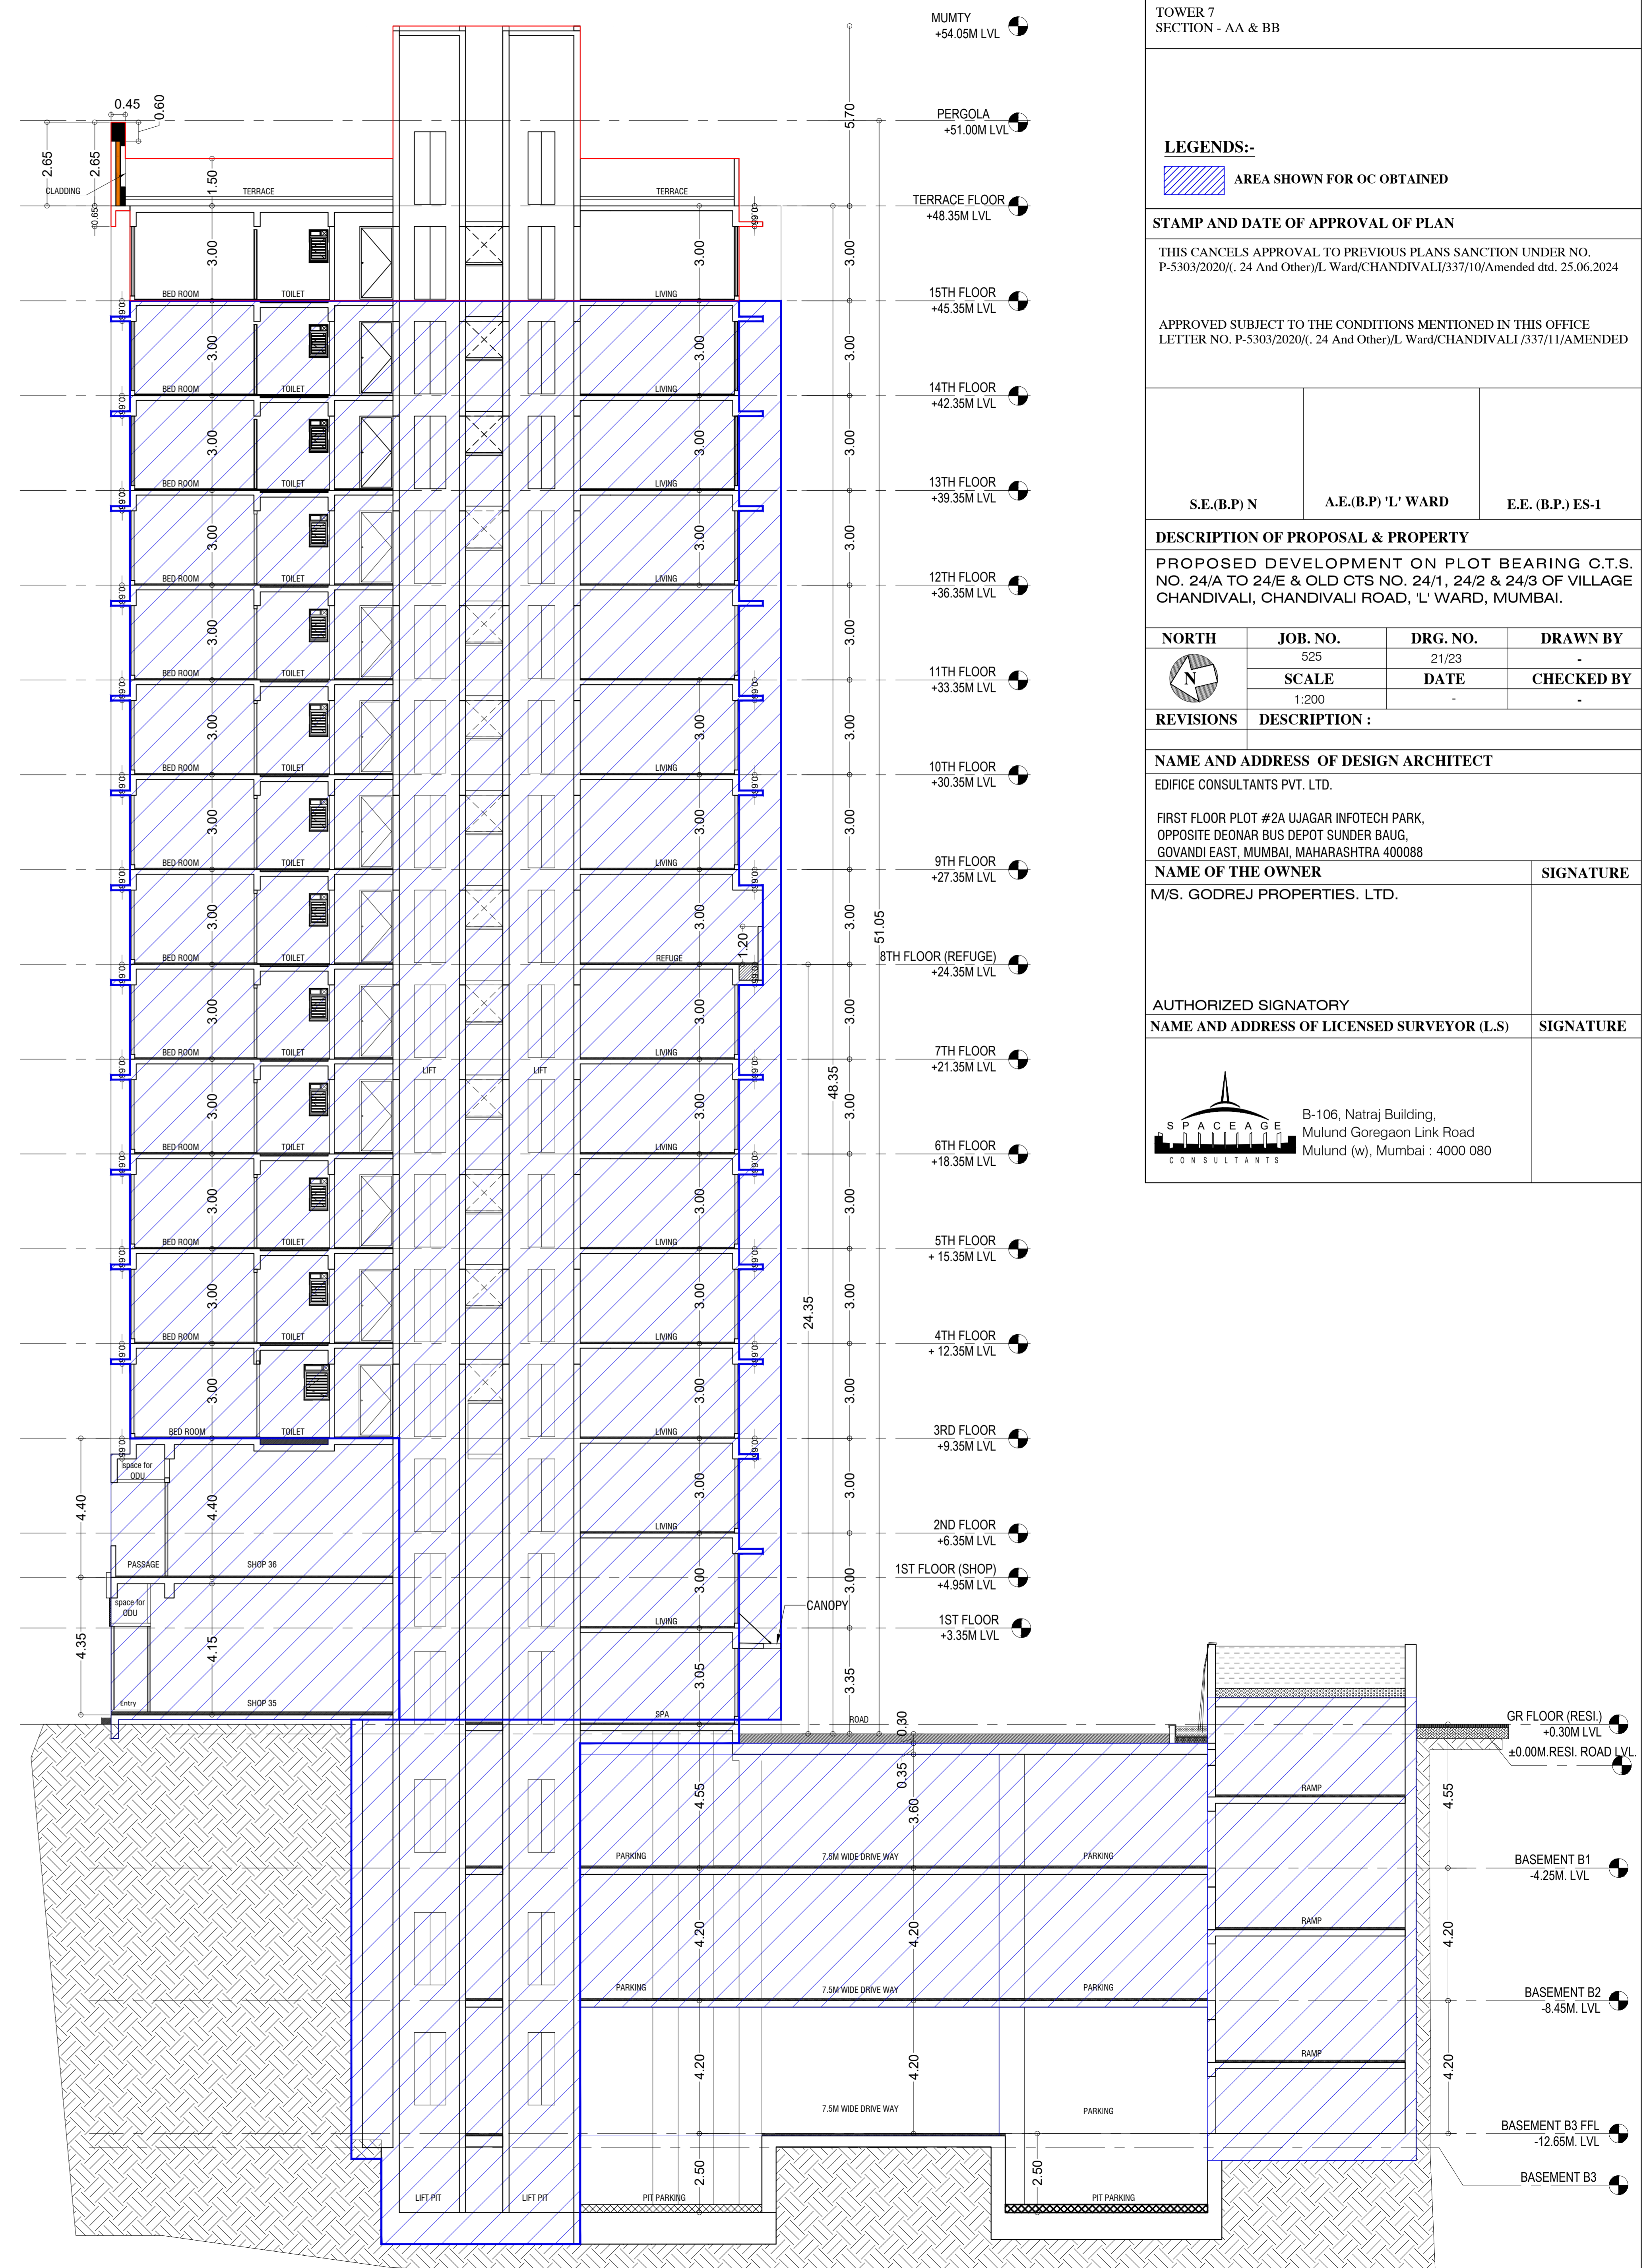

SECTION BB
(Tower-7)

CONTENTS OF SHEET

TOWER 8
SECTION - AA & BB

LEGENDS:-
AREA SHOWN FOR OC OBTAINED

STAMP AND DATE OF APPROVAL OF PLAN

THIS CANCELS APPROVAL TO PREVIOUS PLANS SANCTION UNDER NO. P-5303/2020/(. 24 And Other)/L Ward/CHANDIVALI/337/10/Amended dtd. 25.06.2024

APPROVED SUBJECT TO THE CONDITIONS MENTIONED IN THIS OFFICE LETTER NO. P-5303/2020/(. 24 And Other)/L Ward/CHANDIVALI /337/11/AMENDED

S.E.(B.P) N A.E.(B.P) 'L' WARD E.E. (B.P) ES-1

DESCRIPTION OF PROPOSAL & PROPERTY

PROPOSED DEVELOPMENT ON PLOT BEARING C.T.S. NO. 24/A TO 24/E & OLD CTS NO. 24/1, 24/2 & 24/3 OF VILLAGE CHANDIVALI, CHANDIVALI ROAD, 'L' WARD, MUMBAI.

NORTH	JOB. NO.	DRG. NO.	DRAWN BY
	525	22/23	-
	SCALE	DATE	CHECKED BY
	1:200	-	-

REVISIONS DESCRIPTION :

NAME AND ADDRESS OF DESIGN ARCHITECT


EDIFICE CONSULTANTS PVT. LTD.

FIRST FLOOR PLOT #2A UJAGAR INFOTECH PARK, OPPOSITE DEONAR BUS DEPOT SUNDER BAUG, GOVANDI EAST, MUMBAI, MAHARASHTRA 400088

NAME OF THE OWNER SIGNATURE
M/S. GODREJ PROPERTIES. LTD.


AUTHORIZED SIGNATORY

NAME AND ADDRESS OF LICENSED SURVEYOR (L.S) SIGNATURE




Space Age
CONSULTANTS


B-106, Natraj Building,
Mulund Goregaon Link Road
Mulund (w), Mumbai : 4000 080

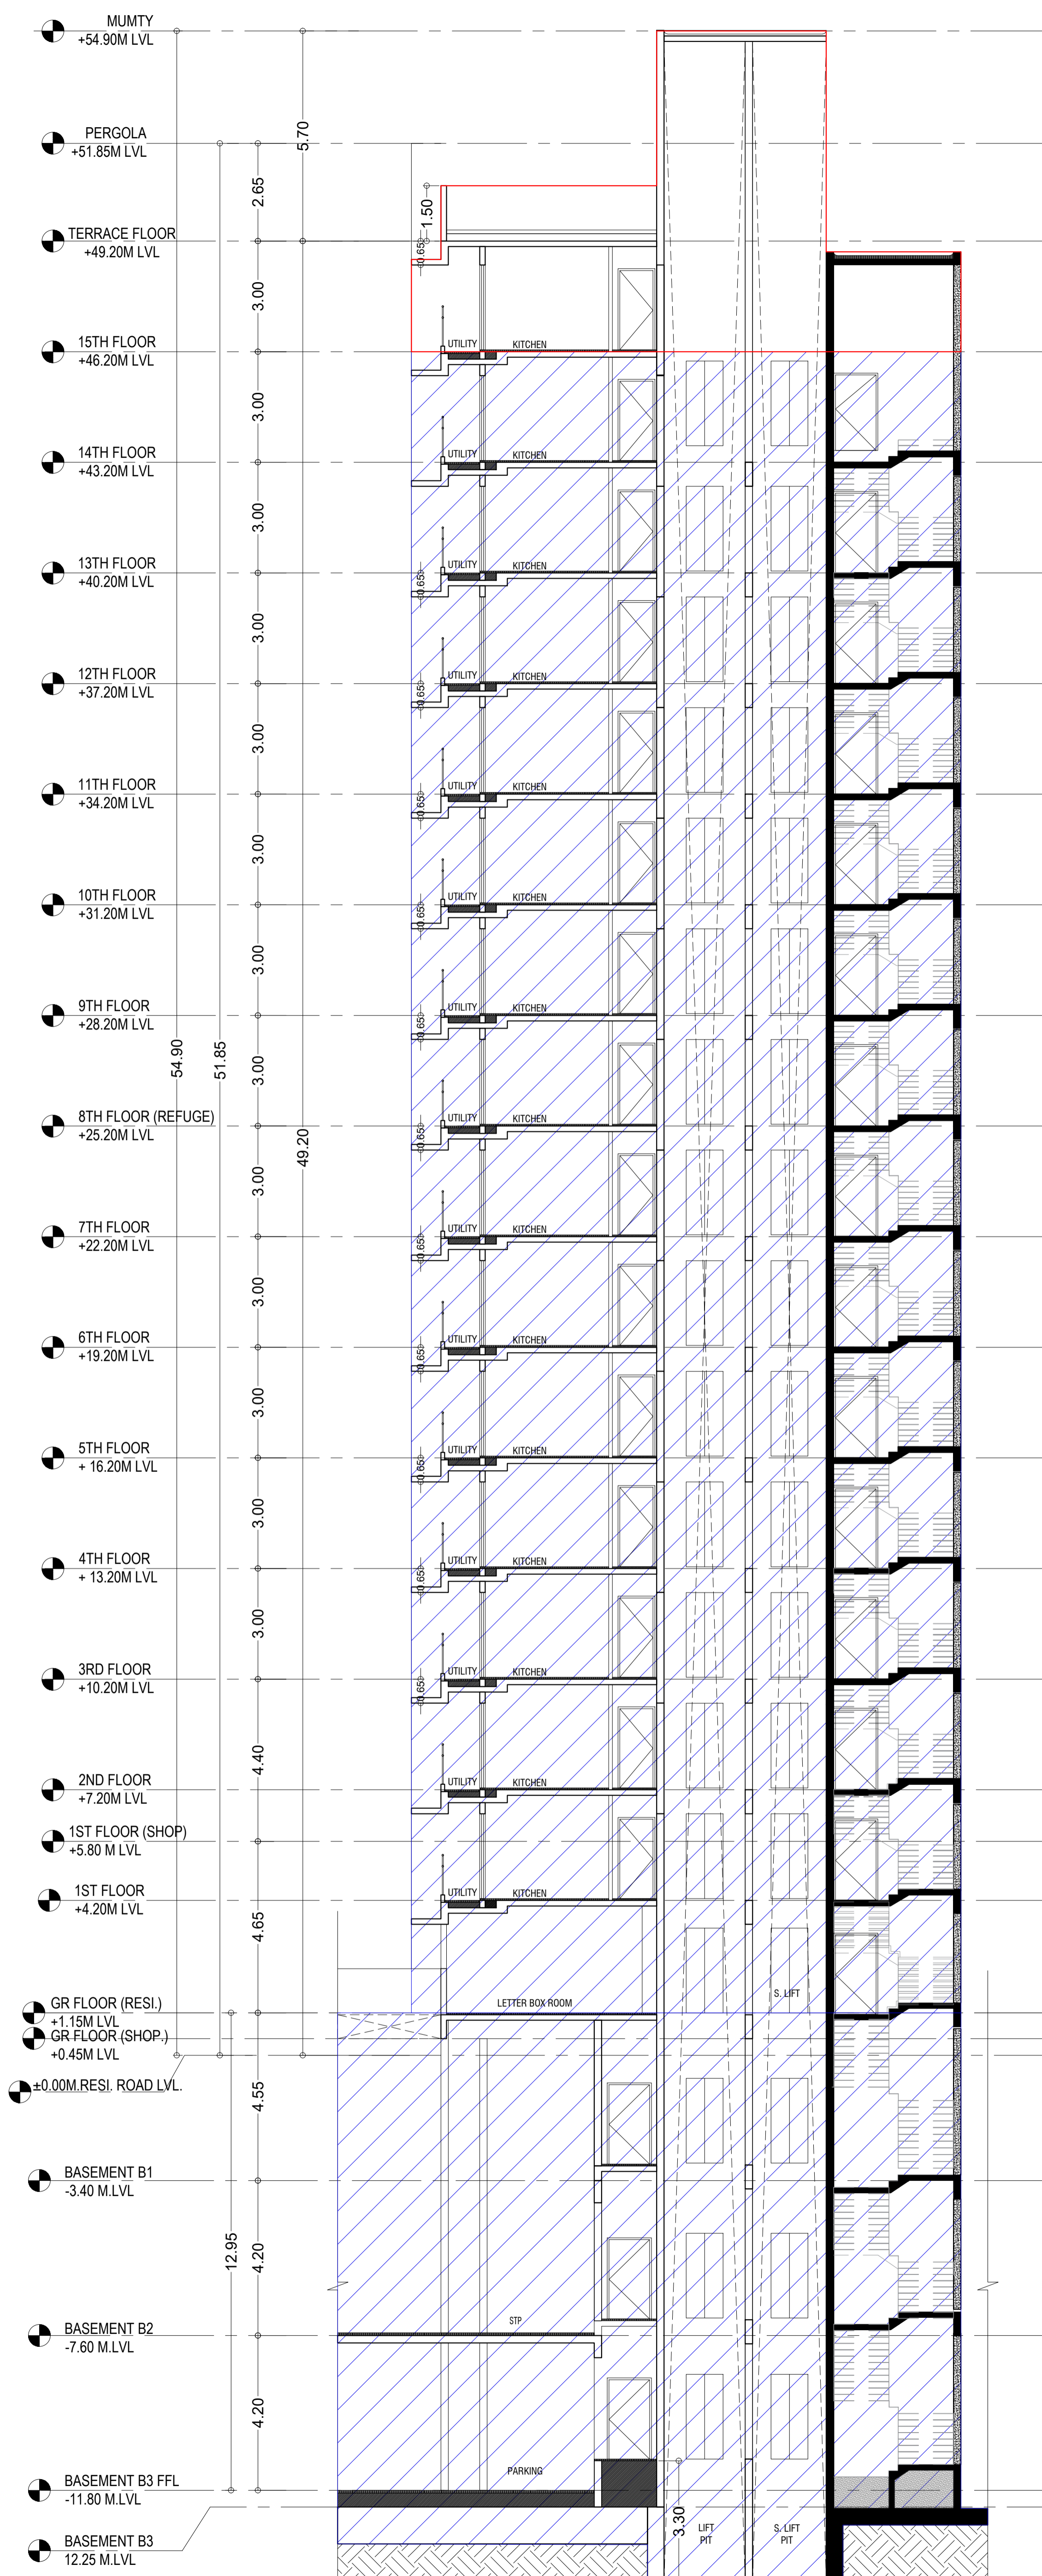

SECTION AA
(Tower-8)

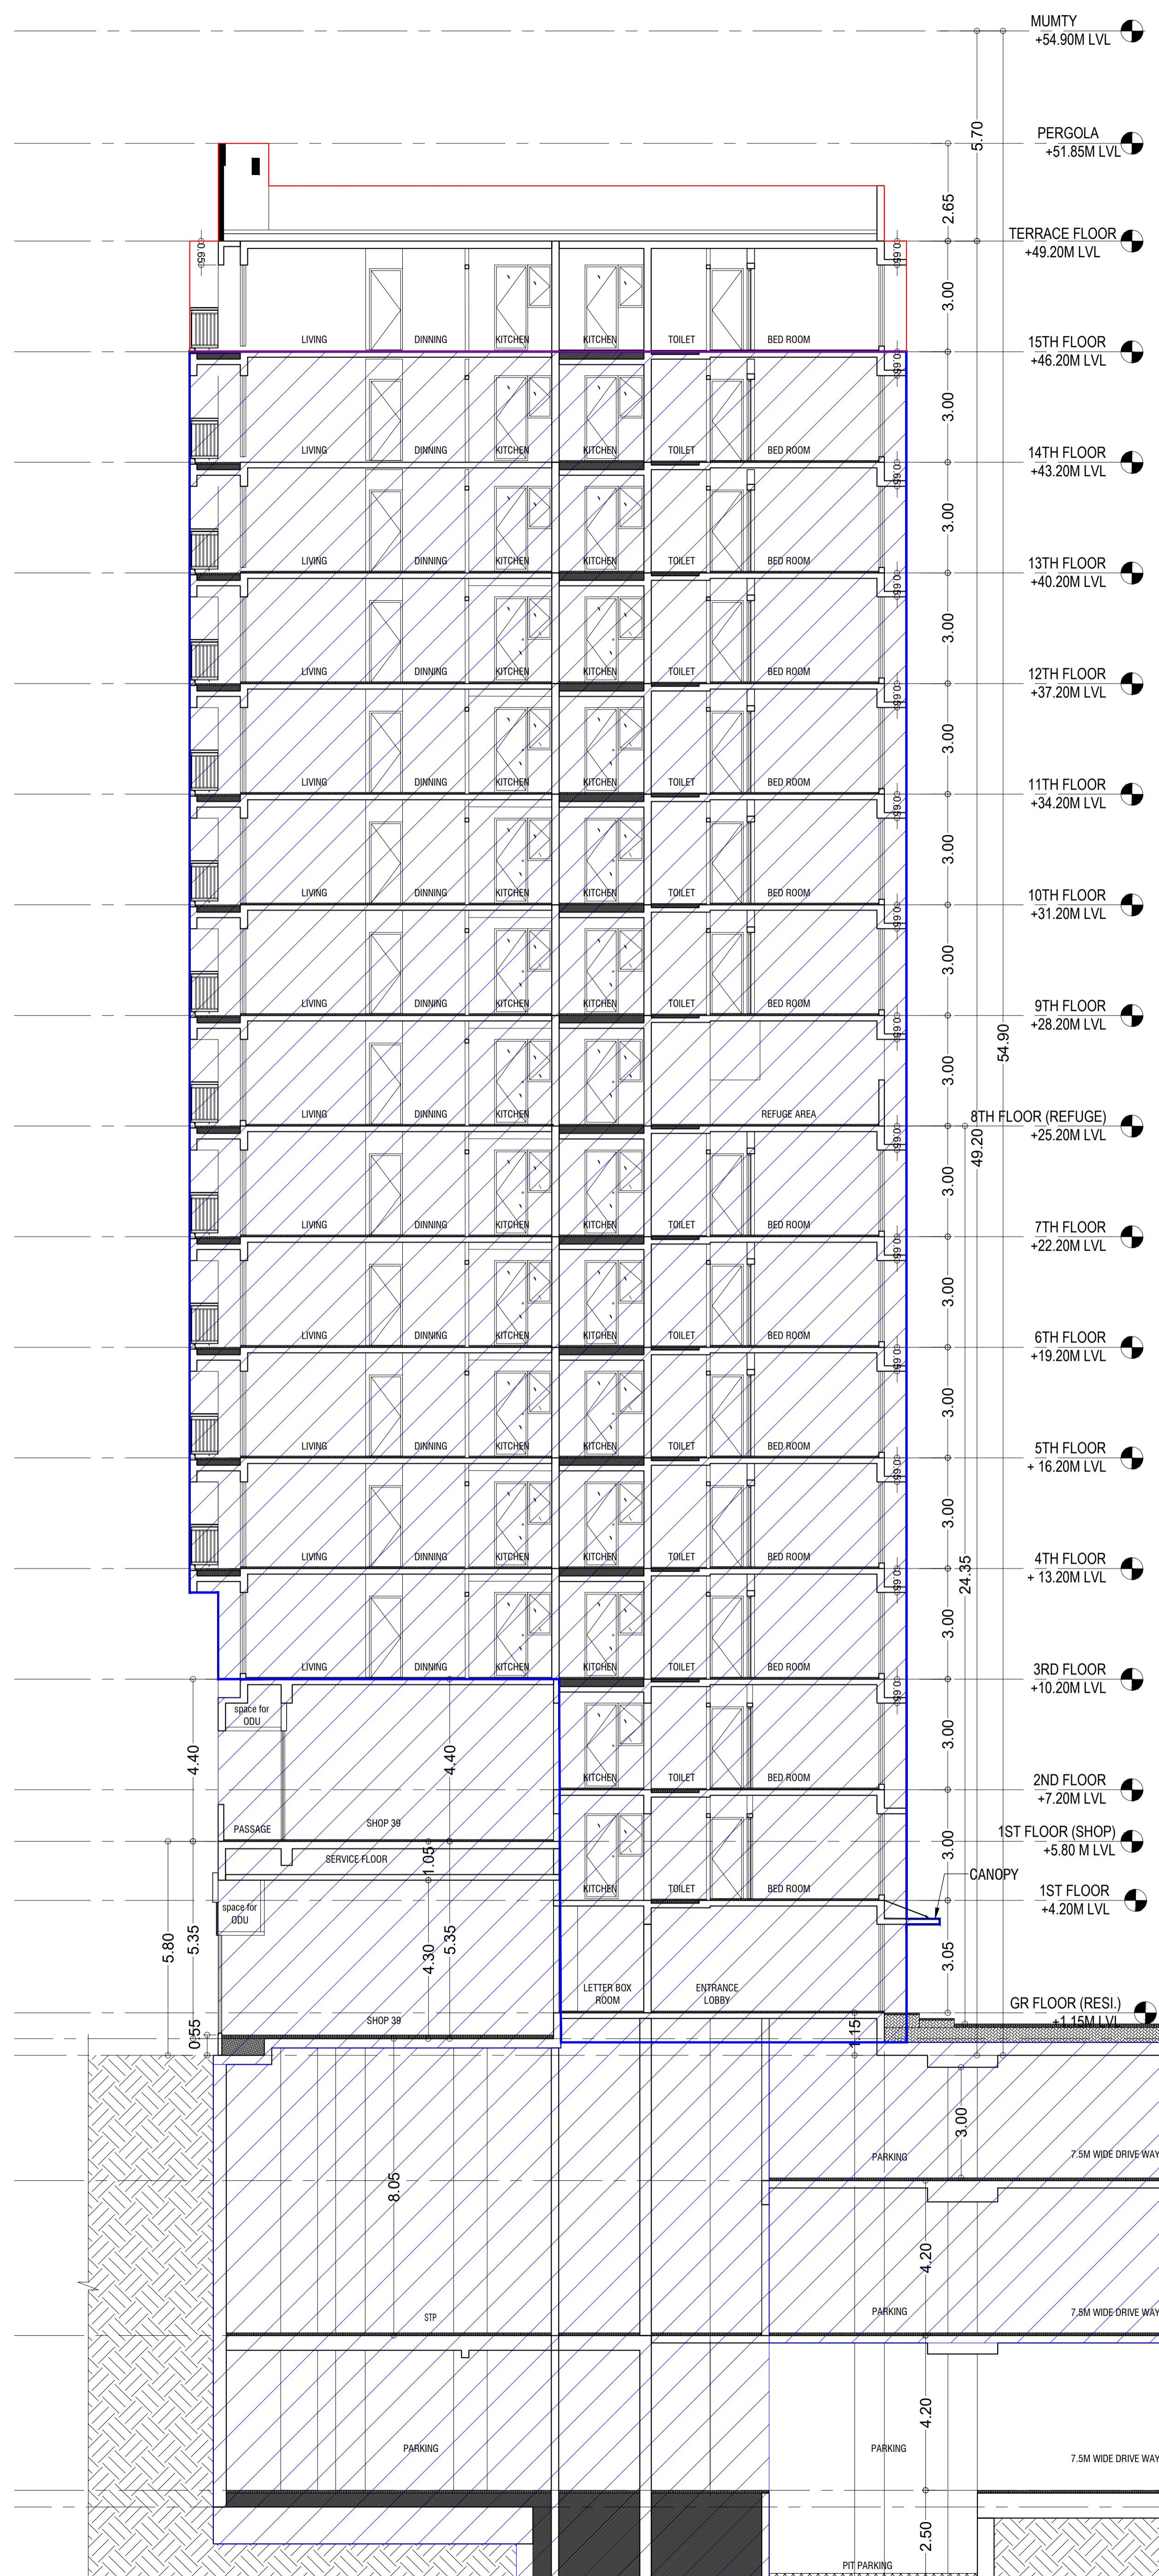

SECTION BB
(Tower-8)

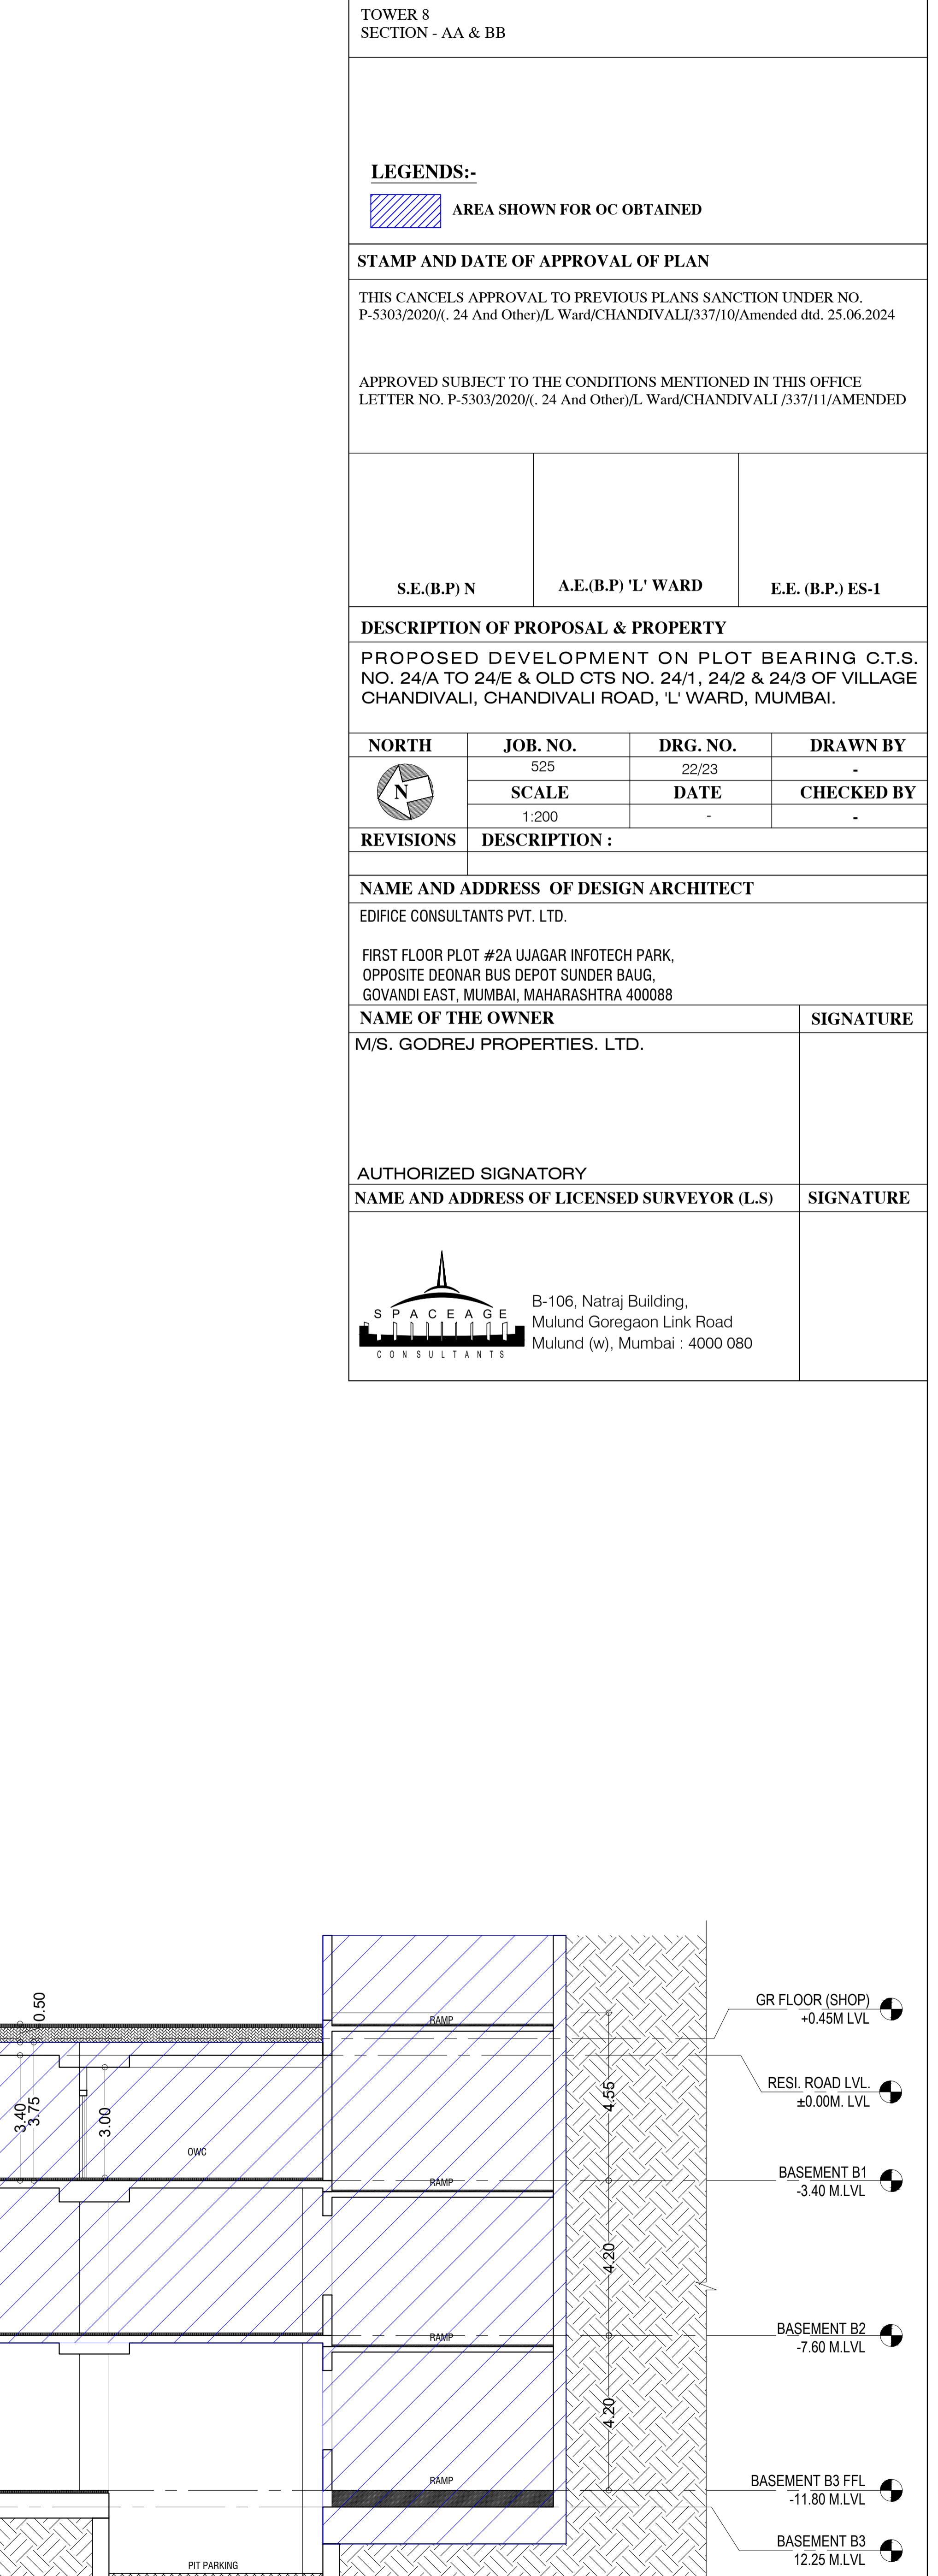


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RESI. ROAD LVL. ±0.00M LVL
BASEMENT B1 -3.40 M.LVL
BASEMENT B2 -7.60 M.LVL
BASEMENT B3 FFL -11.80 M.LVL
BASEMENT B3 12.25 M.LVL

CONTENTS OF SHEET

TOWER 9
SECTION - AA & BB



SECTION AA
(Tower-9)

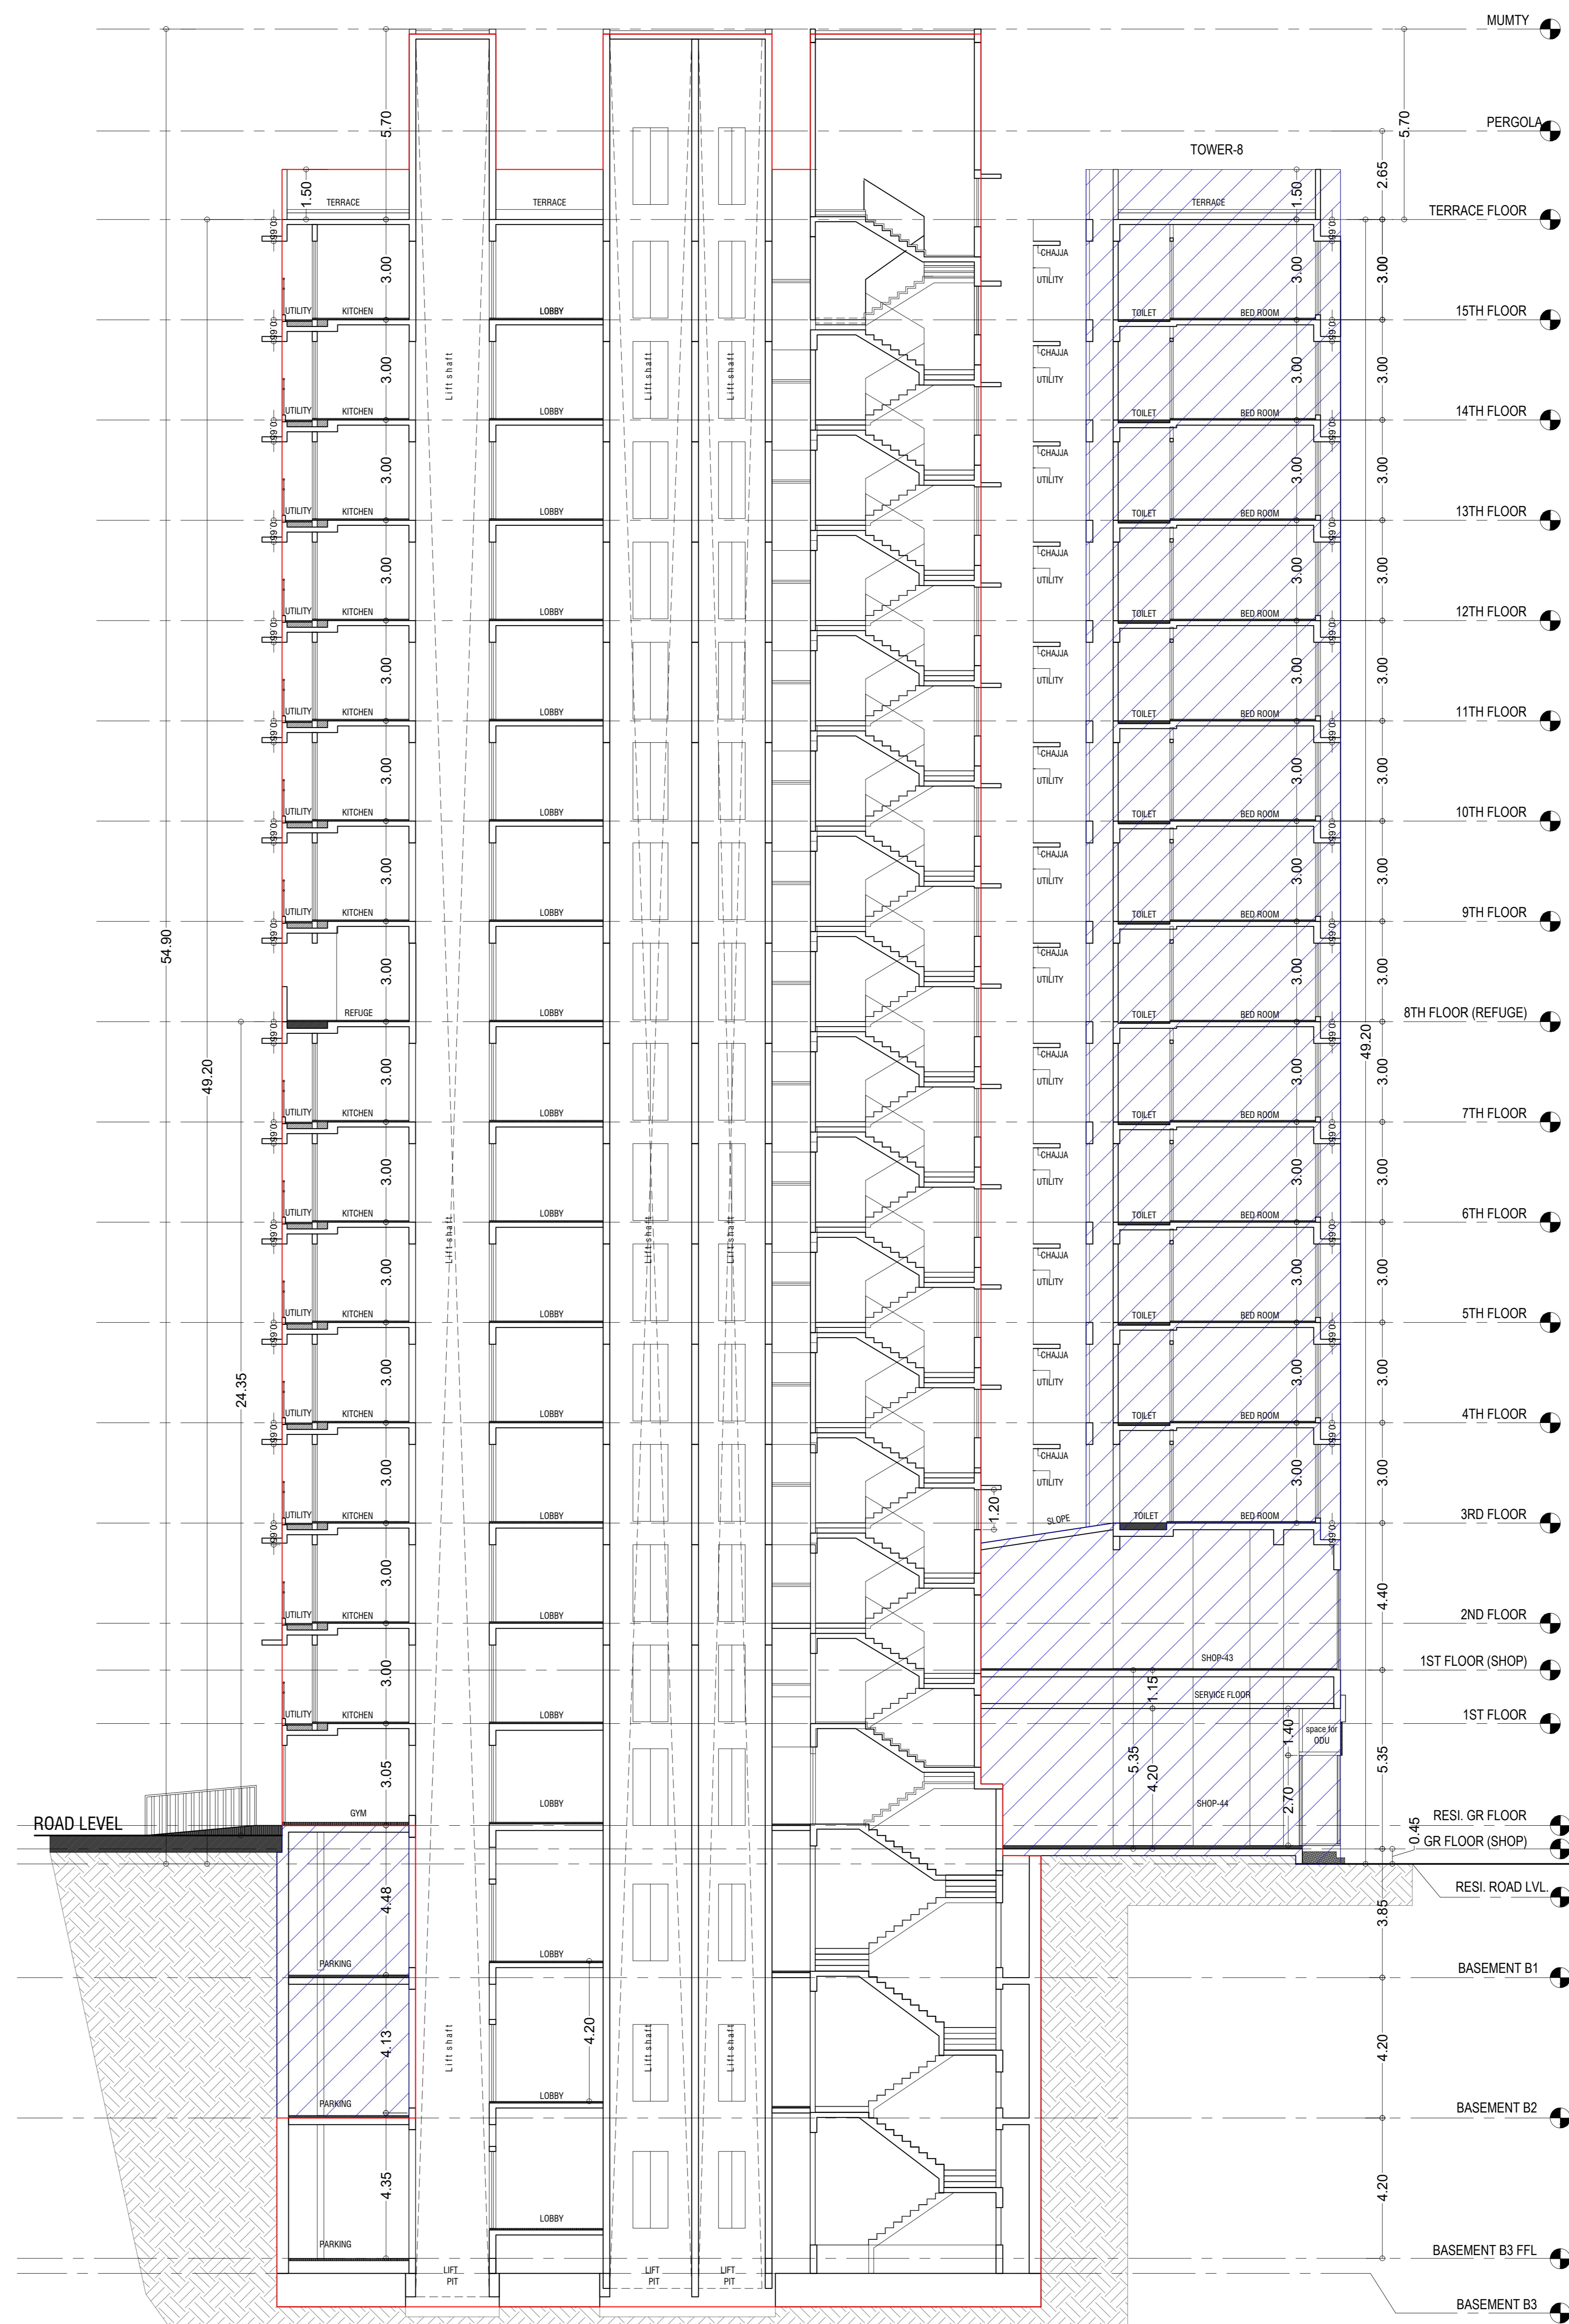

SECTION BB
(Tower-9)

LEGENDS:-

AREA SHOWN FOR OC OBTAINED

STAMP AND DATE OF APPROVAL OF PLAN

THIS CANCELS APPROVAL TO PREVIOUS PLANS SANCTION UNDER NO. P-5303/2020/(. 24 And Other)/L Ward/CHANDIVALI/337/10/Amended dtd. 25.06.2024

APPROVED SUBJECT TO THE CONDITIONS MENTIONED IN THIS OFFICE LETTER NO. P-5303/2020/(. 24 And Other)/L Ward/CHANDIVALI /337/11/AMENDED

S.E.(B.P) N	A.E.(B.P) 'L' WARD	E.E. (B.P.) ES-1
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DESCRIPTION OF PROPOSAL & PROPERTY

PROPOSED DEVELOPMENT ON PLOT BEARING C.T.S. NO. 24/A TO 24/E & OLD CTS NO. 24/1, 24/2 & 24/3 OF VILLAGE CHANDIVALI, CHANDIVALI ROAD, 'L' WARD, MUMBAI.

NORTH	JOB. NO.	DRG. NO.	DRAWN BY
	525	23/23	-
	SCALE	DATE	CHECKED BY
	1:200	-	-

REVISIONS DESCRIPTION :

NAME AND ADDRESS OF DESIGN ARCHITECT

EDIFICE CONSULTANTS PVT. LTD.

FIRST FLOOR PLOT #2A UJAGAR INFOTECH PARK, OPPOSITE DEONAR BUS DEPOT SUNDER BAUG, GOVANDI EAST, MUMBAI, MAHARASHTRA 400088

NAME OF THE OWNER	SIGNATURE
M/S. GODREJ PROPERTIES. LTD.	

AUTHORIZED SIGNATORY

NAME AND ADDRESS OF LICENSED SURVEYOR (L.S)	SIGNATURE