


STAMP OF DATE OF RECEIPT OF PLAN

Plans are approved Subject to conditions  
Prescribed in Form No. W-26, dated 15/3/20  
Tamil Nadu Building Regulation & Code Act, 1956  
As amended by Act No. 10 of 1962 & Act No. 10 of 1973  
City Engineer  
(TDD)  
The City of Thane  
Thane Municipal Corporation

STAMP OF APPROVAL OF PLAN

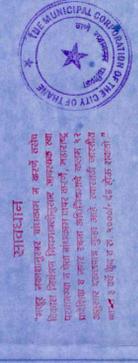

प्राप्त प्रमाणित नकाशा अर्जावरून  
नकाशा प्रमाणित करण्यात आला आहे.  
नकाशा अर्जावरून प्रमाणित करण्यात आला आहे.  
नकाशा अर्जावरून प्रमाणित करण्यात आला आहे.  
नकाशा अर्जावरून प्रमाणित करण्यात आला आहे.

CERTIFICATE OF AREA  
CERTIFIED THAT THE FLOOR REFERENCE WAS SURVEYED BY ME ON  
THE DIMENSIONS OF SIZES, ETC. OF PLOT STATED ON PLAN ARE AS MEASURED ON SITE AND  
THE AREA SO WORKED OUT TALLIES WITH THE AREA STATED IN DOCUMENTS OWNERSHIP.


DESCRIPTION OF PROPOSAL  
PLOT A - PROPOSED LAYOUT ON PLOT BEARING S NO. - 1721, 175, 1761,  
1765, 176/6, 1767, 2837/C, 2838/C, AT VILLAGE - MAJWADE,  
& DIST. - THANE.

ADDRESS OF DEVELOPER / OWNER  
**OBEROI REALTY LTD.**  
Commerz. 3rd Floor, International Business Park  
Oberoi Garden City, Off Western Express Highway,  
Conegaon (East), Mumbai - 400 012, 6677 3392  
TEL. - 91 22 6677 3392 Fax - 91 22 6677 3392


OWNER (S) name and signature -  
ARCHITECT

RAJESH KUSHOR DIGHE  
CONSULTANTS SERVICES  
10/11, 12, JARA COMMERCIAL COMPLEX,  
NEAR VASANT VIHAR,  
THANE (WEST) - 400 610

Sheet No. AS SHOWN AS SHOWN  
Scale: AS SHOWN AS SHOWN  
Checked By:  
Drawn By:  
Date:

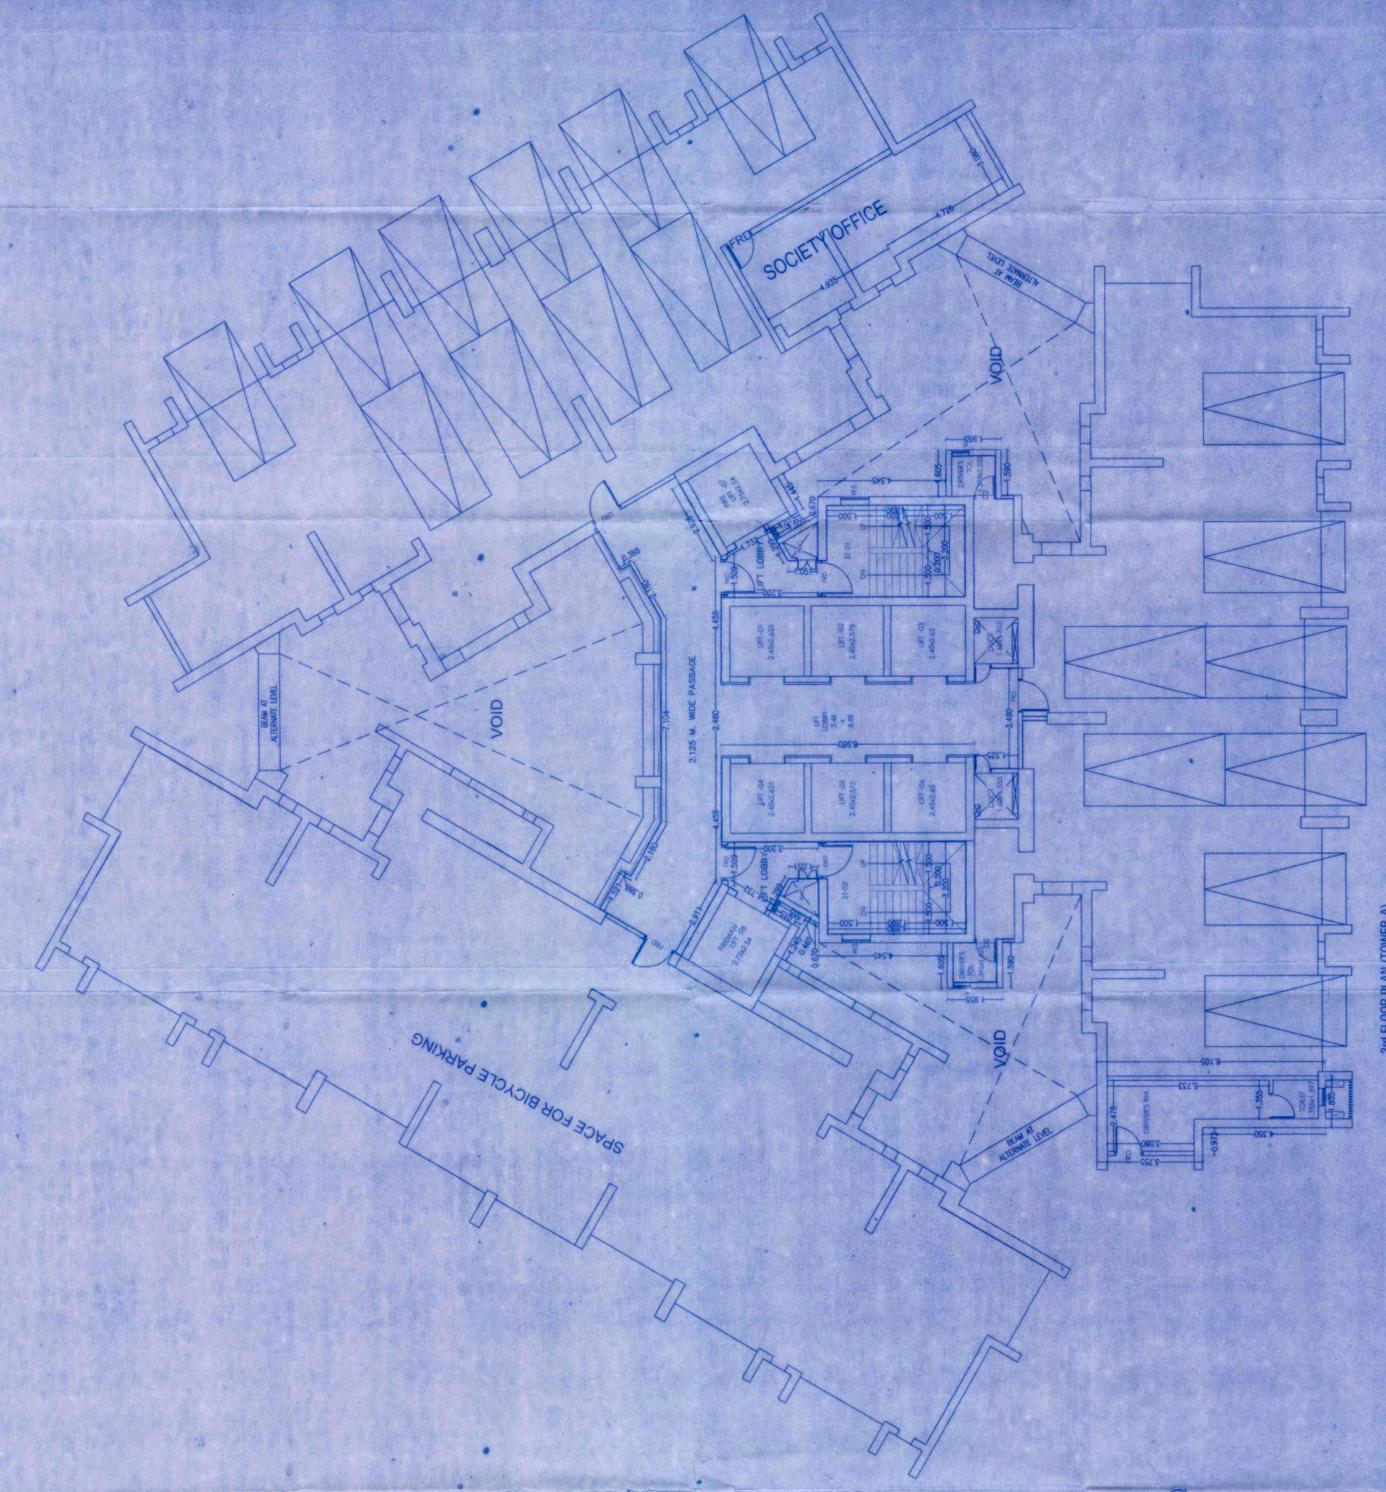


3RD FLOOR PLAN (TOWER-A)  
SCALE: 1:100

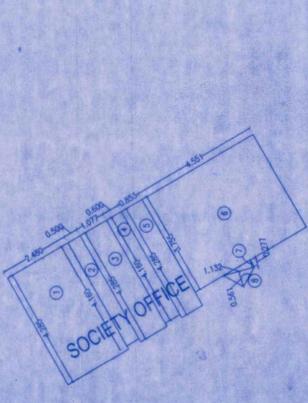

AREA LINE DIAGRAM FOR SOCIETY OFFICE 3RDFLOOR (TOWER-A)  
SCALE: 1:100

BUILT UP AREA CALCULATION  
FOR SOCIETY OFFICE 3RDFLOOR


1	4.285 X 2.480 X 180	=	10.63 SQ.MT
2	4.100 X 0.500 X 180	=	3.69 SQ.MT
3	4.225 X 1.077 X 180	=	4.67 SQ.MT
4	4.100 X 0.600 X 180	=	2.50 SQ.MT
5	4.285 X 0.653 X 180	=	3.66 SQ.MT
6	3.725 X 4.551 X 180	=	17.08 SQ.MT
7	1/2 X 1.132 X 0.277 X 180	=	0.18 SQ.MT
8	1/2 X 1.132 X 0.581 X 180	=	0.32 SQ.MT
TOTAL ADDITION		=	41.05 SQ.MT

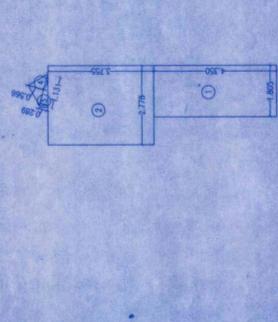

AREA LINE DIAGRAM FOR DRIVERS RM. 3RDFLOOR (TOWER-A)  
SCALE: 1:100

BUILT UP AREA CALCULATION  
FOR DRIVERS RM. 3RDFLOOR


1	1.850 X 4.350 X 180	=	7.26 SQ.MT
2	2.778 X 3.755 X 180	=	10.44 SQ.MT
3	1/2 X 1.13 X 0.28 X 180	=	0.18 SQ.MT
4	1/2 X 1.13 X 0.57 X 180	=	0.32 SQ.MT
TOTAL ADDITION		=	18.18 SQ.MT

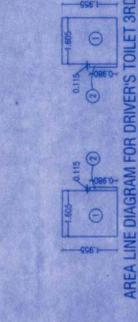

AREA LINE DIAGRAM FOR DRIVERS TOILET 3RD FLOOR (TOWER-A)  
SCALE: 1:100

BUILT UP AREA CALCULATION  
3RD FLOOR

1	1.850 X 1.925 X 2.805	=	6.18 SQ.MT
2	0.115 X 0.880 X 2.805	=	0.32 SQ.MT
TOTAL ADDITION		=	6.50 SQ.MT
TOTAL BUILT UP AREA (R + XI + X2)		=	66.31 SQ.MT

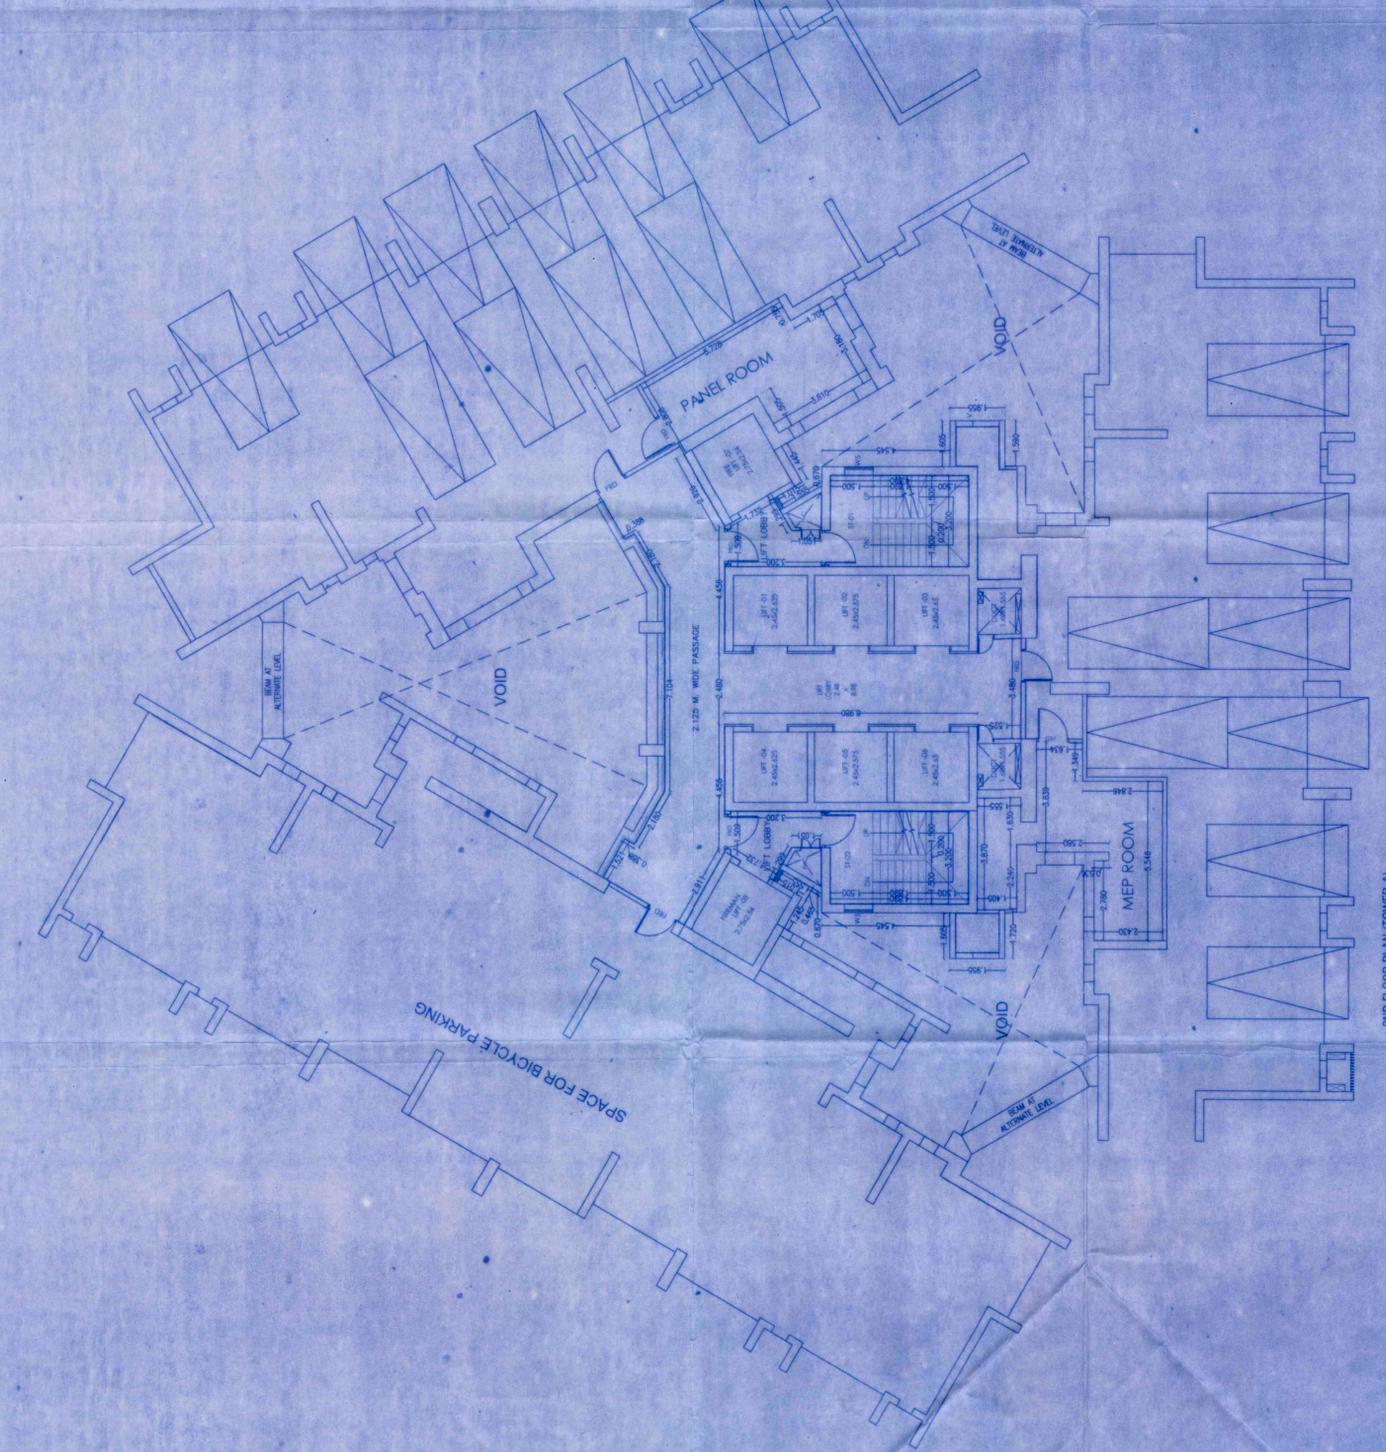

2ND FLOOR PLAN (TOWER-A)  
SCALE: 1:100