




PLOT AREA DIAGRAM
SCALE - 1:500

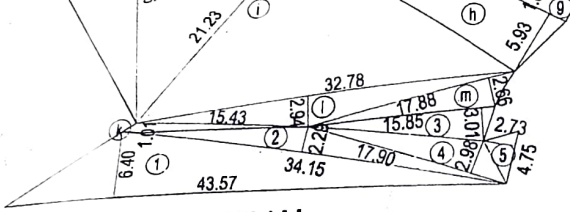

AREA UNDER ROAD			
TOTAL	1/2 X 18.04 X 2.66 X 1	NO	= 23.99
1	1/2 X 43.57 X 6.40 X 1	NO	= 139.42
2	1/2 X 34.15 X 2.29 X 1	NO	= 39.10
3	1/2 X 15.85 X 3.01 X 1	NO	= 23.85
4	1/2 X 17.90 X 2.98 X 1	NO	= 26.67
5	1/2 X 4.36 X 2.73 X 1	NO	= 5.96
TOTAL			= 235.00
TOTAL PLOT AREA			= 2247.05 SQ.M.

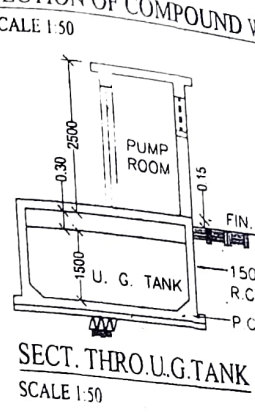


R.G. AREA CALCULATION

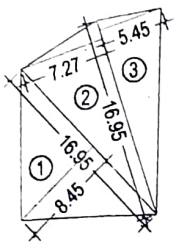


		SQ.MT.
1	1/2 X 16.95 X 8.45 X 1	NO = 71.61
2	1/2 X 16.95 X 7.27 X 1	NO = 61.61
3	1/2 X 16.95 X 5.45 X 1	NO = 46.19
TOTAL ADDITION		= 179.41


R.G. AREA DIAGRAM
SCALE - 1:500

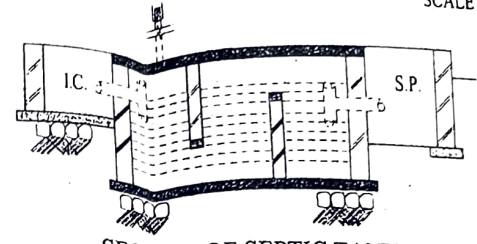

SECTION OF SEPTIC TANK
SCALE 1:50

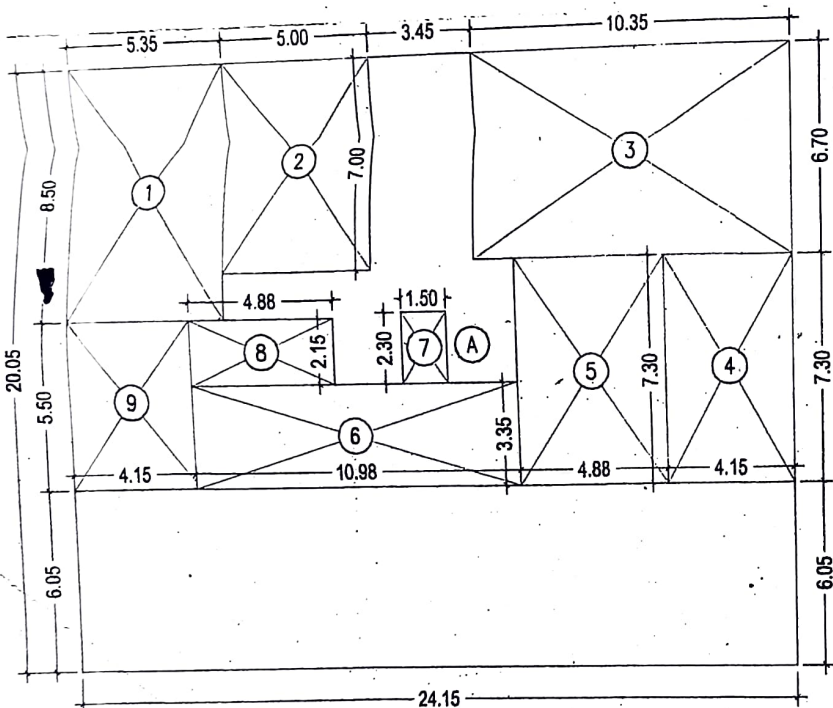


AREA DIAGRAM FOR GROUND FLOOR.
SCALE - 1:200

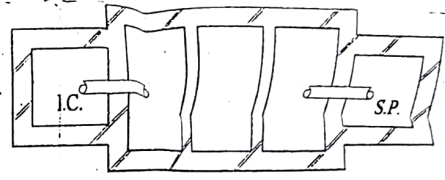






PLAN OF SEPTIC TANK
SCALE 1:50

BUILT UP AREA CALCULATION

GROUND FLOOR			SQ.MT.
A	24.15 X 20.05 X 1	NO	= 484.21
TOTAL ADDITION			= 484.21
DEDUCTIONS			
1	5.35 X 8.50 X 1	NO	= 45.48
2	5.00 X 7.00 X 1	NO	= 35.00
3	10.35 X 6.70 X 1	NO	= 69.35
4	4.15 X 7.30 X 1	NO	= 30.29
5	4.88 X 7.30 X 1	NO	= 35.62
6	10.98 X 3.35 X 1	NO	= 36.78
7	1.50 X 2.30 X 1	NO	= 3.45
8	4.88 X 2.15 X 1	NO	= 10.49
9	4.15 X 5.50 X 1	NO	= 22.82
TOTAL DEDUCTION			= 289.28
TOTAL BUILT UP AREA			= 194.93


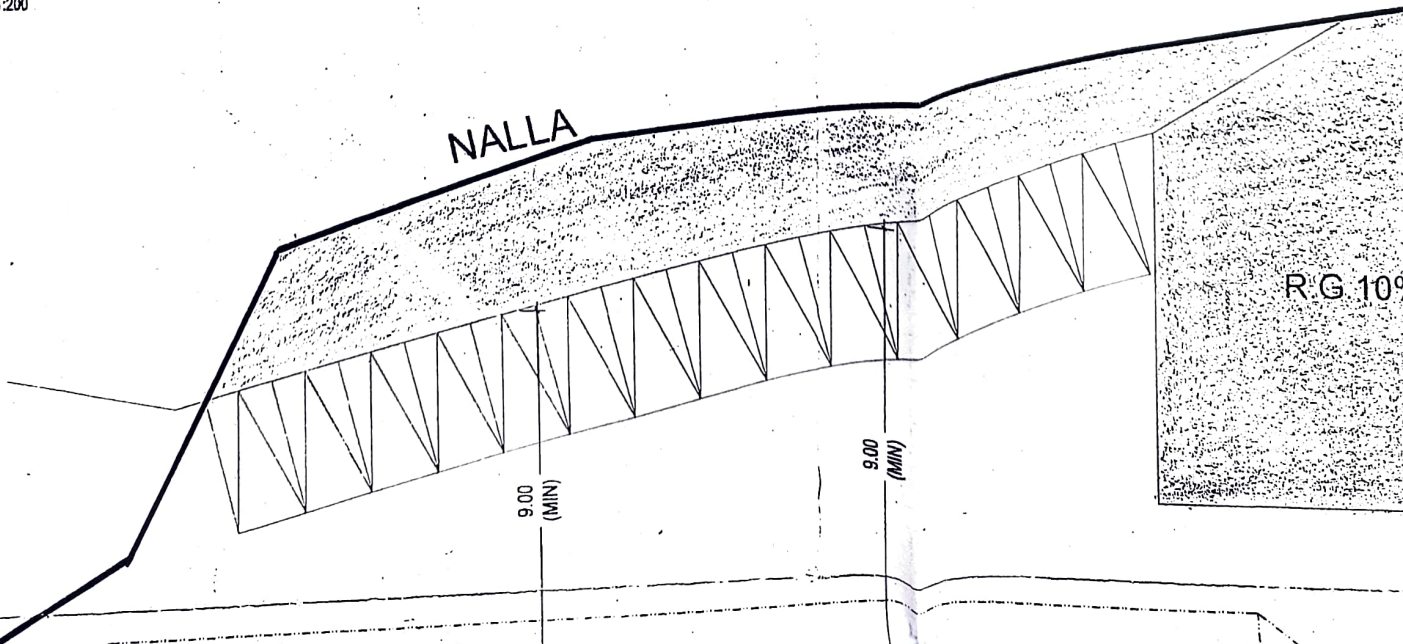


AREA	REMARKS
32	ROLLING SHUTTER
26	T.W. PANNELLED DOOR
94	T.W. PANNELLED DOOR
50	T.W. PANNELLED DOOR
16	T.W. GLAZED WINDOW
10	T.W. GLAZED WINDOW
4	T.W. GLAZED WINDOW
2	T.W. GLAZED WINDOW
4	T.W. LOUVERS WINDOW

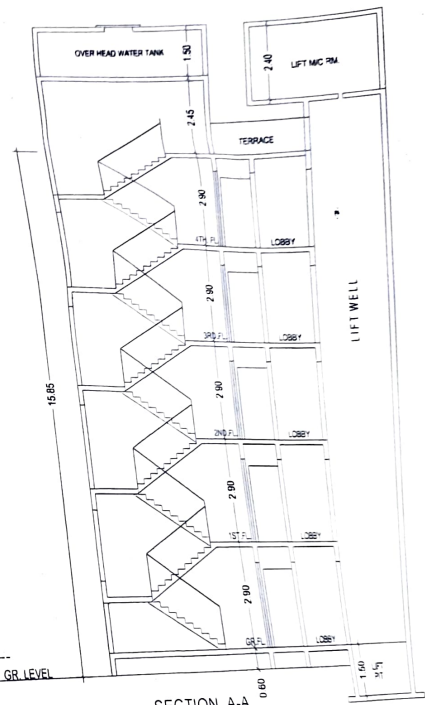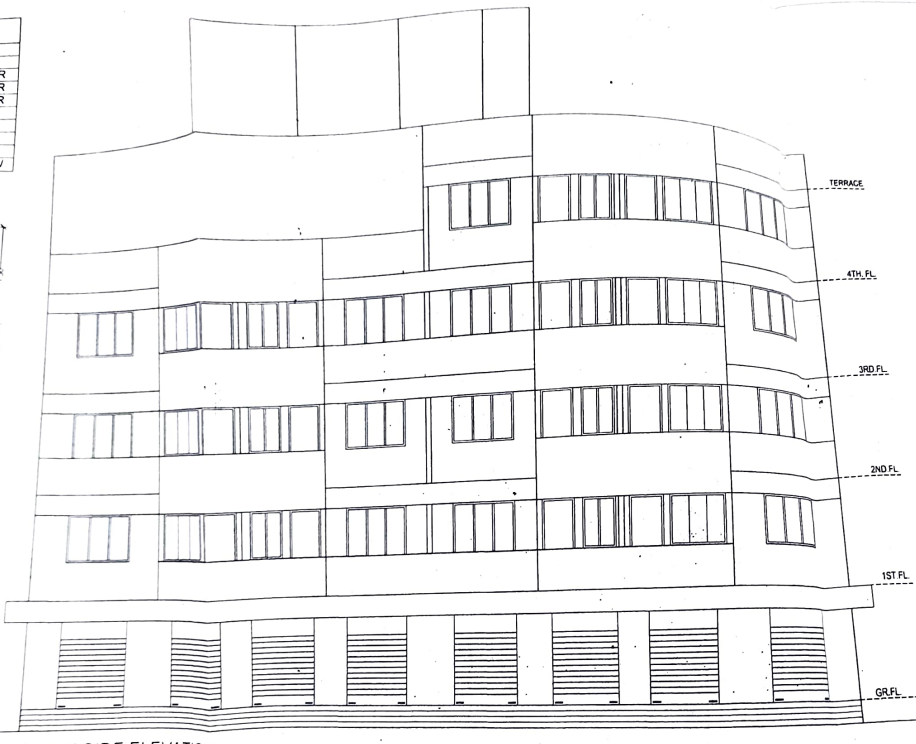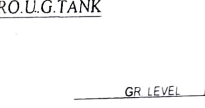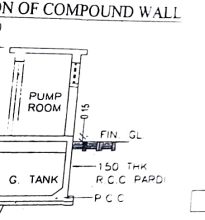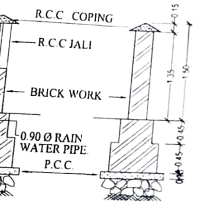

STAMP
SHEET
रजिस्ट्रार
राज्य इंजीनियरिंग
प्रमाणन
विभाग
दिल्ली

PROPOSED SITE

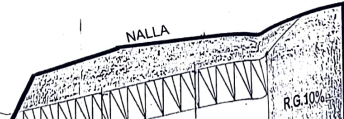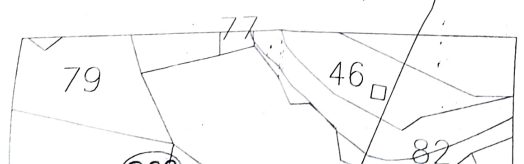


PARKING AREA STATEMENT

RESI AREA	PROP FLAT	CAR PARK
BELOW 35 SQM	22 NOS	—
35 TO 45	—	—
	07 NOS	350 NOS


4TH FLOOR PLAN.

SCALE: 1:100

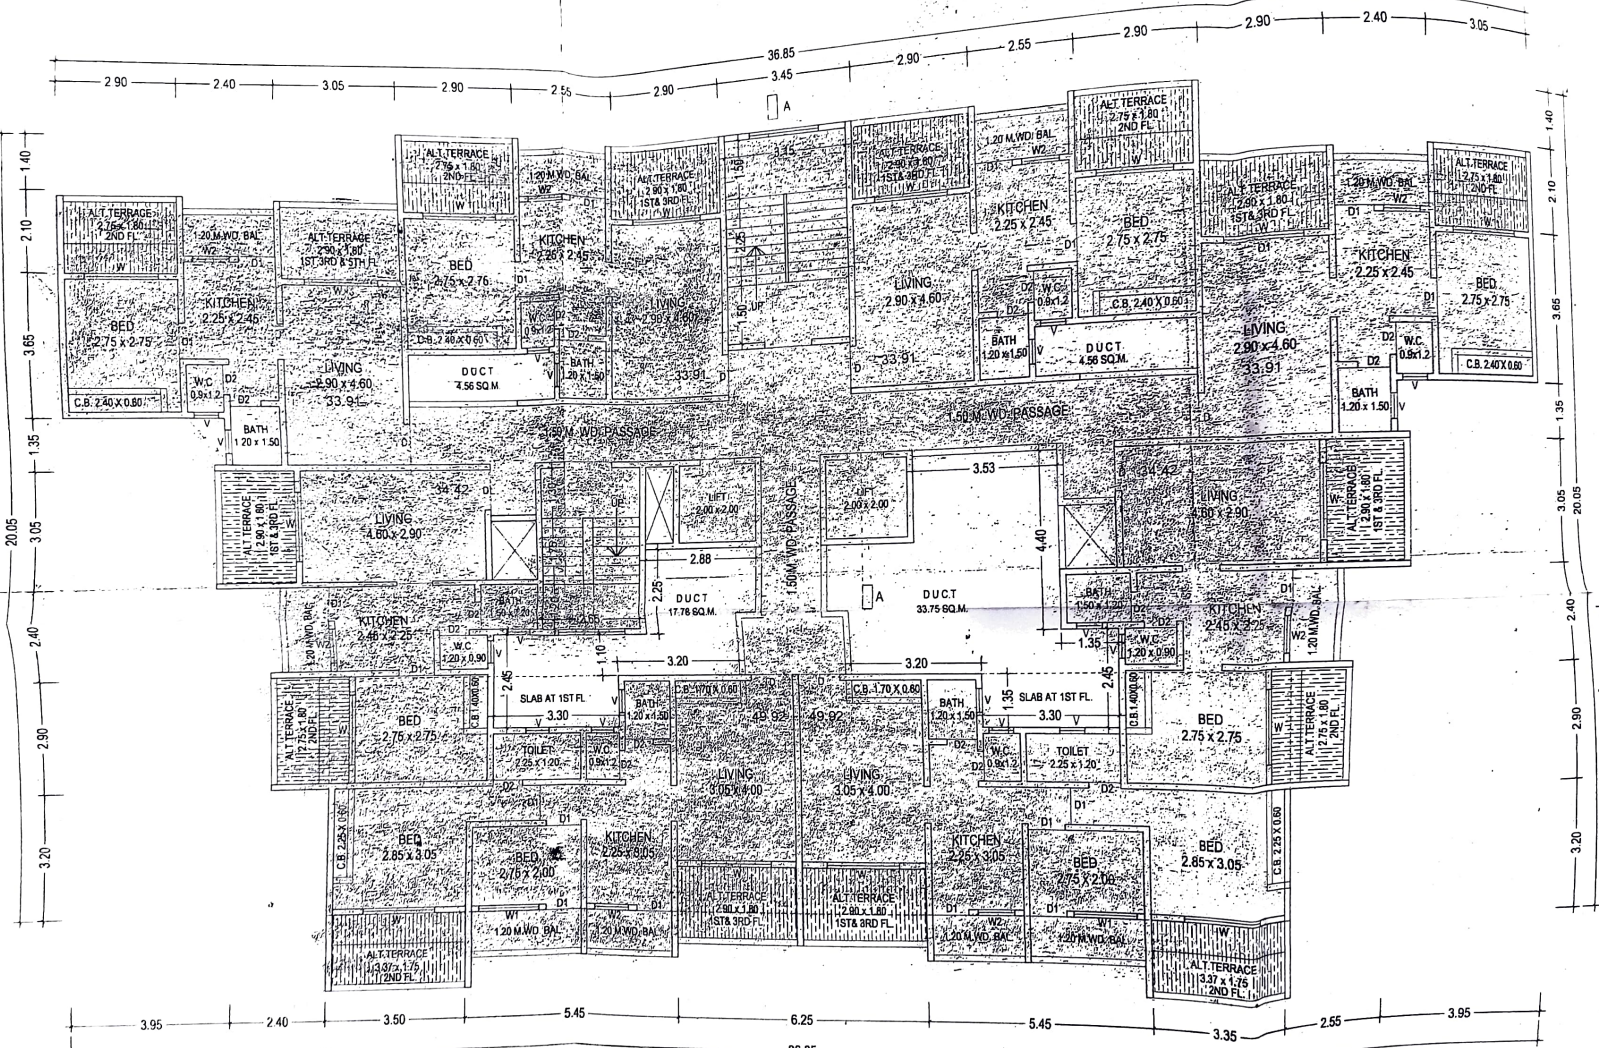

1ST TO 3RD FLOOR PLAN.

SCALE: 1:100

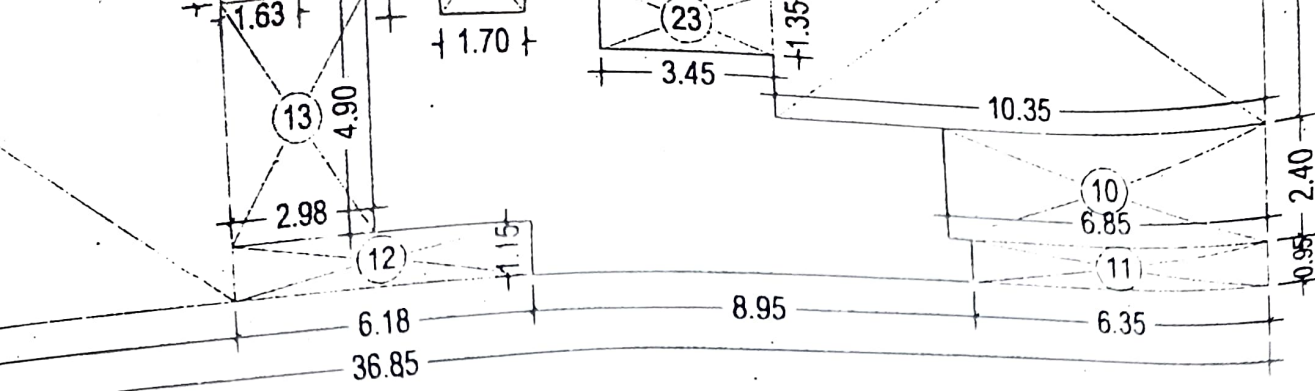

17	2.25
18	1.55
19	2.30
20	5.03
21	4.95
22	1.70
23	3.45
TOTAL DEDUC	
TOTAL BUILT	

4TH FLOOR.

BUILT UP AREA CALCULATION


1ST TO 3RD FLOOR			SQ.MT.
A	36.85 X 20.05 X 1NO	=	738.84
TOTAL ADDITION			= 738.84
DEDUCTIONS			
1	2.90 X 3.50 X 2 NOS	=	20.30
2	2.55 X 3.05 X 2 NOS	=	15.56
3	2.90 X 3.60 X 2 NOS	=	20.88
4	2.90 X 1.85 X 2 NOS	=	10.73
5	2.55 X 1.40 X 2 NOS	=	7.14
6	2.90 X 1.95 X 2 NOS	=	11.31
7	2.40 X 1.95 X 2 NOS	=	9.36
8	1.55 X 1.35 X 2 NOS	=	4.19
9	5.60 X 3.05 X 2 NOS	=	34.16
10	6.40 X 2.40 X 2 NOS	=	30.72
11	6.35 X 6.10 X 2 NOS	=	77.47
12	0.50 X 5.15 X 2 NOS	=	5.15
13	6.25 X 1.15 X 1NO	=	7.19
14	2.25 X 1.80 X 2 NOS	=	8.10
15	1.55 X 1.20 X 2 NOS	=	3.72
16	3.53 X 1.35 X 2 NOS	=	9.53
17	4.88 X 1.55 X 2 NOS	=	15.13
18	3.53 X 1.50 X 2 NOS	=	10.59
19	3.30 X 1.05 X 2 NOS	=	6.93
20	3.90 X 1.40 X 2 NOS	=	10.92
21	1.58 X 1.10 X 2 NOS	=	3.48
22	1.70 X 0.60 X 2 NOS	=	2.04
23	1.63 X 1.65 X 2 NOS	=	5.38
24	2.15 X 1.70 X 2 NOS	=	7.31
25	2.30 X 2.30 X 2 NOS	=	10.58
TOTAL DEDUCTION			= 347.87
TOTAL BUILT UP AREA			= 390.97



ATION.

AREA
12.24
6.26
18.50 SQ.M.
26.42 SQ.M.
NIL

ATION.

AREA
18.36
12.53
30.89 SQ.M.
39.09 SQ.M.
NIL

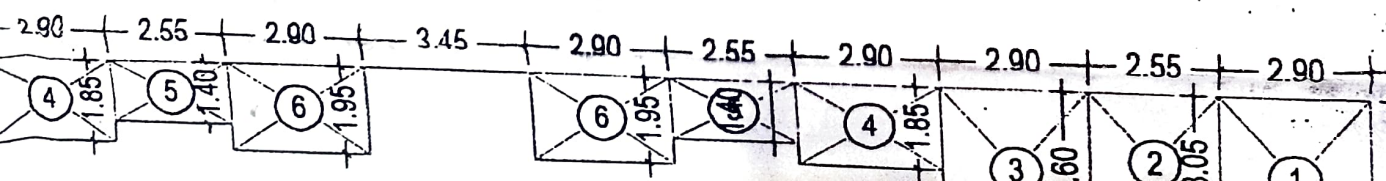

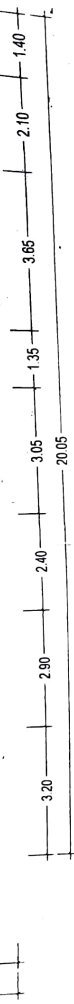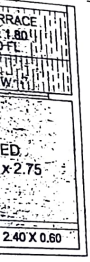

BALCONY AREA CALCULATION.
4TH FLOOR.

FIG.	DESCRIPTION	AREA
B	2.55 x 1.20 x 04	12.24
B1	5.45 x 1.15 x 01	6.26
PROP. BALC. AREA		18.50 SQ.M.
PERMI. BALC. AREA		26.42 SQ.M.
EXCESS BALC. AREA		NIL


BALCONY AREA CALCULATION.
1ST TO 3RD FLOOR.

FIG.	DESCRIPTION	AREA
B	2.55 x 1.20 x 06	18.36
B1	5.45 x 1.15 x 02	12.53
PROP. BALC. AREA		30.89 SQ.M.
PERMI. BALC. AREA		39.09 SQ.M.
EXCESS BALC. AREA		NIL

BUILT UP AREA CALCULATION

1ST TO 3RD FLOOR		SQ.M.
A	36.85 X 20.05 X 1 NO.	= 738.84
TOTAL ADDITION		= 738.84
DEDUCTIONS		
1	2.90 X 3.50 X 2 NOS	= 20.30
2	2.55 X 3.05 X 2 NOS	= 15.56
3	2.90 X 3.60 X 2 NOS	= 20.88
4	2.90 X 1.85 X 2 NOS	= 10.73
5	2.90 X 1.40 X 2 NOS	= 7.14
6	2.50 X 1.95 X 2 NOS	= 11.31
7	2.40 X 1.95 X 2 NOS	= 9.36
8	1.55 X 1.35 X 2 NOS	= 4.19
9	3.60 X 3.05 X 2 NOS	= 34.16
10	6.40 X 2.40 X 2 NOS	= 30.72
11	6.35 X 6.10 X 2 NOS	= 77.47
12	0.50 X 5.15 X 2 NOS	= 5.15
13	6.25 X 1.15 X 1 NO.	= 7.19
14	6.25 X 1.80 X 2 NOS	= 8.10
15	1.55 X 1.20 X 2 NOS	= 3.72
16	3.53 X 1.35 X 2 NOS	= 9.53
17	4.88 X 1.55 X 2 NOS	= 15.13
18	3.53 X 1.50 X 2 NOS	= 10.59
19	3.30 X 1.05 X 2 NOS	= 6.93
20	3.90 X 1.40 X 2 NOS	= 10.93
21	1.58 X 1.10 X 2 NOS	= 3.48
22	1.70 X 0.60 X 2 NOS	= 2.04
23	1.63 X 1.65 X 2 NOS	= 5.38
24	2.15 X 1.70 X 2 NOS	= 7.31
25	2.30 X 2.30 X 2 NOS	= 10.58
TOTAL DEDUCTION		= 347.87
TOTAL BUILT UP AREA		= 390.97

R. A. Thakare
R. A. THAKARE
 CONSULTING STRUCTURAL ENGINEER
 (KDMC Reg. No. 355)

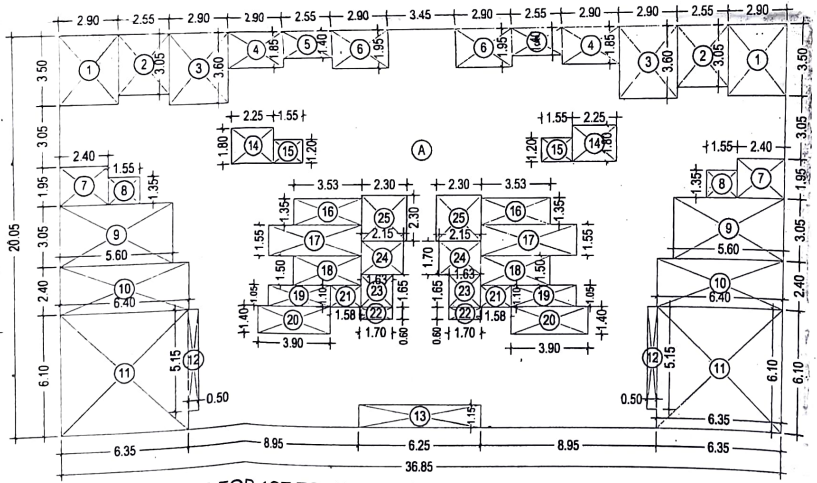

AREA DIAGRAM FOR 1ST TO 3RD FLOOR.
SCALE - 1:200

NAME & SIGNATURE OF OWNER

B. Patil

SHRI. BHIM GATLU PATIL

DESCRIPTION OF PROPOSAL & PROPERTY

PROPOSED BUILDING ON PLOT BEARING S.NO.12 H.NO.2
 MOUJE NANDIVALI PANCHADAND, TAL-KALYAN, DIST-THANE
 FOR. BHIM GATLU PATIL. & 2 OTHERS.

JOB No.	DRG No.	SCALE	DRAWN BY	CHECKED BY	DATE
	1	AS STATED			13-09-17

NAME & SIGNATURE OF ARCHITECT

STHAPATYA NIRMAAN
 Architects & Interior Designers

Shirish G. Nachane

ARCHITECT: SHIRISH G. NACHANE

CA/99/24527


STHAPATYA NIRMAAN
 Architects & Interior Designers

1ST FLOOR KAILAS MANTION, NEAR ADITYA MANGAL KARYALAYA
 GARGAR ROAD, DOMBIVALI (E).

बांधकाम नकाशे मजुरी. रुद्धावित
 रंगाने दुरुस्ती दाखविल्याप्रमाणे व बांधकाम प्रारंभ
 प्रमाणपत्र क्र. कडोमया / नरवि/ बांध/ कुर्वे-डॉवि /-२०१६-१७/४८/१२७
 दिनांक २२/०८/२०१६
 दिलेल्या अटीप्रमाणे.





वि. वि.
 नगर अभियंता कार्यालय
 कल्याण डोंबिवली महानगरपालिका

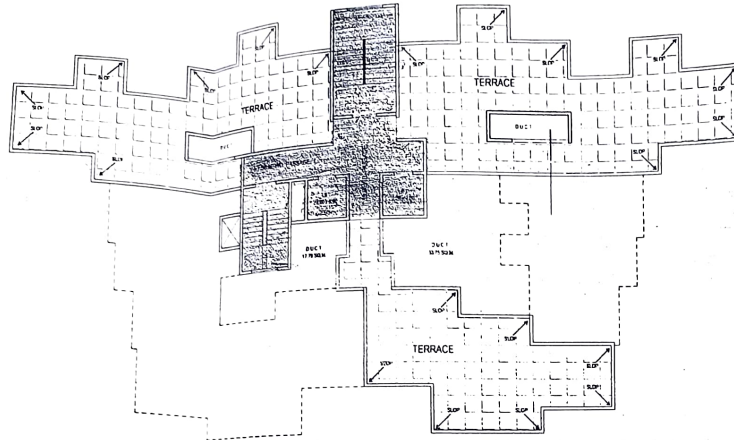

TERRACE FLOOR PLAN.

SCALE: 1:200

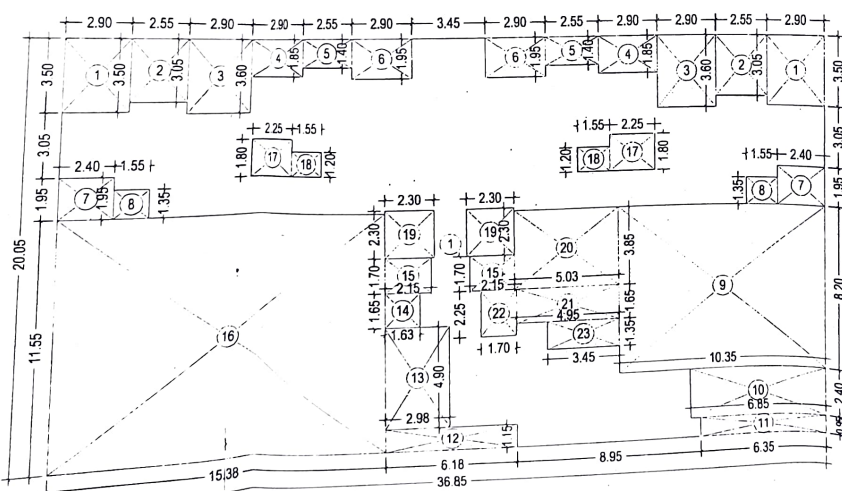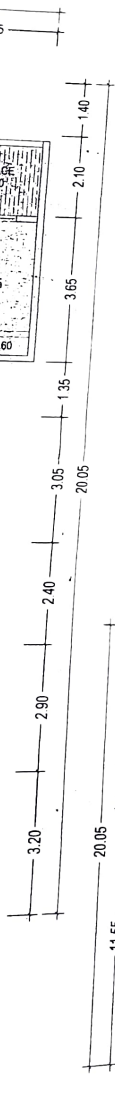


AREA DIAGRAM FOR 4TH FLOOR

SCALE: 1:200

BUILT UP AREA CALCULATION

4TH FLOOR		SO.MT.
1	36.85 X 20.05 X 1 NO	= 738.84
TOTAL ADDITION		= 738.84
DEDUCTIONS		
1	2.90 X 3.50 X 2 NOS	= 20.30
2	2.55 X 3.05 X 2 NOS	= 15.56
3	2.90 X 3.60 X 2 NOS	= 20.88
4	2.90 X 1.85 X 2 NOS	= 10.73
5	2.55 X 1.40 X 2 NOS	= 7.14
6	2.90 X 1.95 X 2 NOS	= 11.31
7	2.40 X 1.95 X 2 NOS	= 9.36
8	1.55 X 1.35 X 2 NOS	= 4.19
9	10.35 X 8.20 X 1 NO	= 84.87
10	6.85 X 2.40 X 1 NO	= 16.44
11	6.35 X 0.95 X 1 NO	= 6.03
12	6.18 X 1.15 X 1 NO	= 7.11
13	2.98 X 4.90 X 1 NO	= 14.60
14	1.63 X 1.65 X 1 NO	= 2.69
15	2.15 X 1.70 X 2 NOS	= 7.31
16	15.38 X 11.55 X 1 NO	= 177.64
17	2.25 X 1.80 X 2 NOS	= 8.10
18	1.55 X 1.20 X 2 NOS	= 3.72
19	2.30 X 2.30 X 2 NOS	= 10.58
20	5.03 X 3.85 X 1 NO	= 19.37
21	4.95 X 1.65 X 1 NO	= 8.17
22	1.70 X 2.25 X 1 NO	= 3.83
23	3.45 X 1.35 X 1 NO	= 4.66
TOTAL DEDUCTION		= 474.59
TOTAL BUILT UP AREA		= 264.25

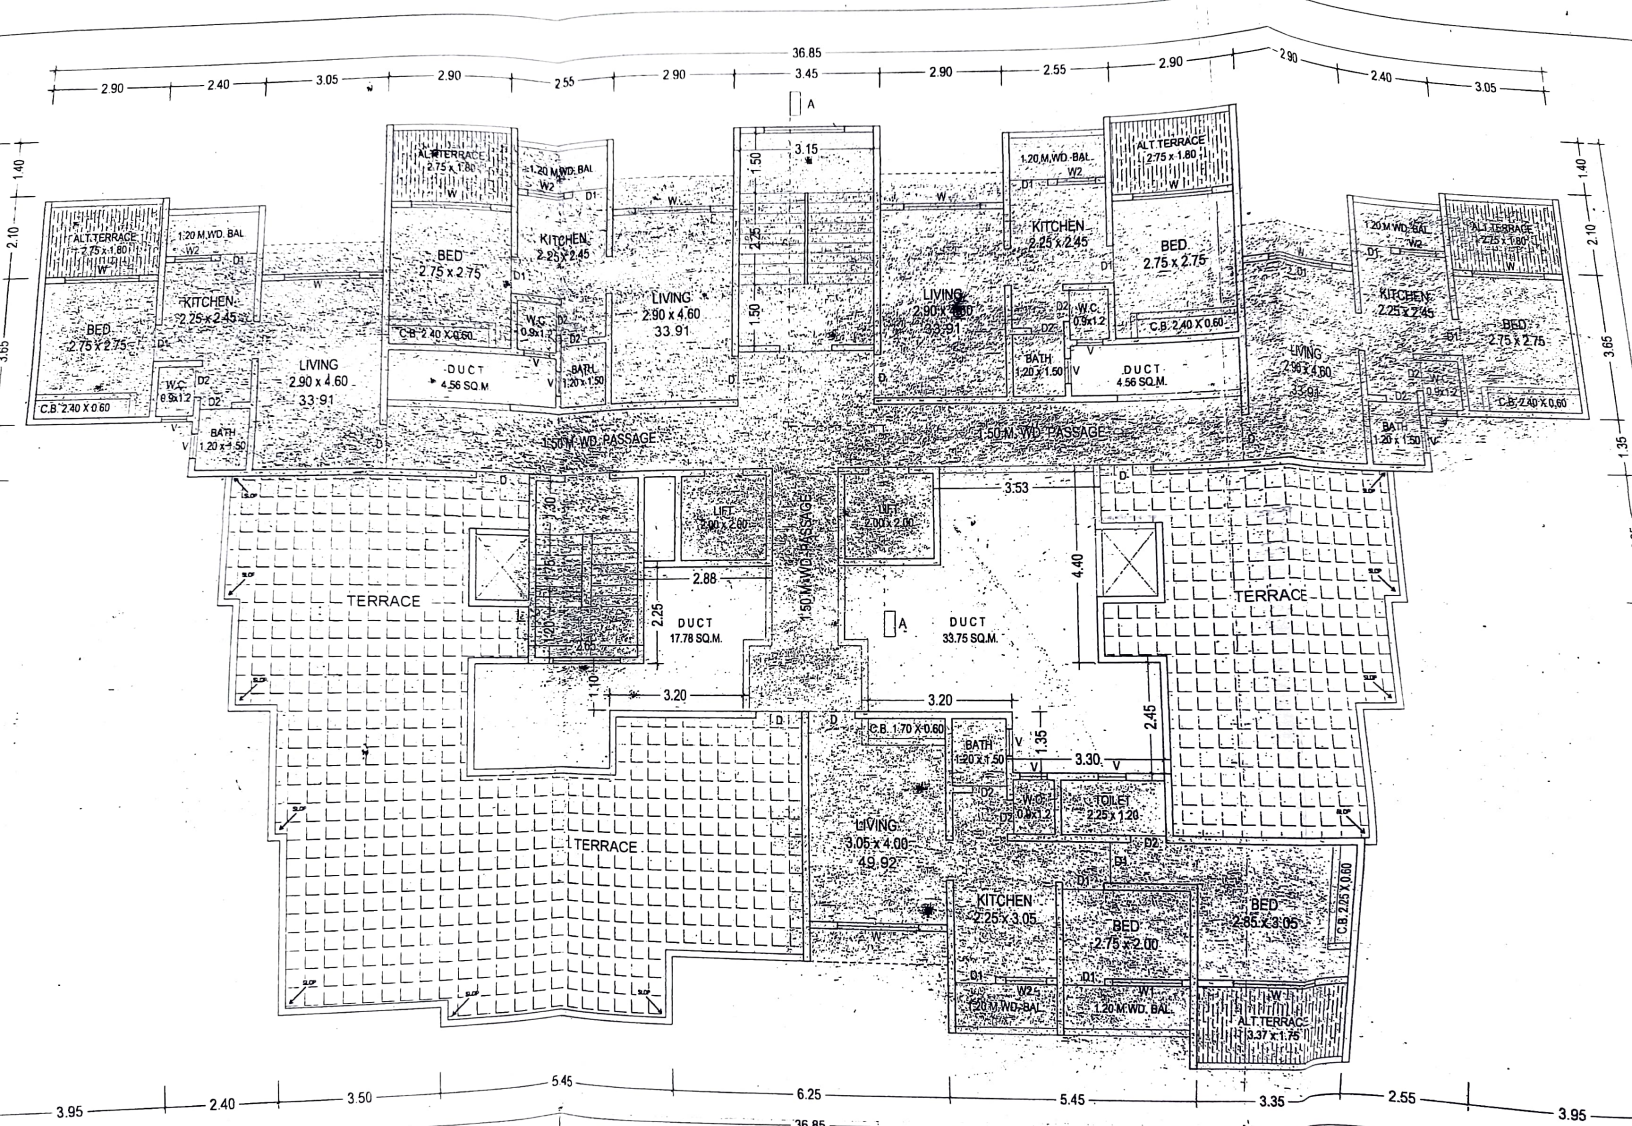

4TH FLOOR PLAN.
SCALE - 1:100

