



BUILT UP AREA CAL FOR 10TH FLOOR (WING-T-2)

ADDITION (X)	Y	Z	AREA	NO.	UNIT	TOTAL
1	1.10	1.10	1.21	1	SQMT	1.21
2	2.40	1.10	2.64	1	SQMT	2.64
3	4.10	1.10	4.51	1	SQMT	4.51
4	5.80	1.10	6.38	1	SQMT	6.38
180	305.00	1.10	335.50	1	SQMT	335.50
181	306.70	1.10	337.37	1	S	


CONTENTS OF SHEET
11th & 18th FLOOR PLAN, 12th & 19th FLOOR PLAN, 13th TO 16th & 20th TO 23rd FLOOR PLAN, 25th FLOOR PLAN, LINE AREA DIAGRAM & AREA CALCULATION. (WING=T-2)

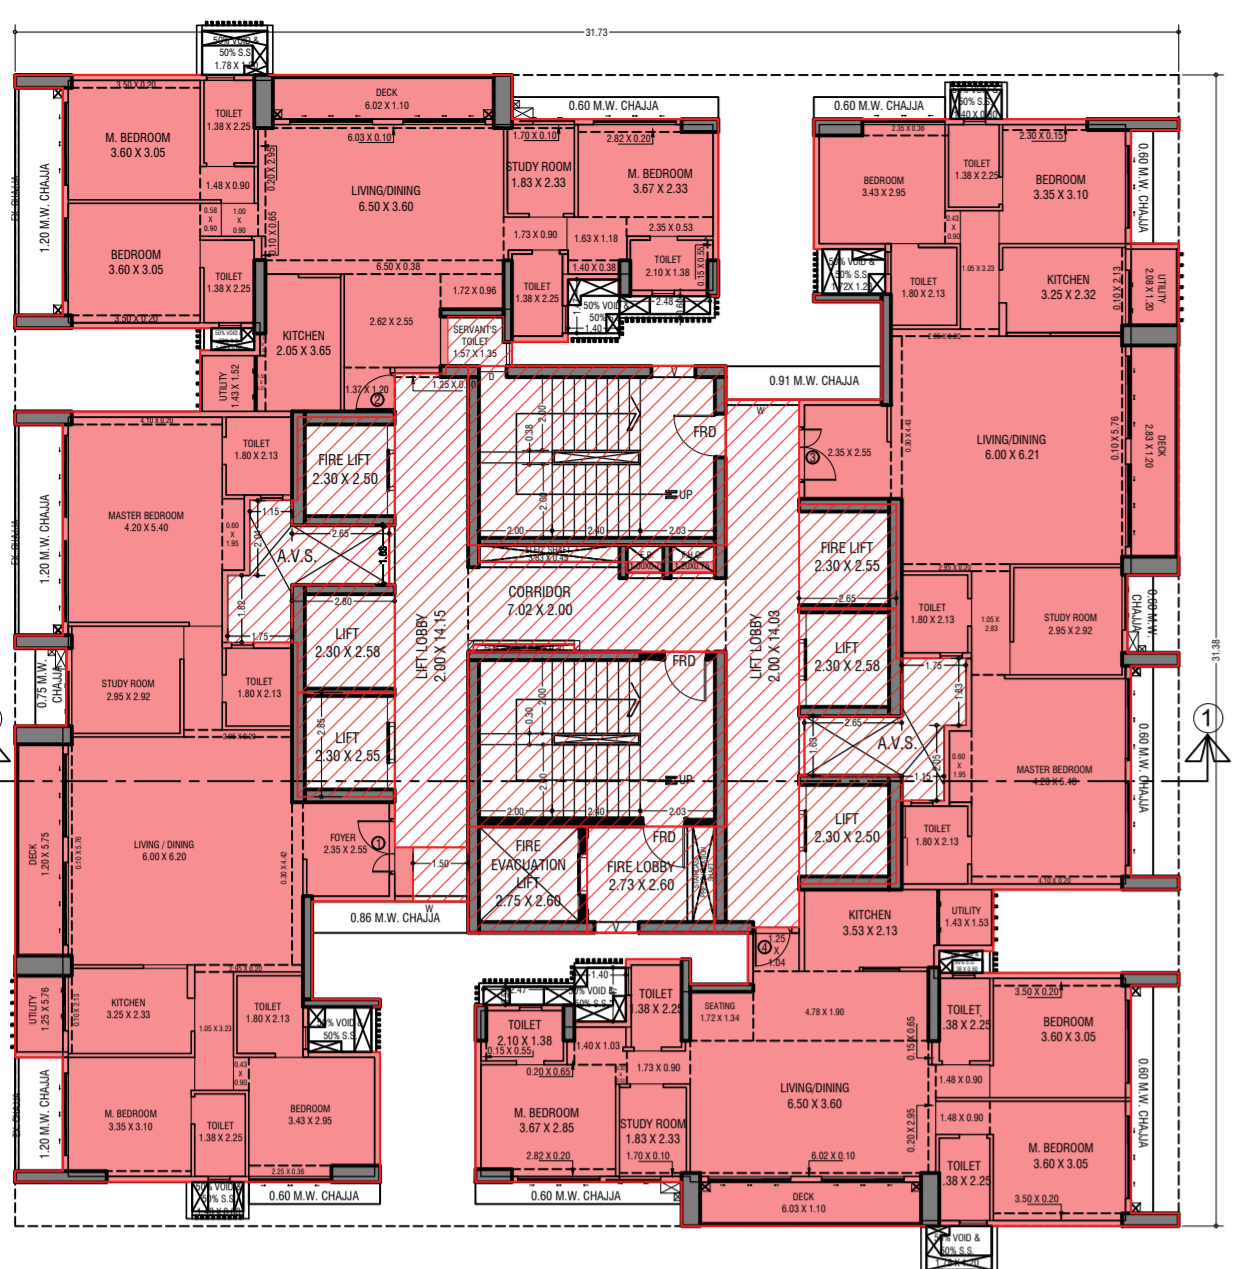

19th FLOOR PLAN (WING=T-2)
SCALE - 1:100

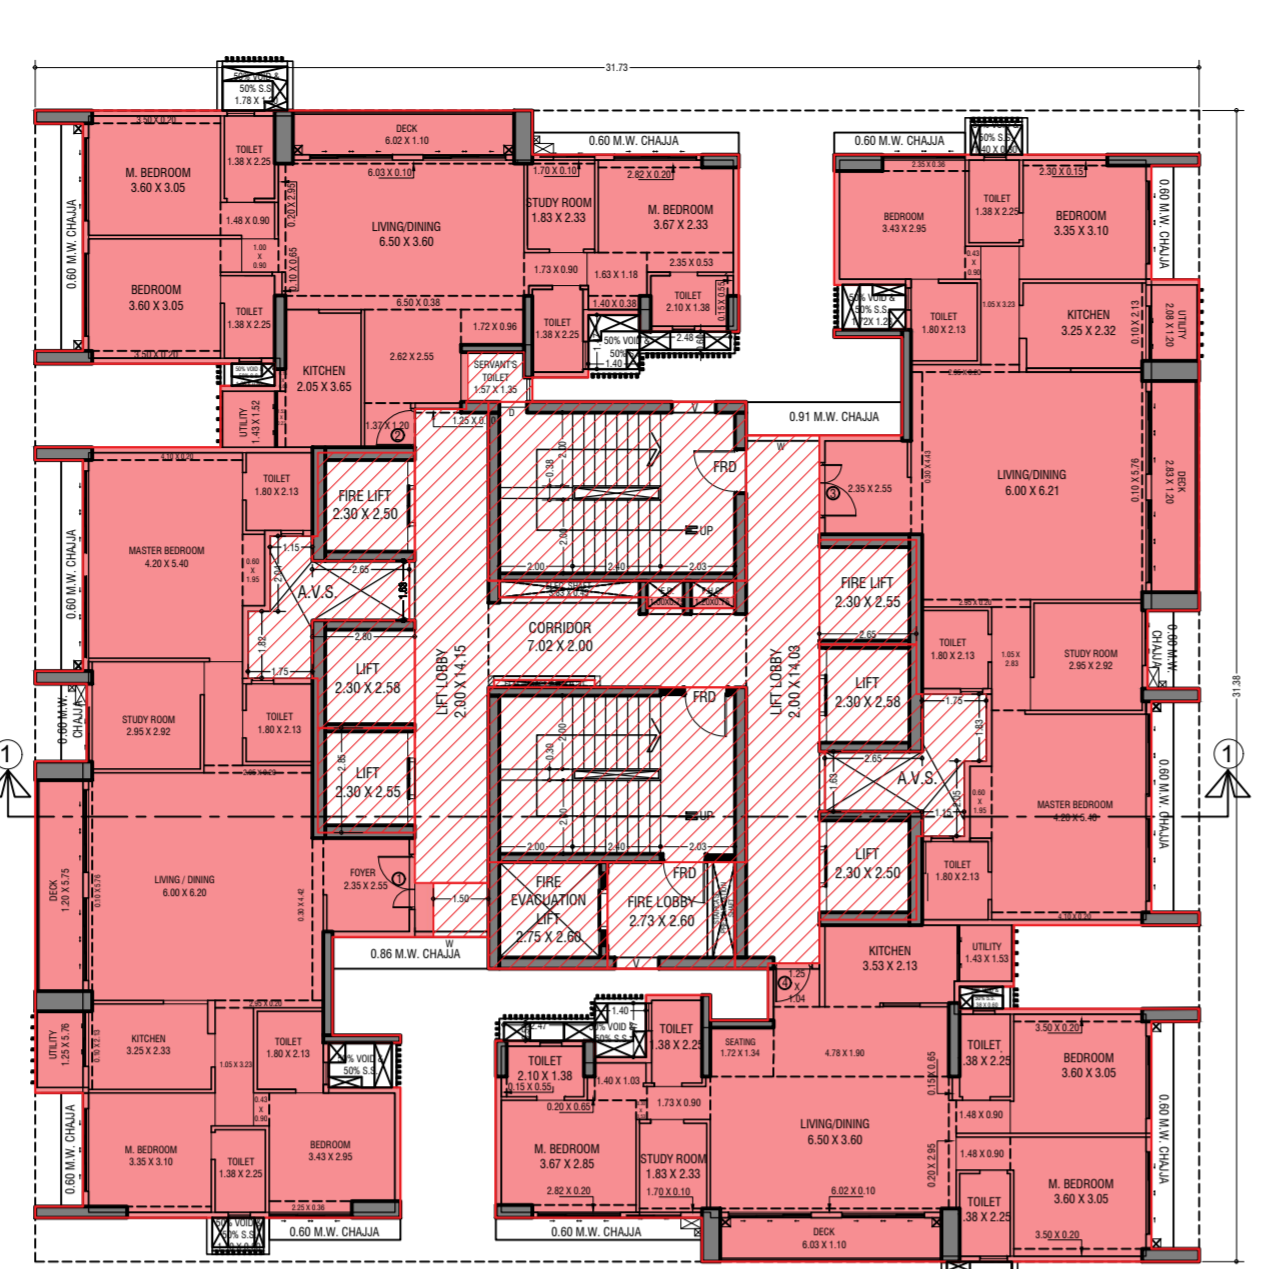

20th TO 23rd FLOOR PLAN (WING=T-2)
SCALE - 1:100

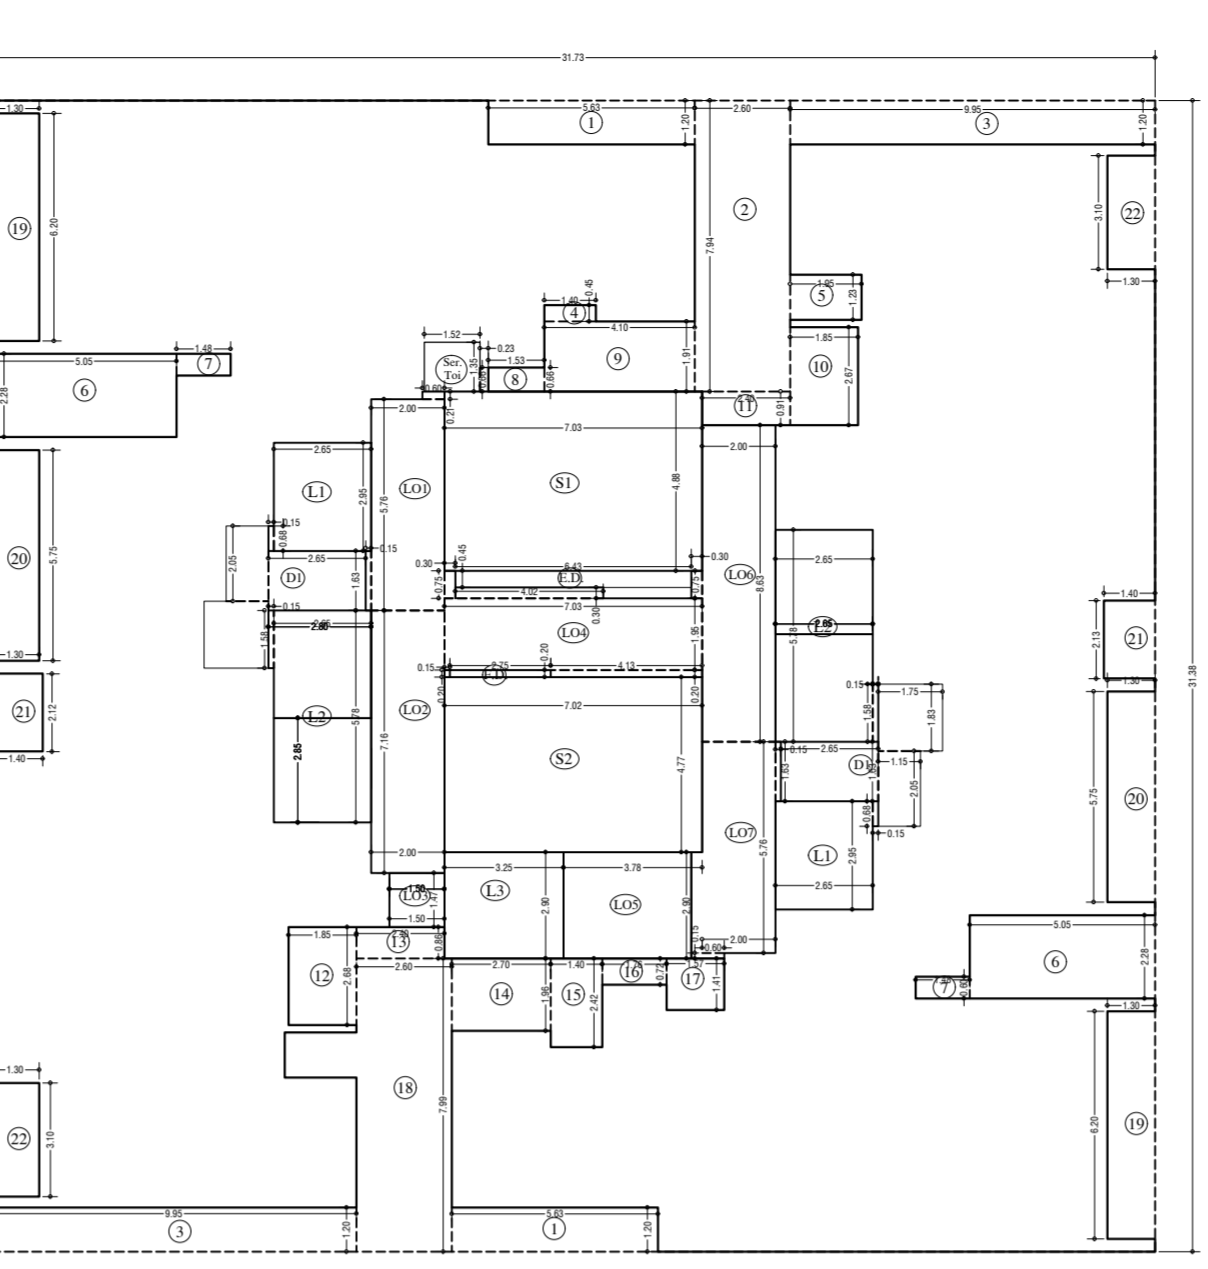


LINE AREA DIA. FOR 19th TO 23rd TYPICAL FLOOR (WING=T-2)
SCALE - 1:100


BUILT UP AREA FOR 19TH TO 23RD FLOOR (WING-T-2)

ADDITION (SQ)	NO.	DESCRIPTION	AREA (SQ)	TOTAL
AD	1.17	3.18 X 1.00 X 1	3.18	3.18
AD	1.18	3.18 X 1.00 X 1	3.18	6.36
AD	1.19	3.18 X 1.00 X 1	3.18	9.54
AD	3.17	3.18 X 1.00 X 1	3.18	639.18
AD	3.18	3.18 X 1		


CONTENTS OF SHEET
24TH REFUGE FLOOR PLAN, 25TH FLOOR PLAN, 26TH FLOOR PLAN, 27TH TO 29TH TYPICAL FLOOR PLAN, LINE AREA DIAGRAM & AREA CALCULATION. (WING=T-2)

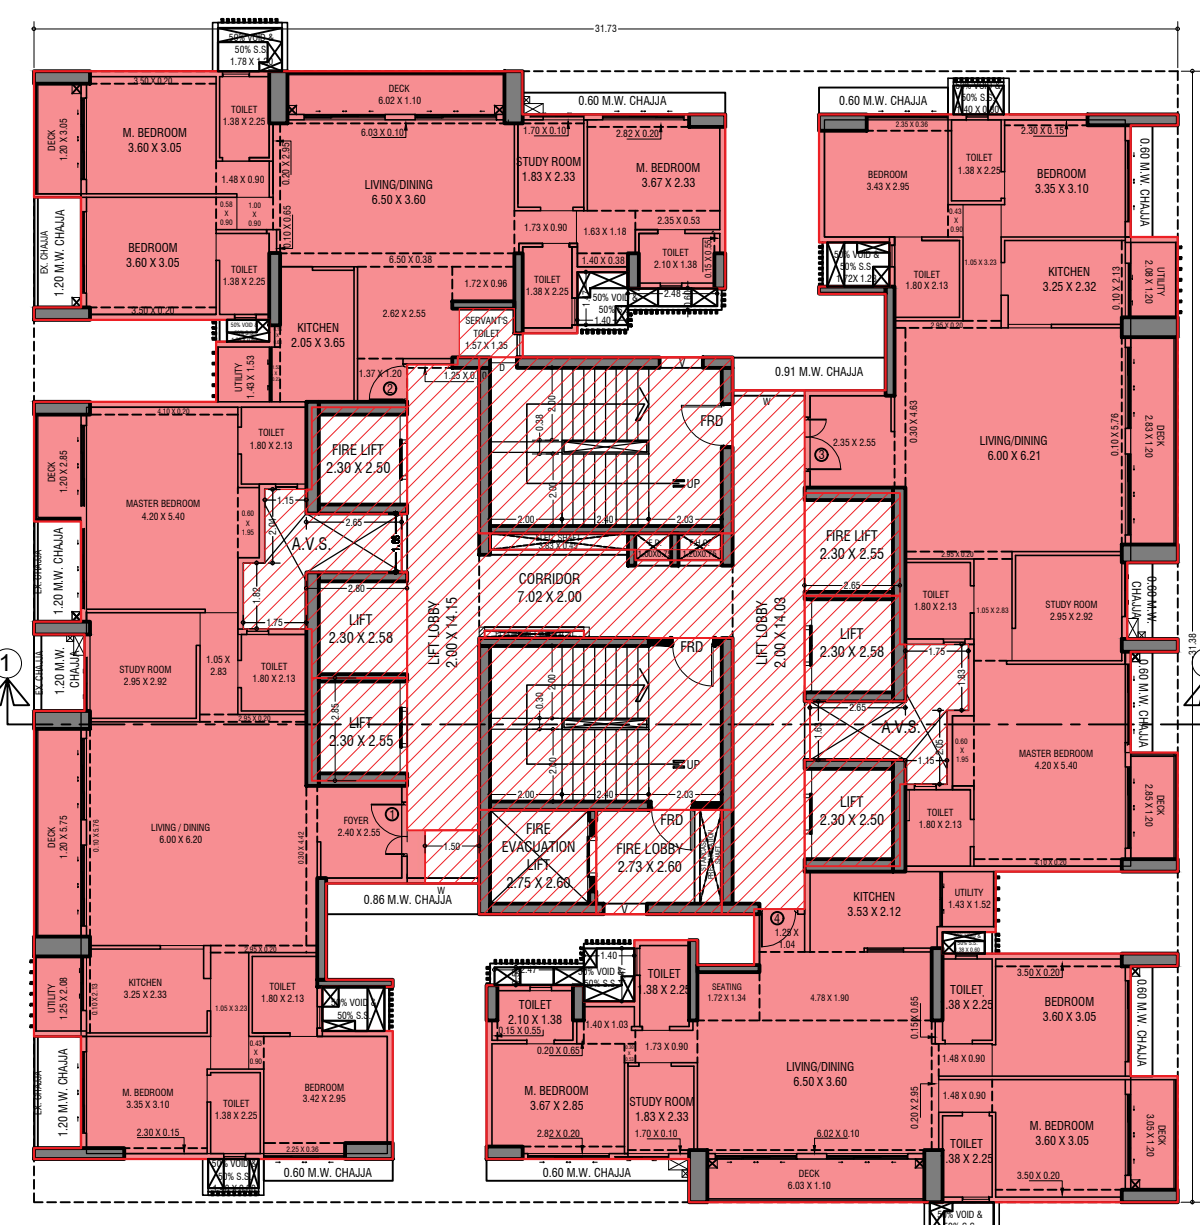


26th FLOOR PLAN (WING=T-2)
SCALE: 1:100

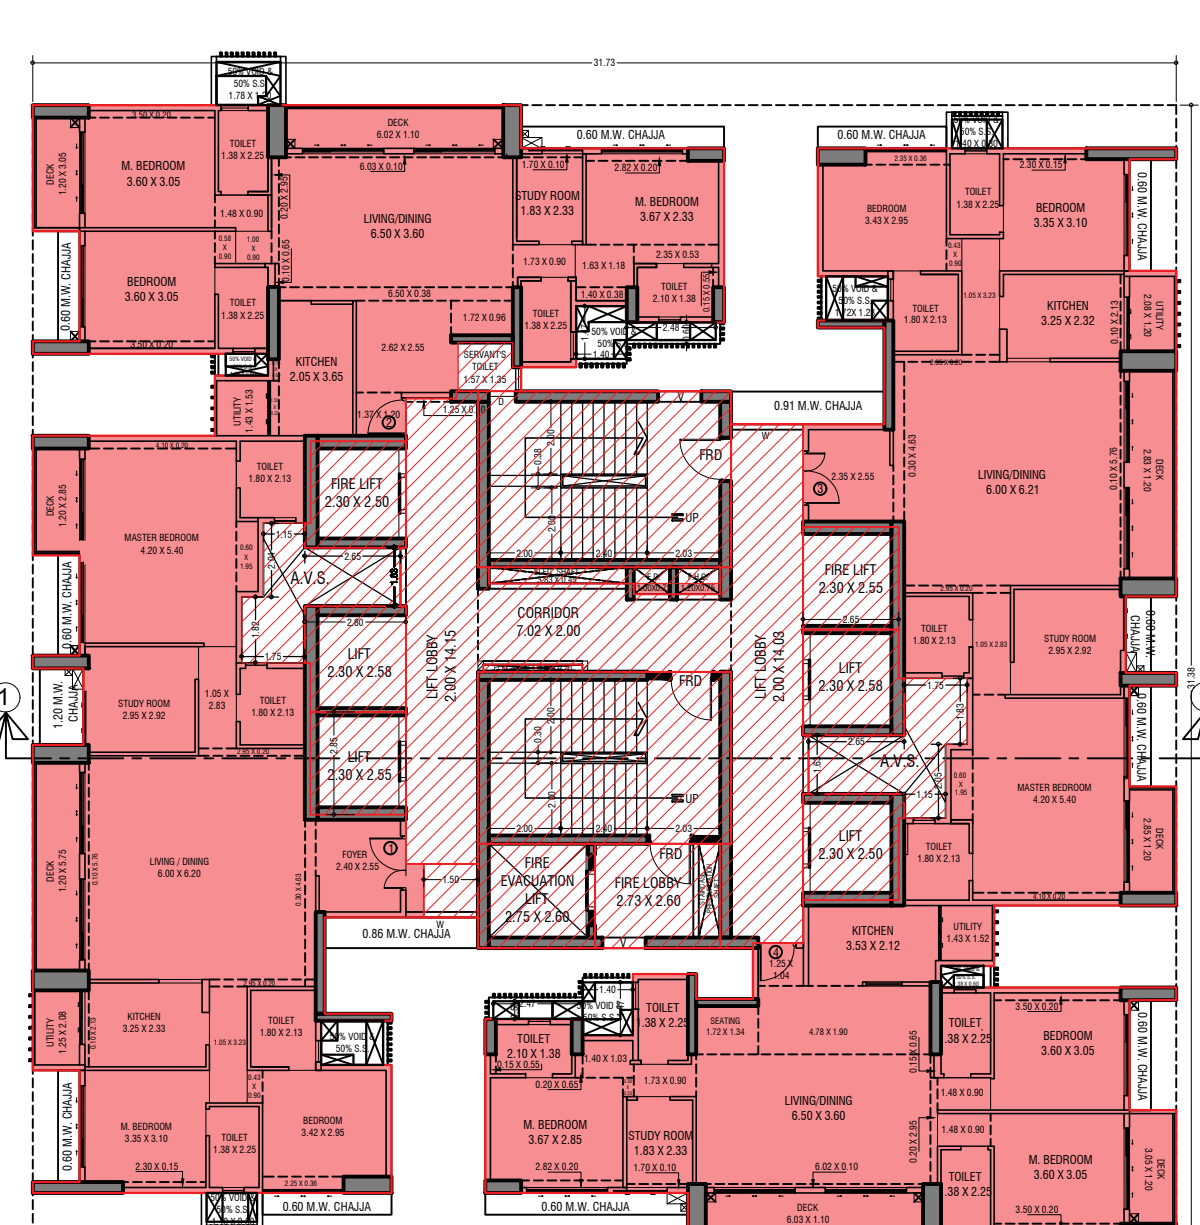

27th TO 29th FLOOR PLAN (WING=T-2)
SCALE: 1:100

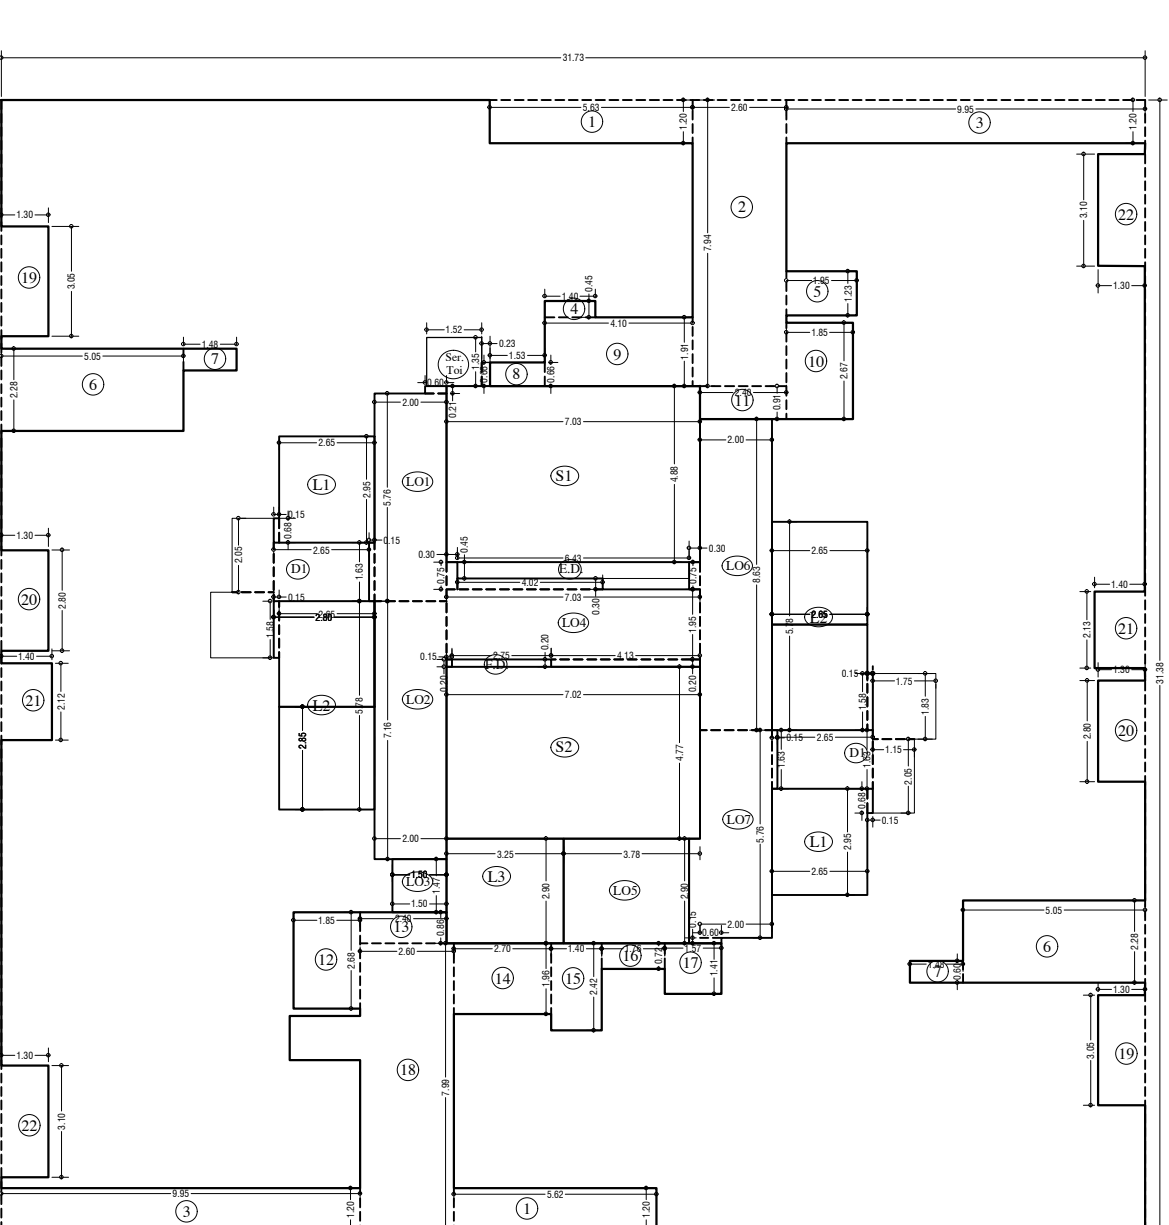


LINE AREA DIA. FOR 26th TO 29th TYPICAL FLOOR (WING=T-2)
SCALE: 1:100

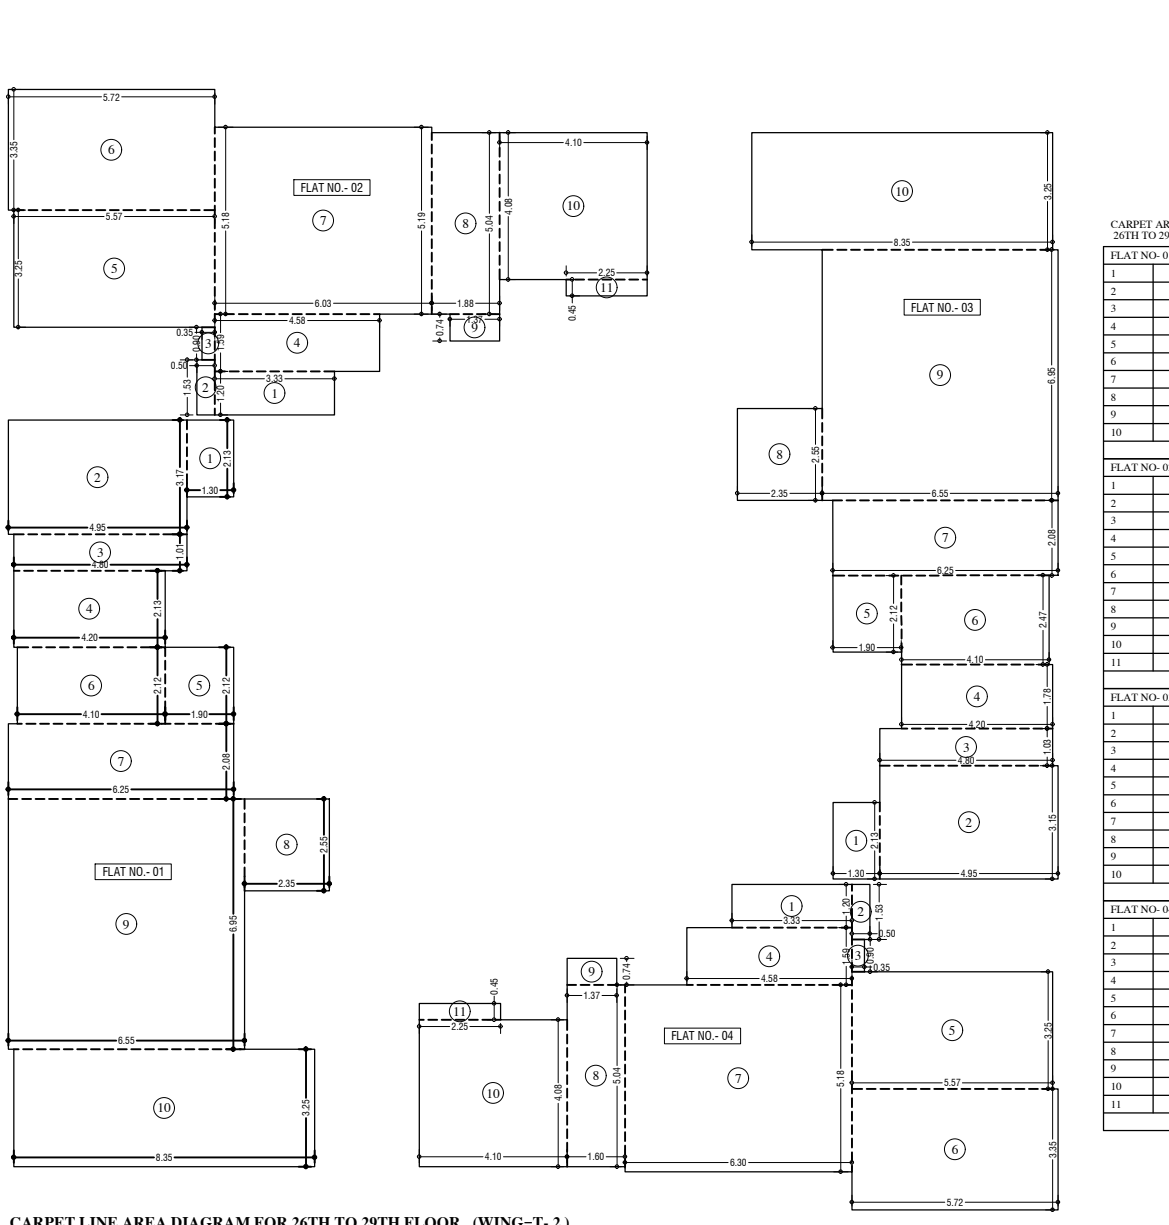


CARPET LINE AREA DIAGRAM FOR 26TH TO 29TH FLOOR. (WING=T-2)
SCALE: 1:100

Table with 3 columns: FLOOR NO, AREA, and TOTAL ADDITION. Lists area calculations for floors 26, 27, 28, and 29.

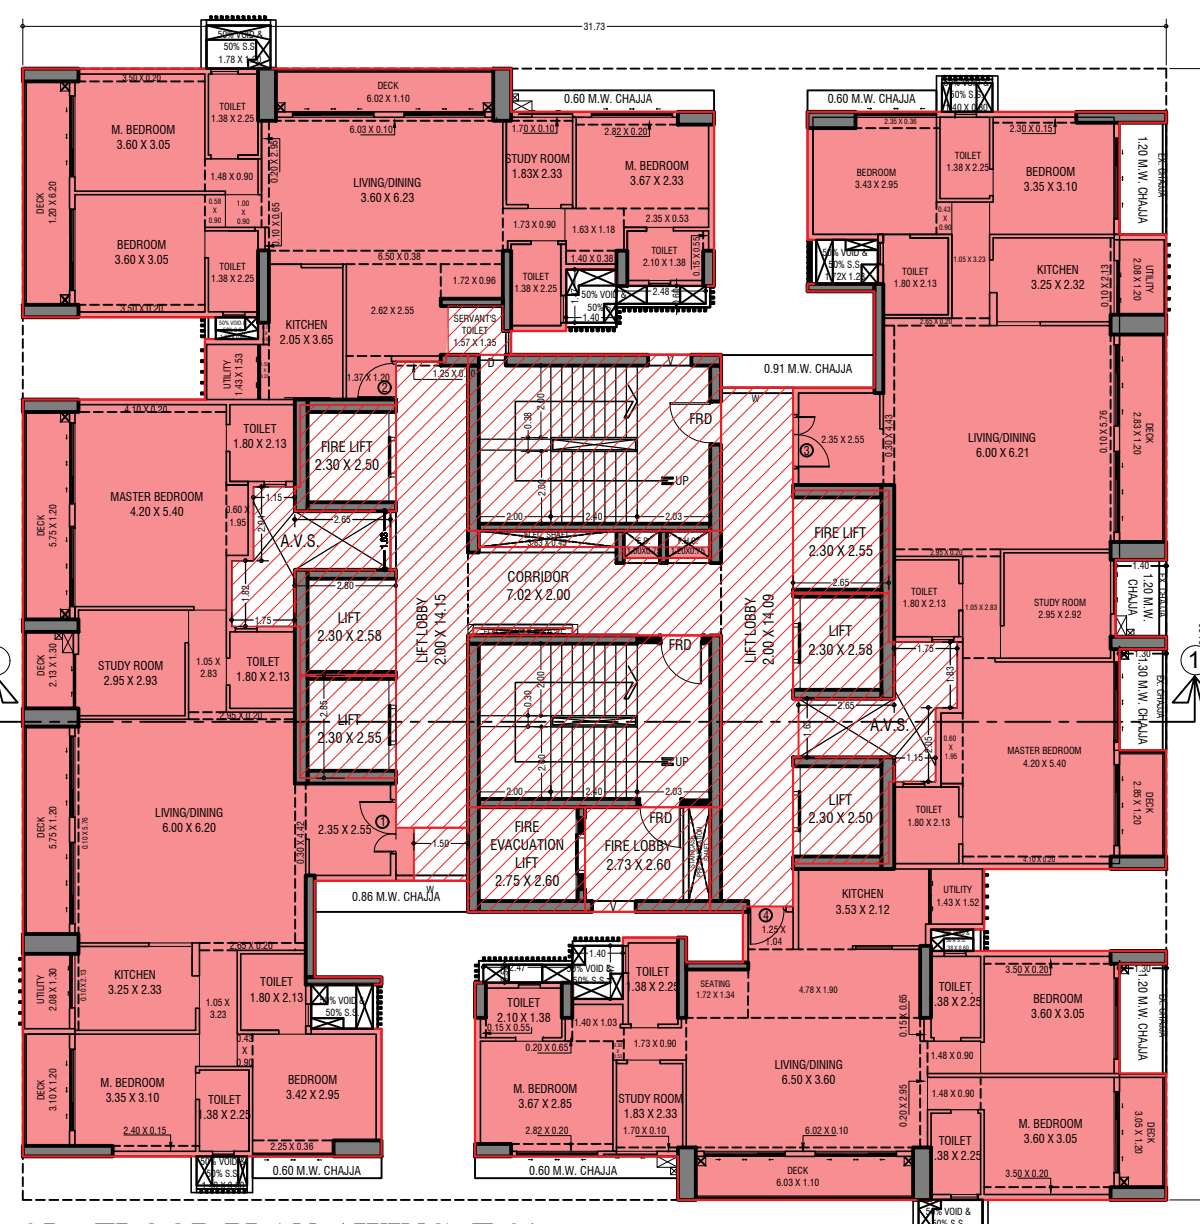


25th FLOOR PLAN (WING=T-2)
SCALE: 1:100

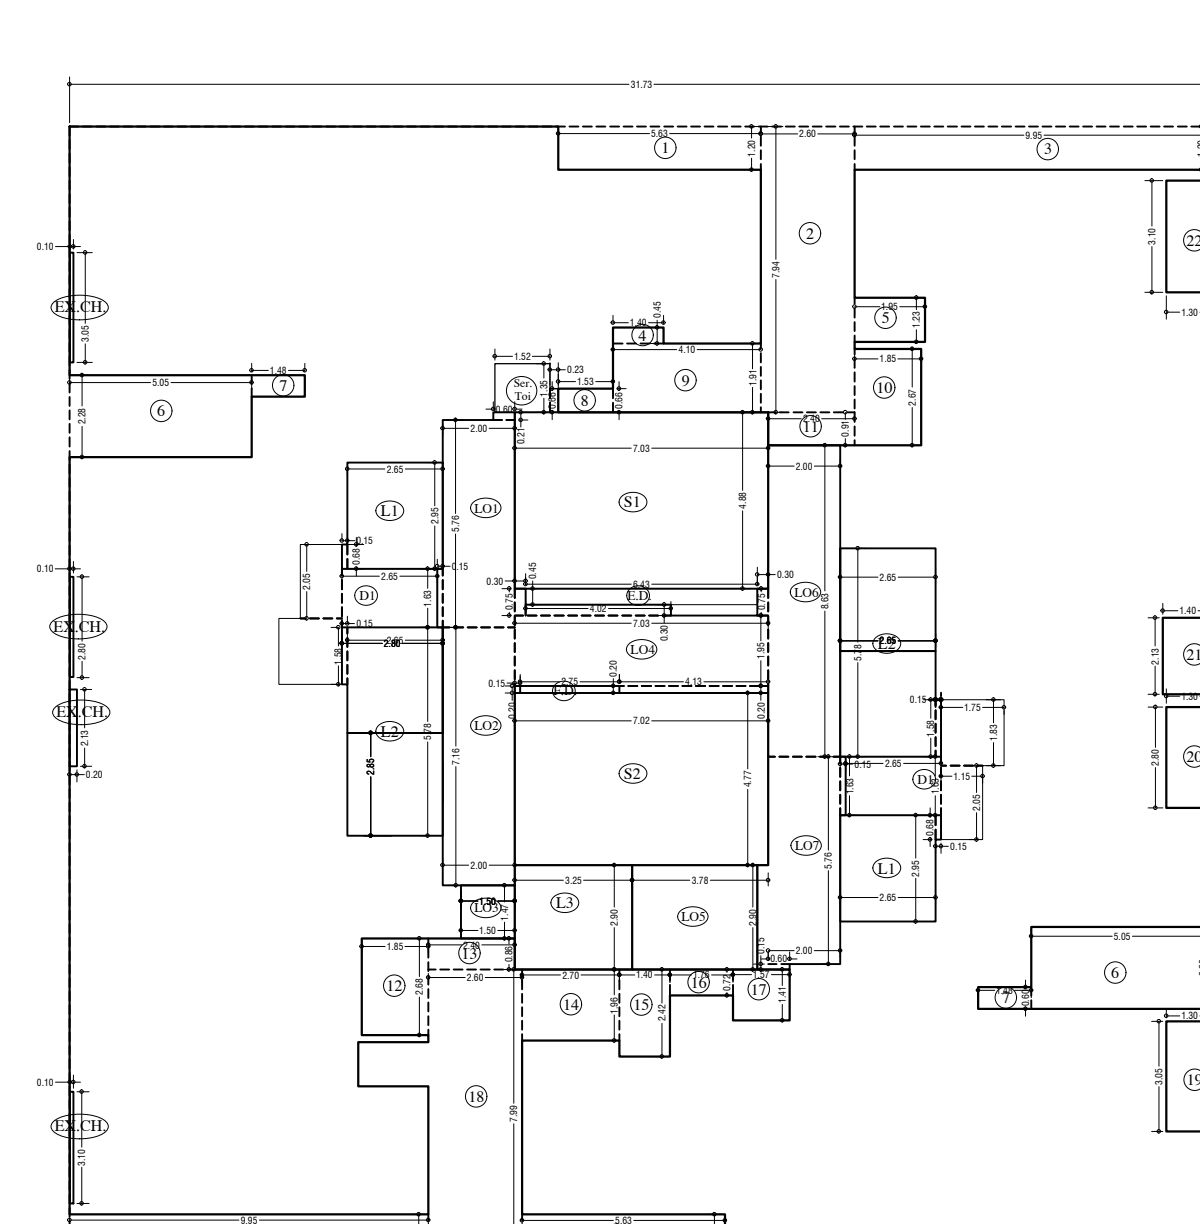

LINE AREA DIA. FOR 25th FLOOR (WING=T-2)
SCALE: 1:100


Table with 3 columns: ADDRESS (X), AREA, and TOTAL ADDITION. Lists area calculations for the 25th floor.

Table with 3 columns: ADDRESS (X), AREA, and TOTAL ADDITION. Lists area calculations for the 25th floor.

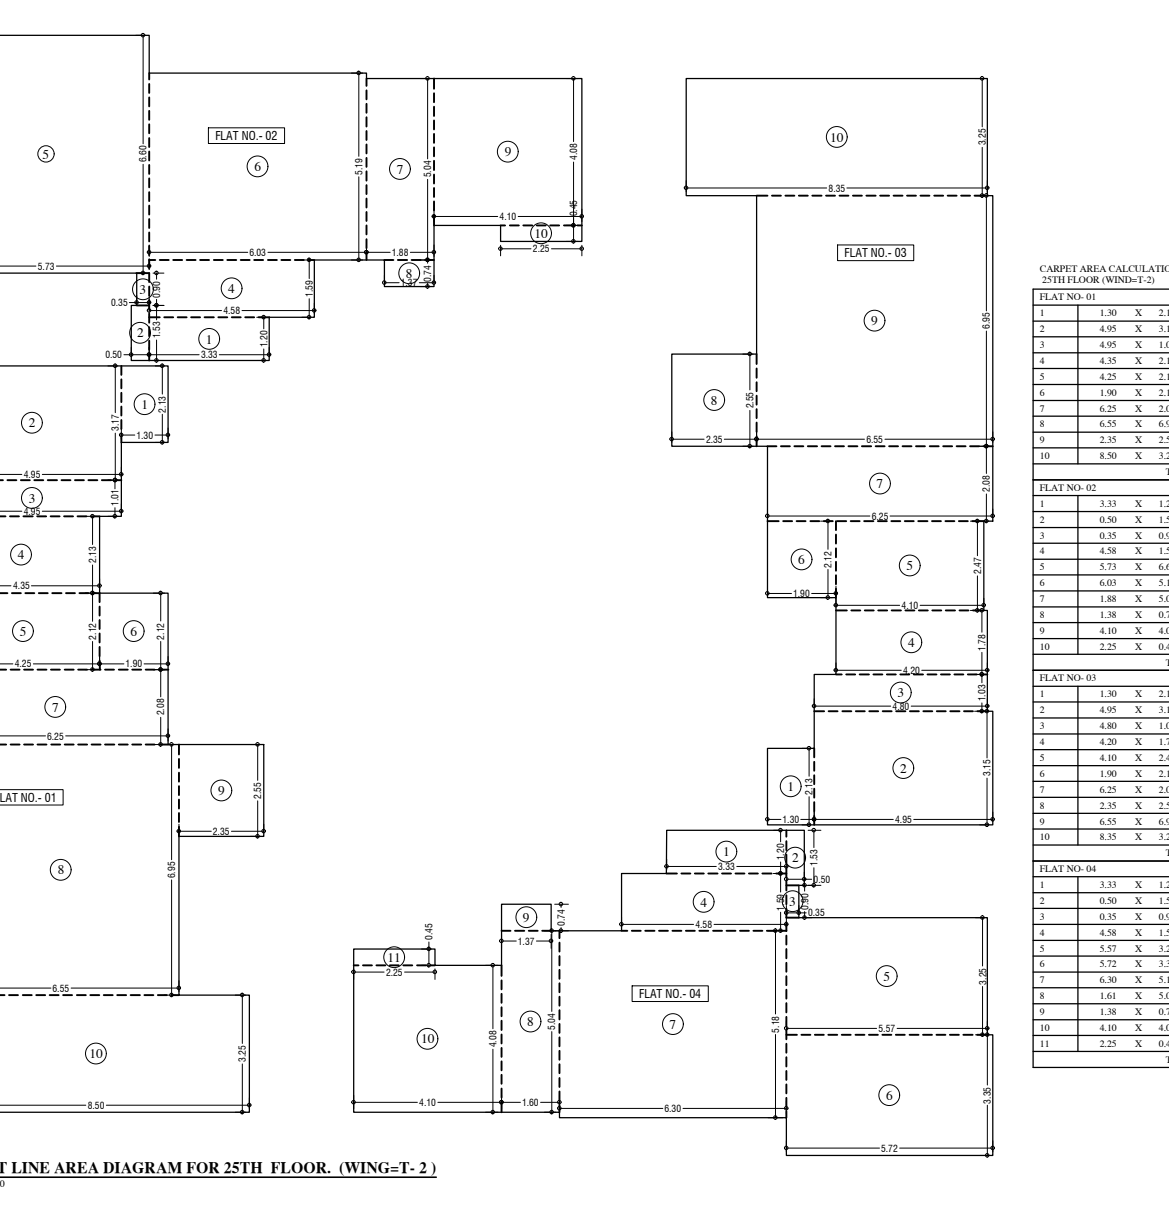


CARPET LINE AREA DIAGRAM FOR 25TH FLOOR. (WING=T-2)
SCALE: 1:100

Table with 3 columns: FLOOR NO, AREA, and TOTAL ADDITION. Lists area calculations for the 25th floor.

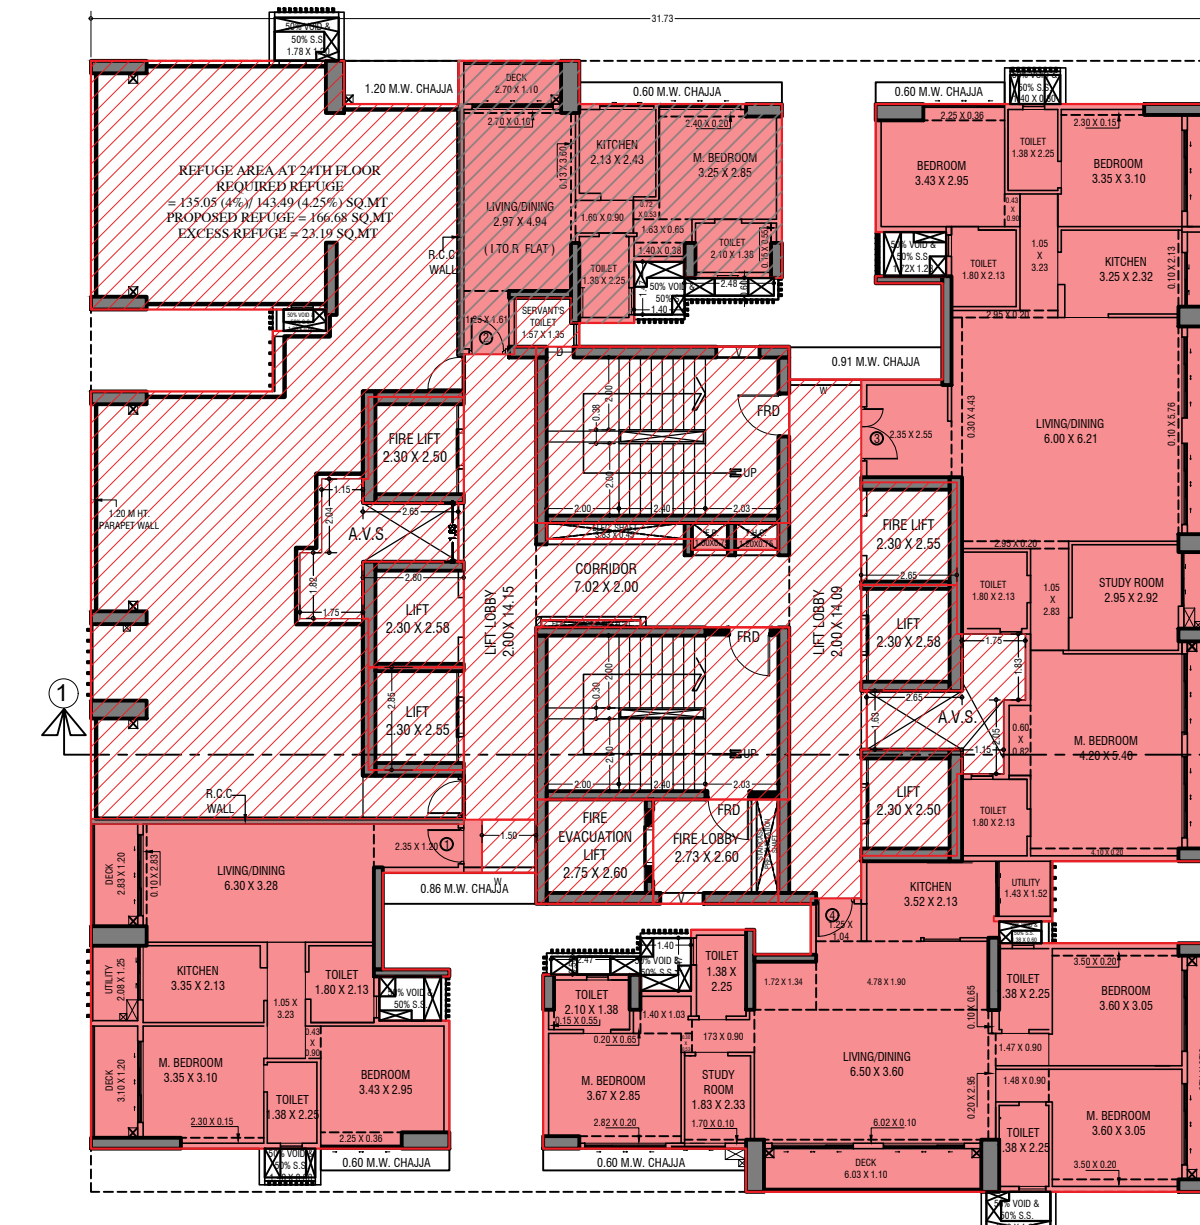


24th REFUGE FLOOR PLAN (WING=T-2)
SCALE: 1:100

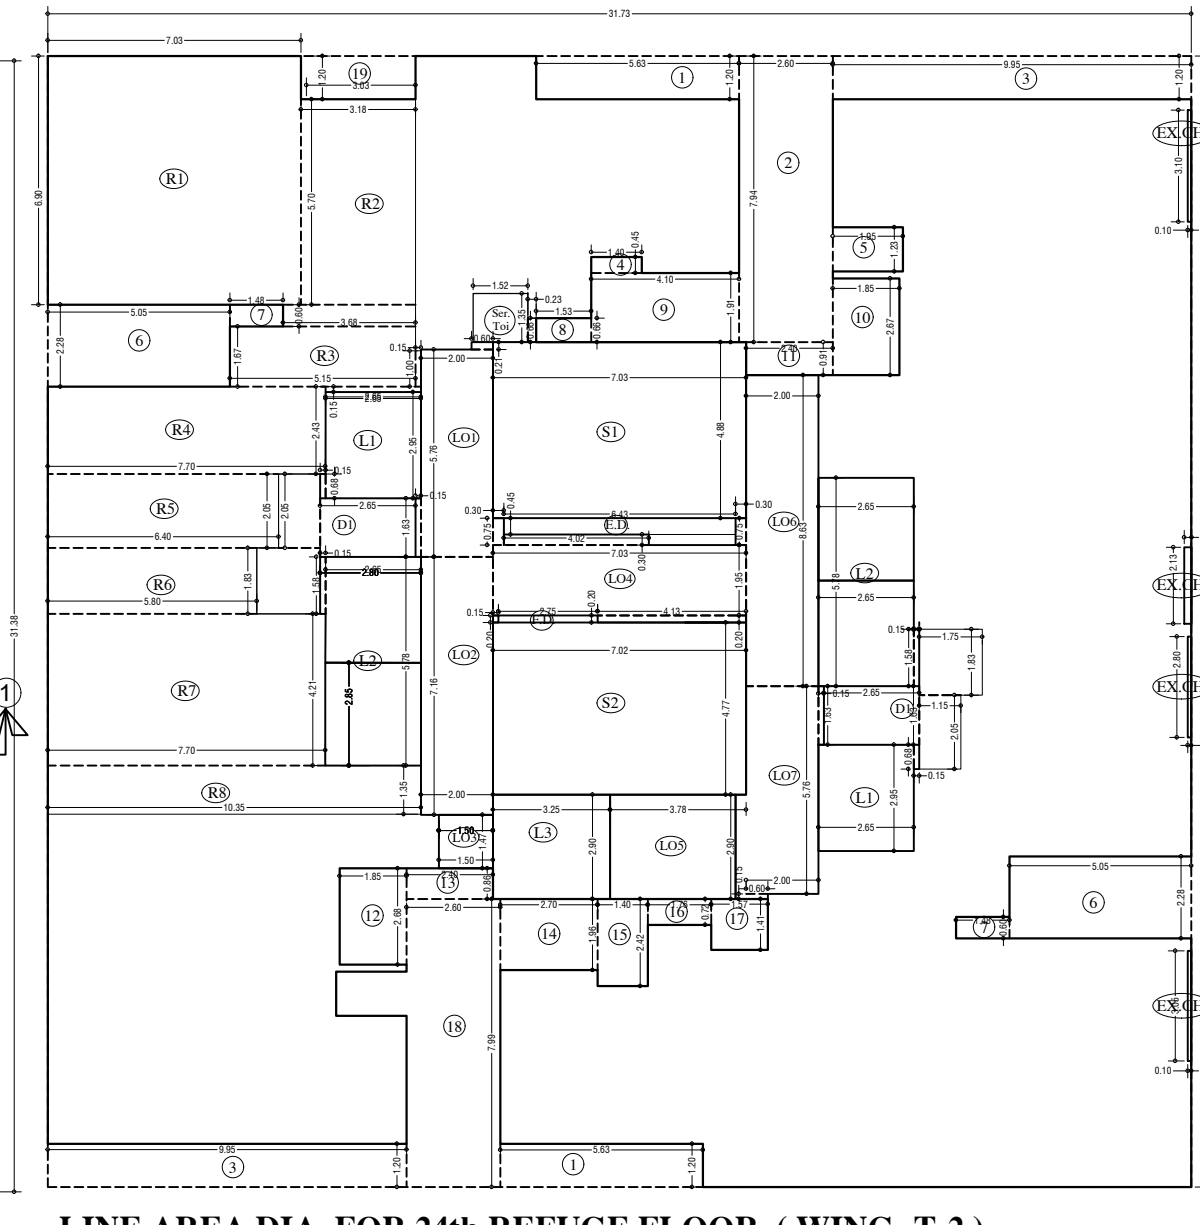

LINE AREA DIA. FOR 24th REFUGE FLOOR (WING=T-2)
SCALE: 1:100

Table with 3 columns: ADDRESS (X), AREA, and TOTAL ADDITION. Lists area calculations for the 24th refuge floor.

Table with 3 columns: ADDRESS (X), AREA, and TOTAL ADDITION. Lists area calculations for the 24th refuge floor.

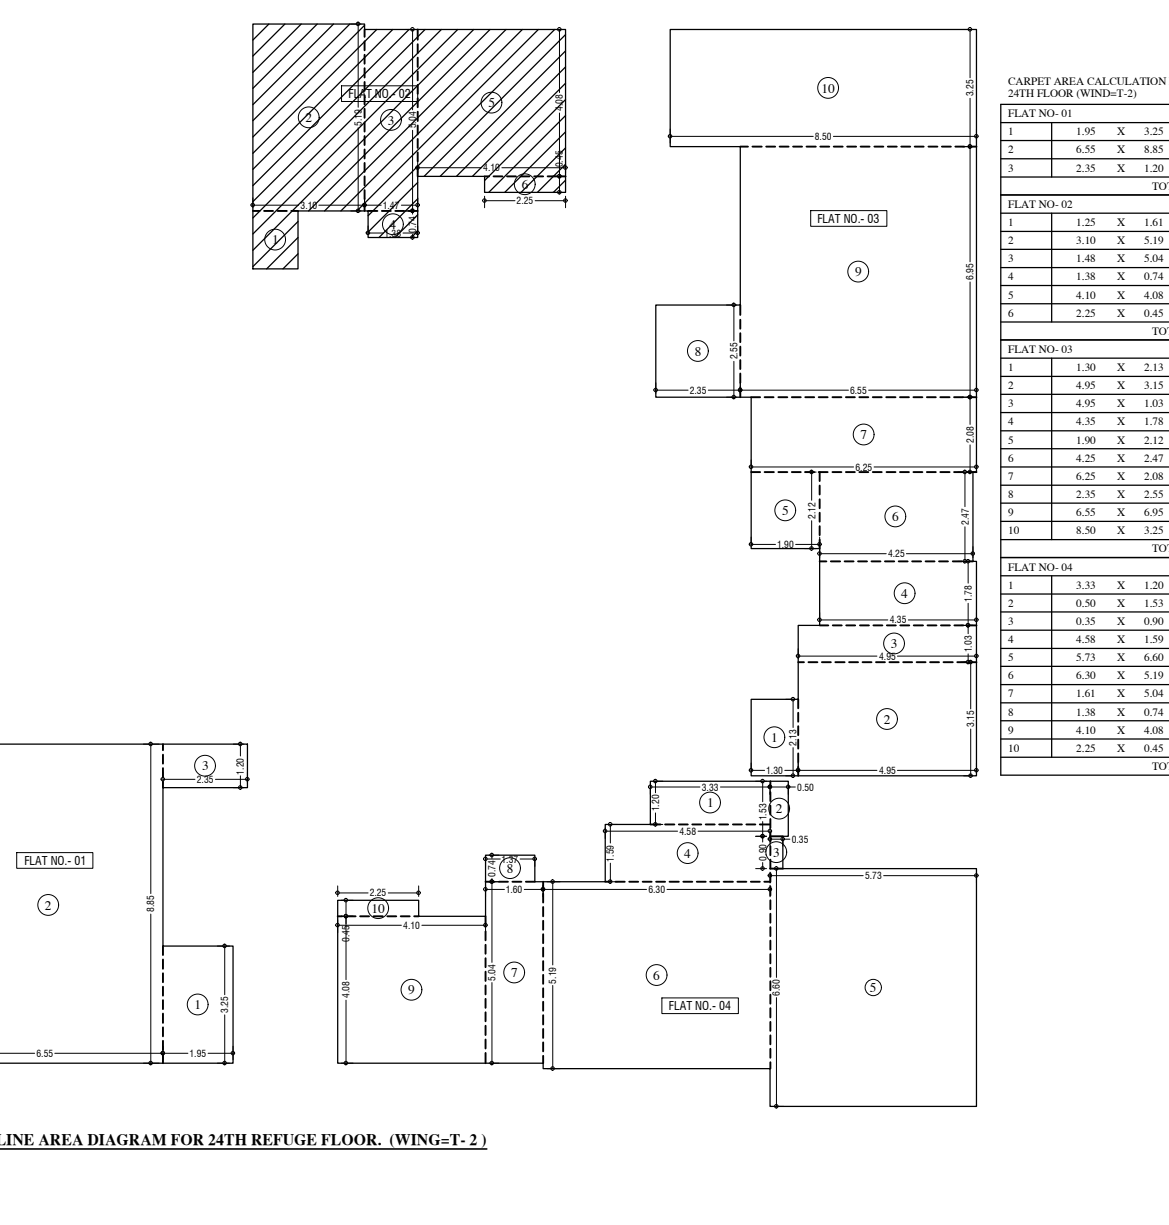

CARPET LINE AREA DIAGRAM FOR 24TH REFUGE FLOOR. (WING=T-2)
SCALE: 1:100

Table with 3 columns: FLOOR NO, AREA, and TOTAL ADDITION. Lists area calculations for the 24th refuge floor.

STAMP AND DATE OF APPROVAL OF PLAN
APPROVED SUBJECT TO THE CONDITIONS MENTIONED IN THIS OFFICE LETTER NO P-1215/2022 (611 And Other) S/Ward Kanjur-W

S.E./P./S/W A.E./P./S & T EX. ENG./P./ES-II
STAMP AND DATE OF RECEIPT OF PLAN

DESCRIPTION OF PROPOSAL & PROPERTY
PROPOSED DEVELOPMENT ON PLOT BEARING CTS NO 611, 611/1 TO 611/10 OF VILLAGE KANJUR, SITUATED IN S-WARD, MUMBAI.

Table with 4 columns: NORTH, JOB NO., DRG. NO., DRAWN BY. Values: 488, 16/25, PRACHI.


Table with 4 columns: SCALE, DATE, CHECKED BY. Values: 1:100, -, NIKHIL.

REVISIONS DESCRIPTION

NAME AND ADDRESS OF DESIGN ARCHITECT

NAME OF THE OWNER SIGNATURE
MS. JAHNVI OIL MILL CO.


NAME AND ADDRESS OF LICENSED SURVEYOR (L.S.) SIGNATURE

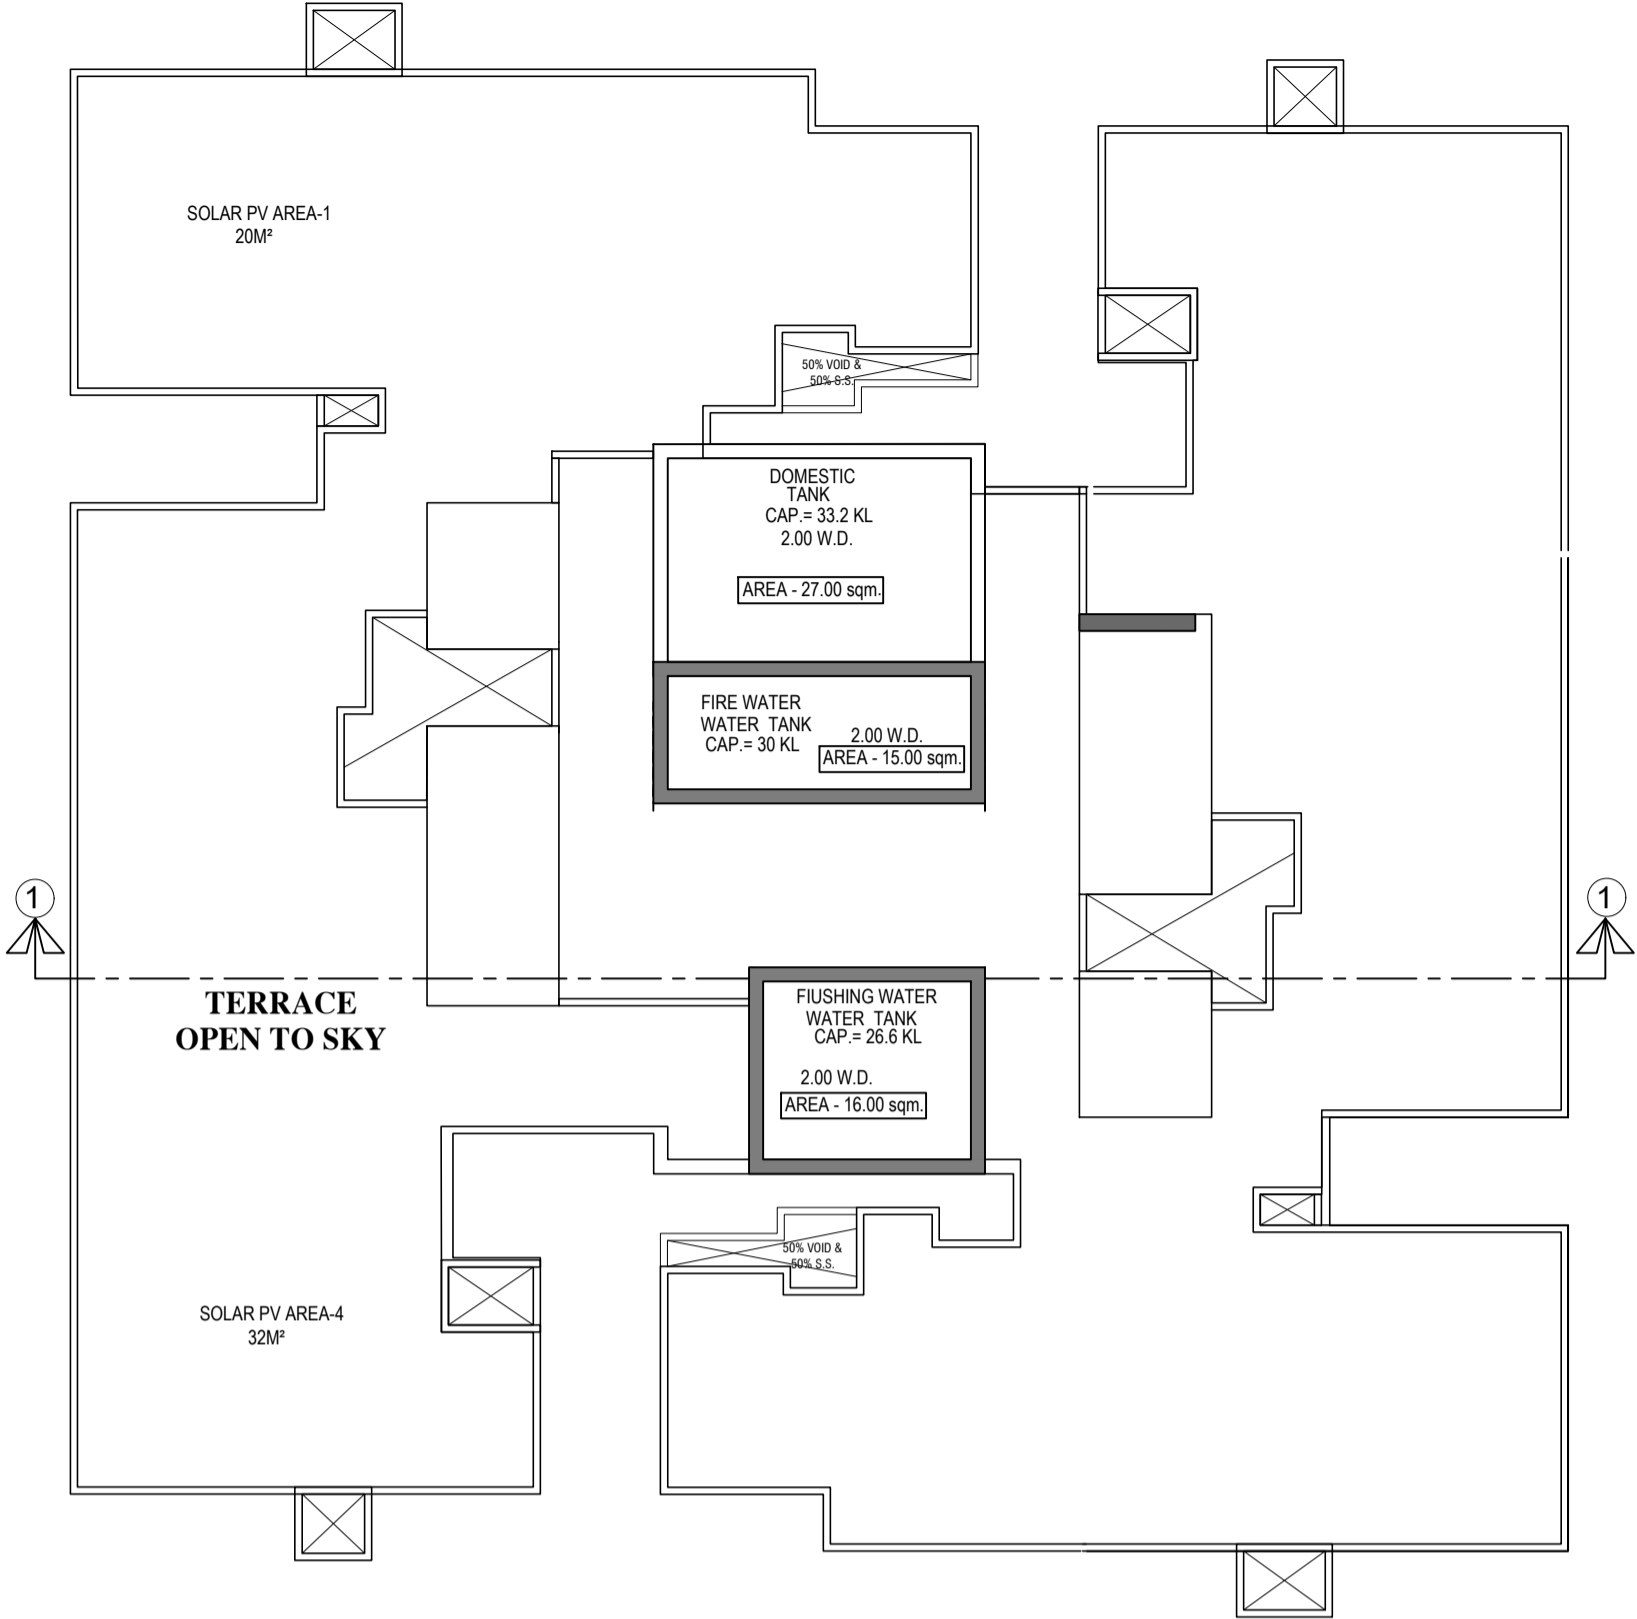

CONTENTS OF SHEET
26th FLOOR PLAN, 27th TO 29th TYPICAL FLOOR PLAN, LINE AREA DIAGRAM, AREA CALCULATION, TERRACE FLOOR PLAN & OHT PLAN. (WING=T-2)

STAMP AND DATE OF APPROVAL OF PLAN
APPROVED SUBJECT TO THE CONDITIONS MENTIONED IN THIS OFFICE LETTER NO P-12131/2022/(611 And Other)/S Ward/Kanjur-W

S.E.(B.P.) S/W	A.E.(B.P.) S & T	EX. ENG.(B.P.)ES-II

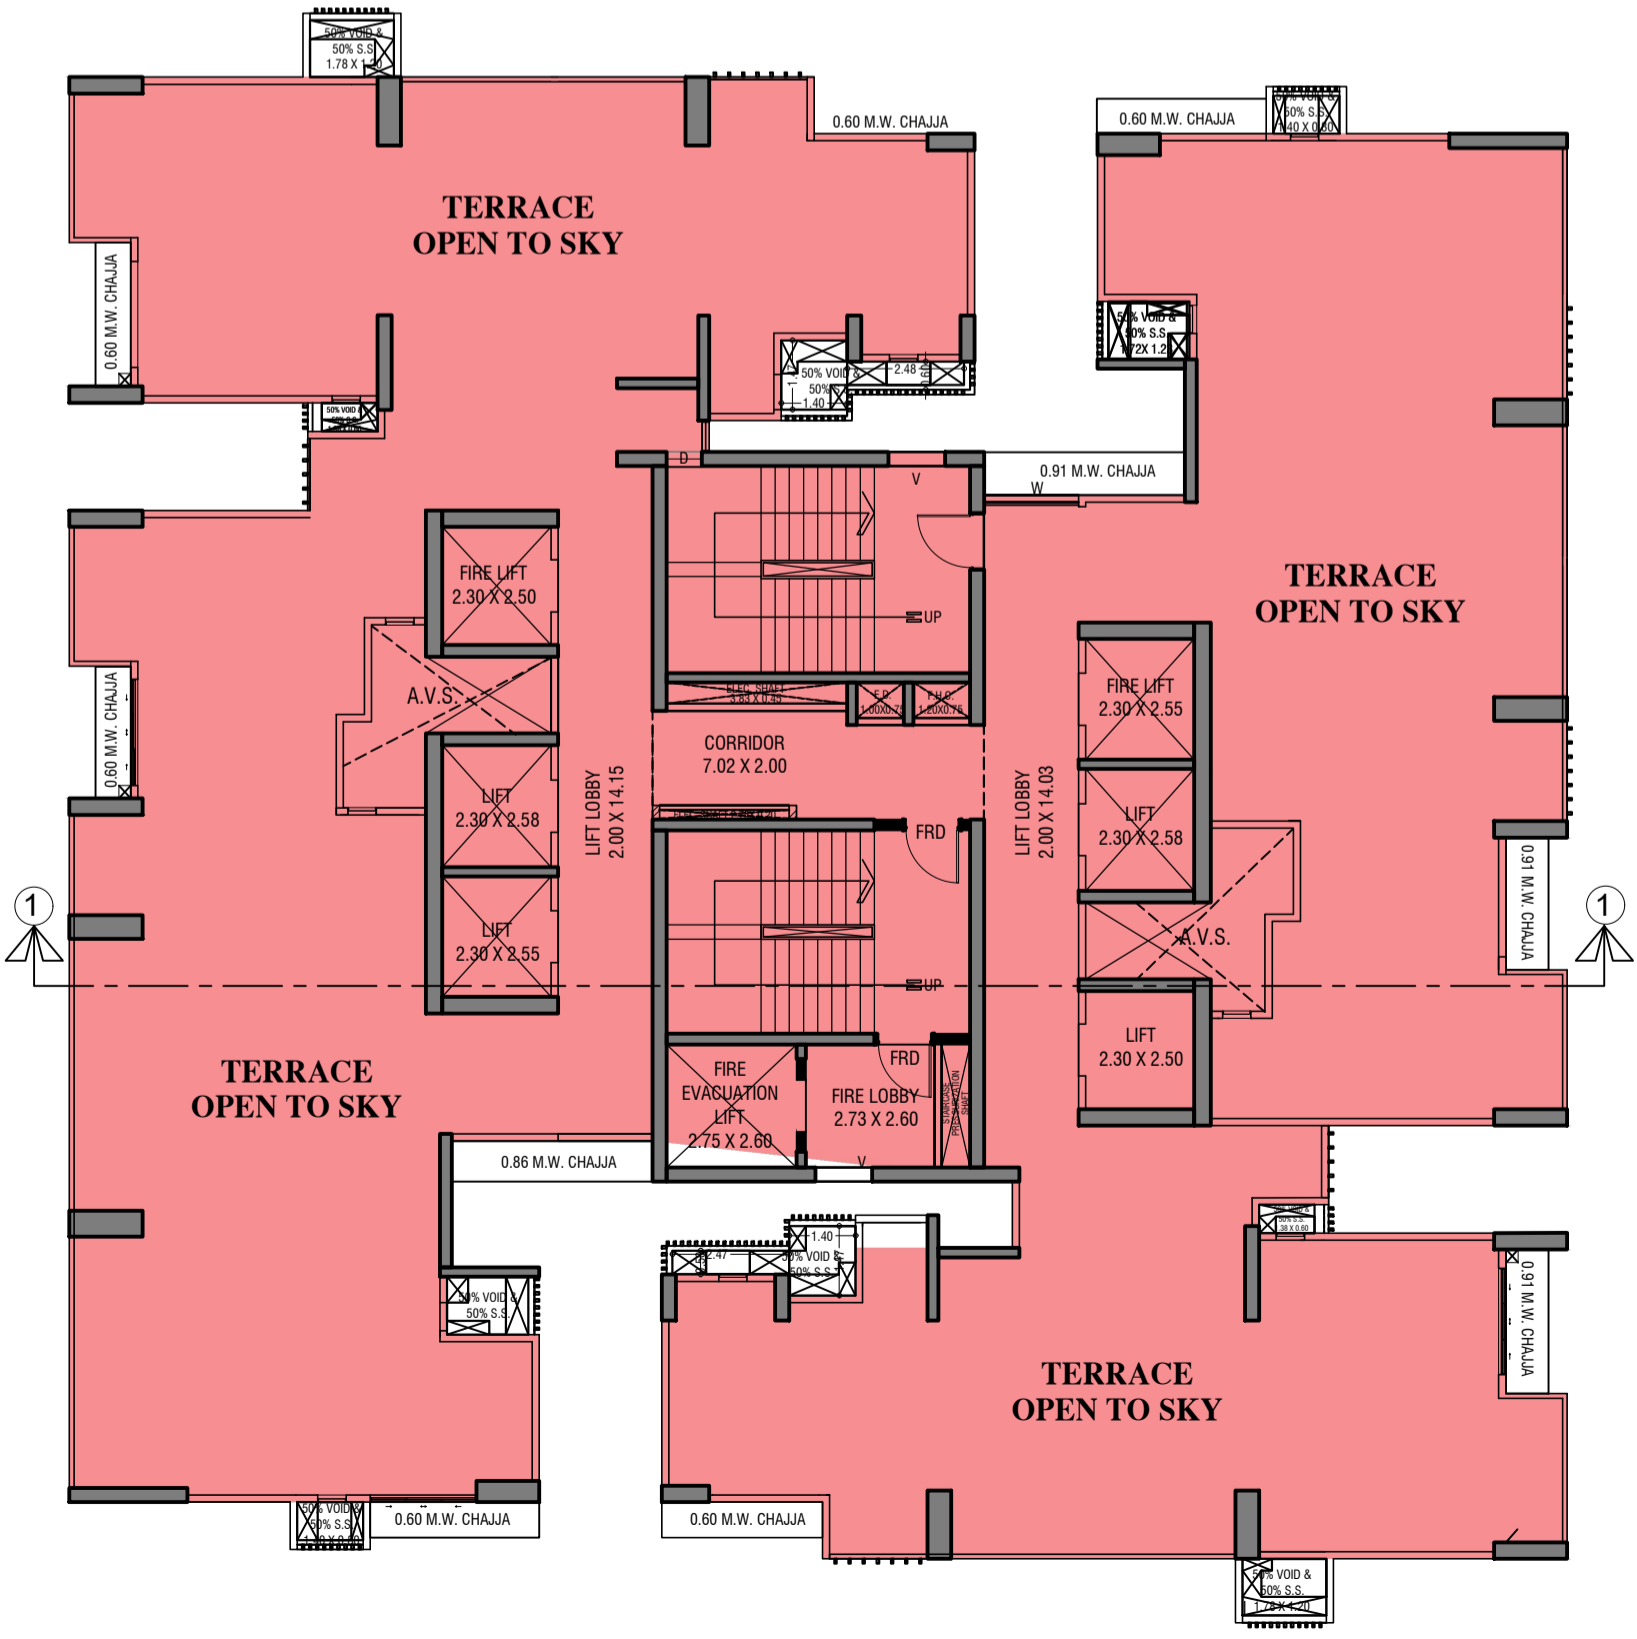

DESCRIPTION OF PROPOSAL & PROPERTY
PROPOSED DEVELOPMENT ON PLOT BEARING CTS NO.611, 611/1 TO 611/10 OF VILLAGE KANJUR, SITUATED IN S-WARD, MUMBAI.

	JOB. NO.	DRG. NO.	DRAWN BY
	498	17/25	PRACHI
	SCALE	DATE	CHECKED BY
	1:100	-	NIKHIL

REVISIONS DESCRIPTION :



R-0	
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NAME AND ADDRESS OF DESIGN ARCHITECT

NAME OF THE OWNER	SIGNATURE
M/S. JAIHIND OIL MILL CO.	

NAME AND ADDRESS OF LICENSED SURVEYOR (L.S) **SIGNATURE**


B-106, Natraj Building,
 Mulund Goregaon Link Road
 Mulund (w), Mumbai : 4000 080

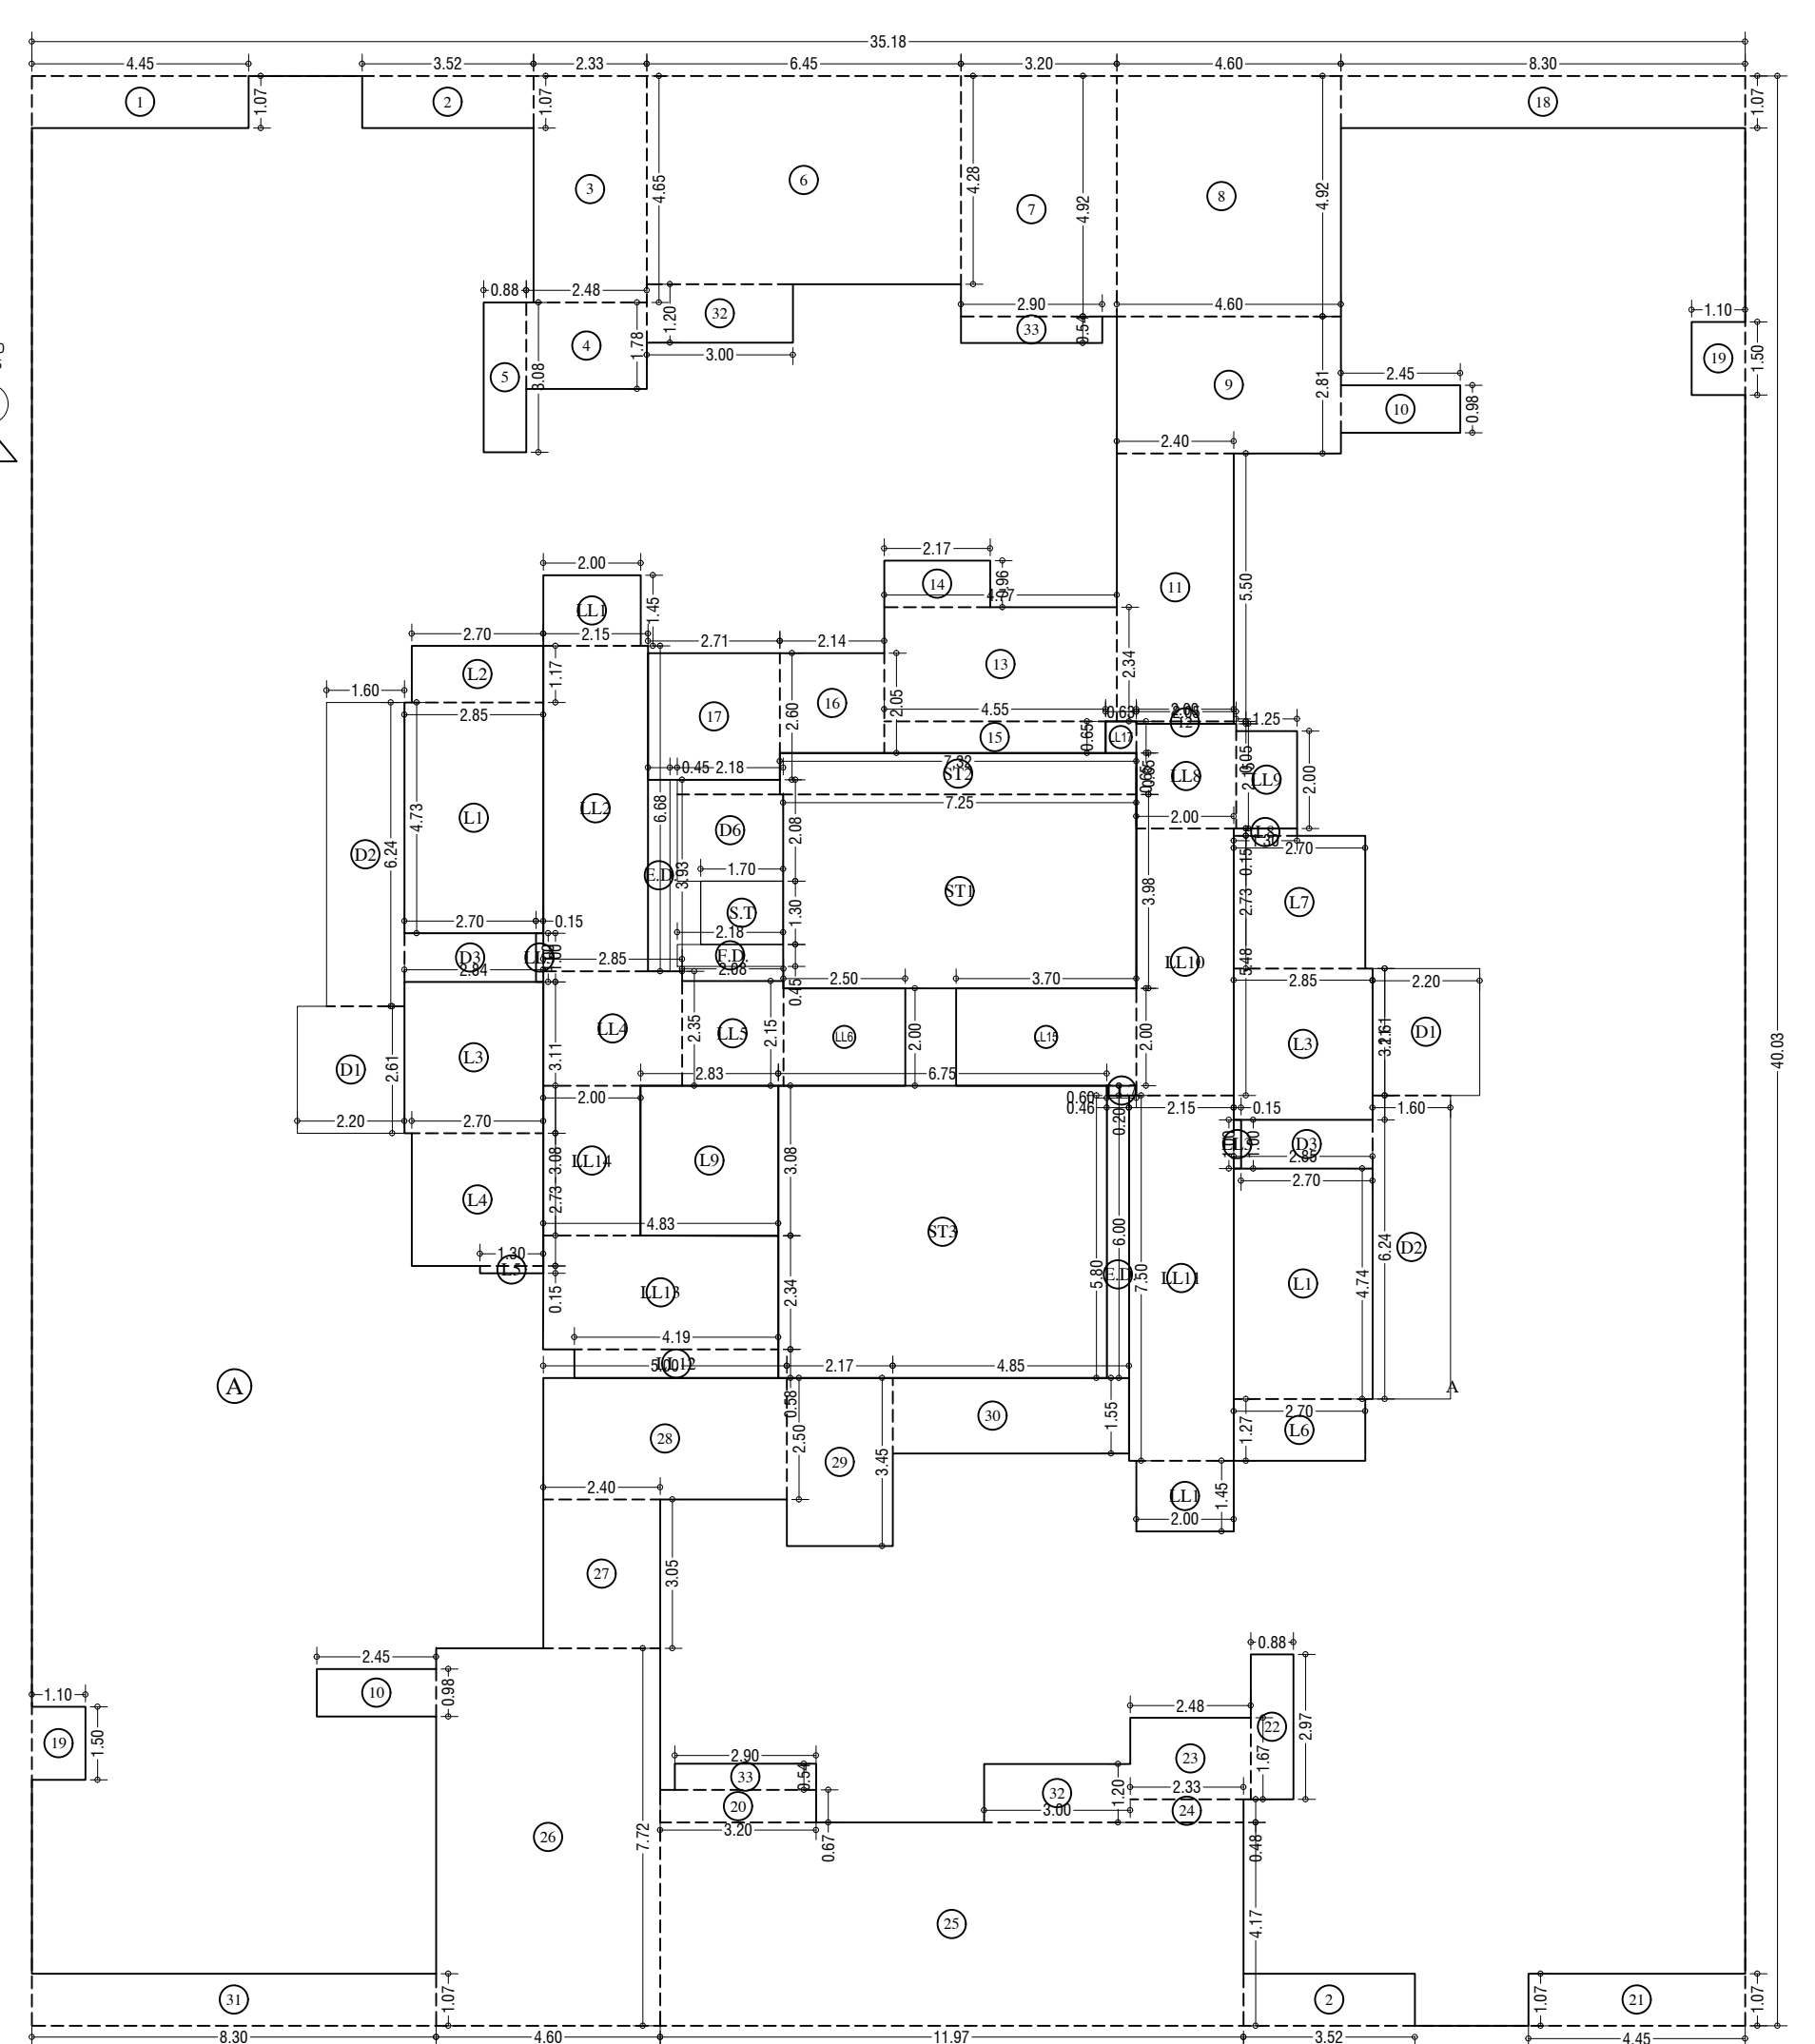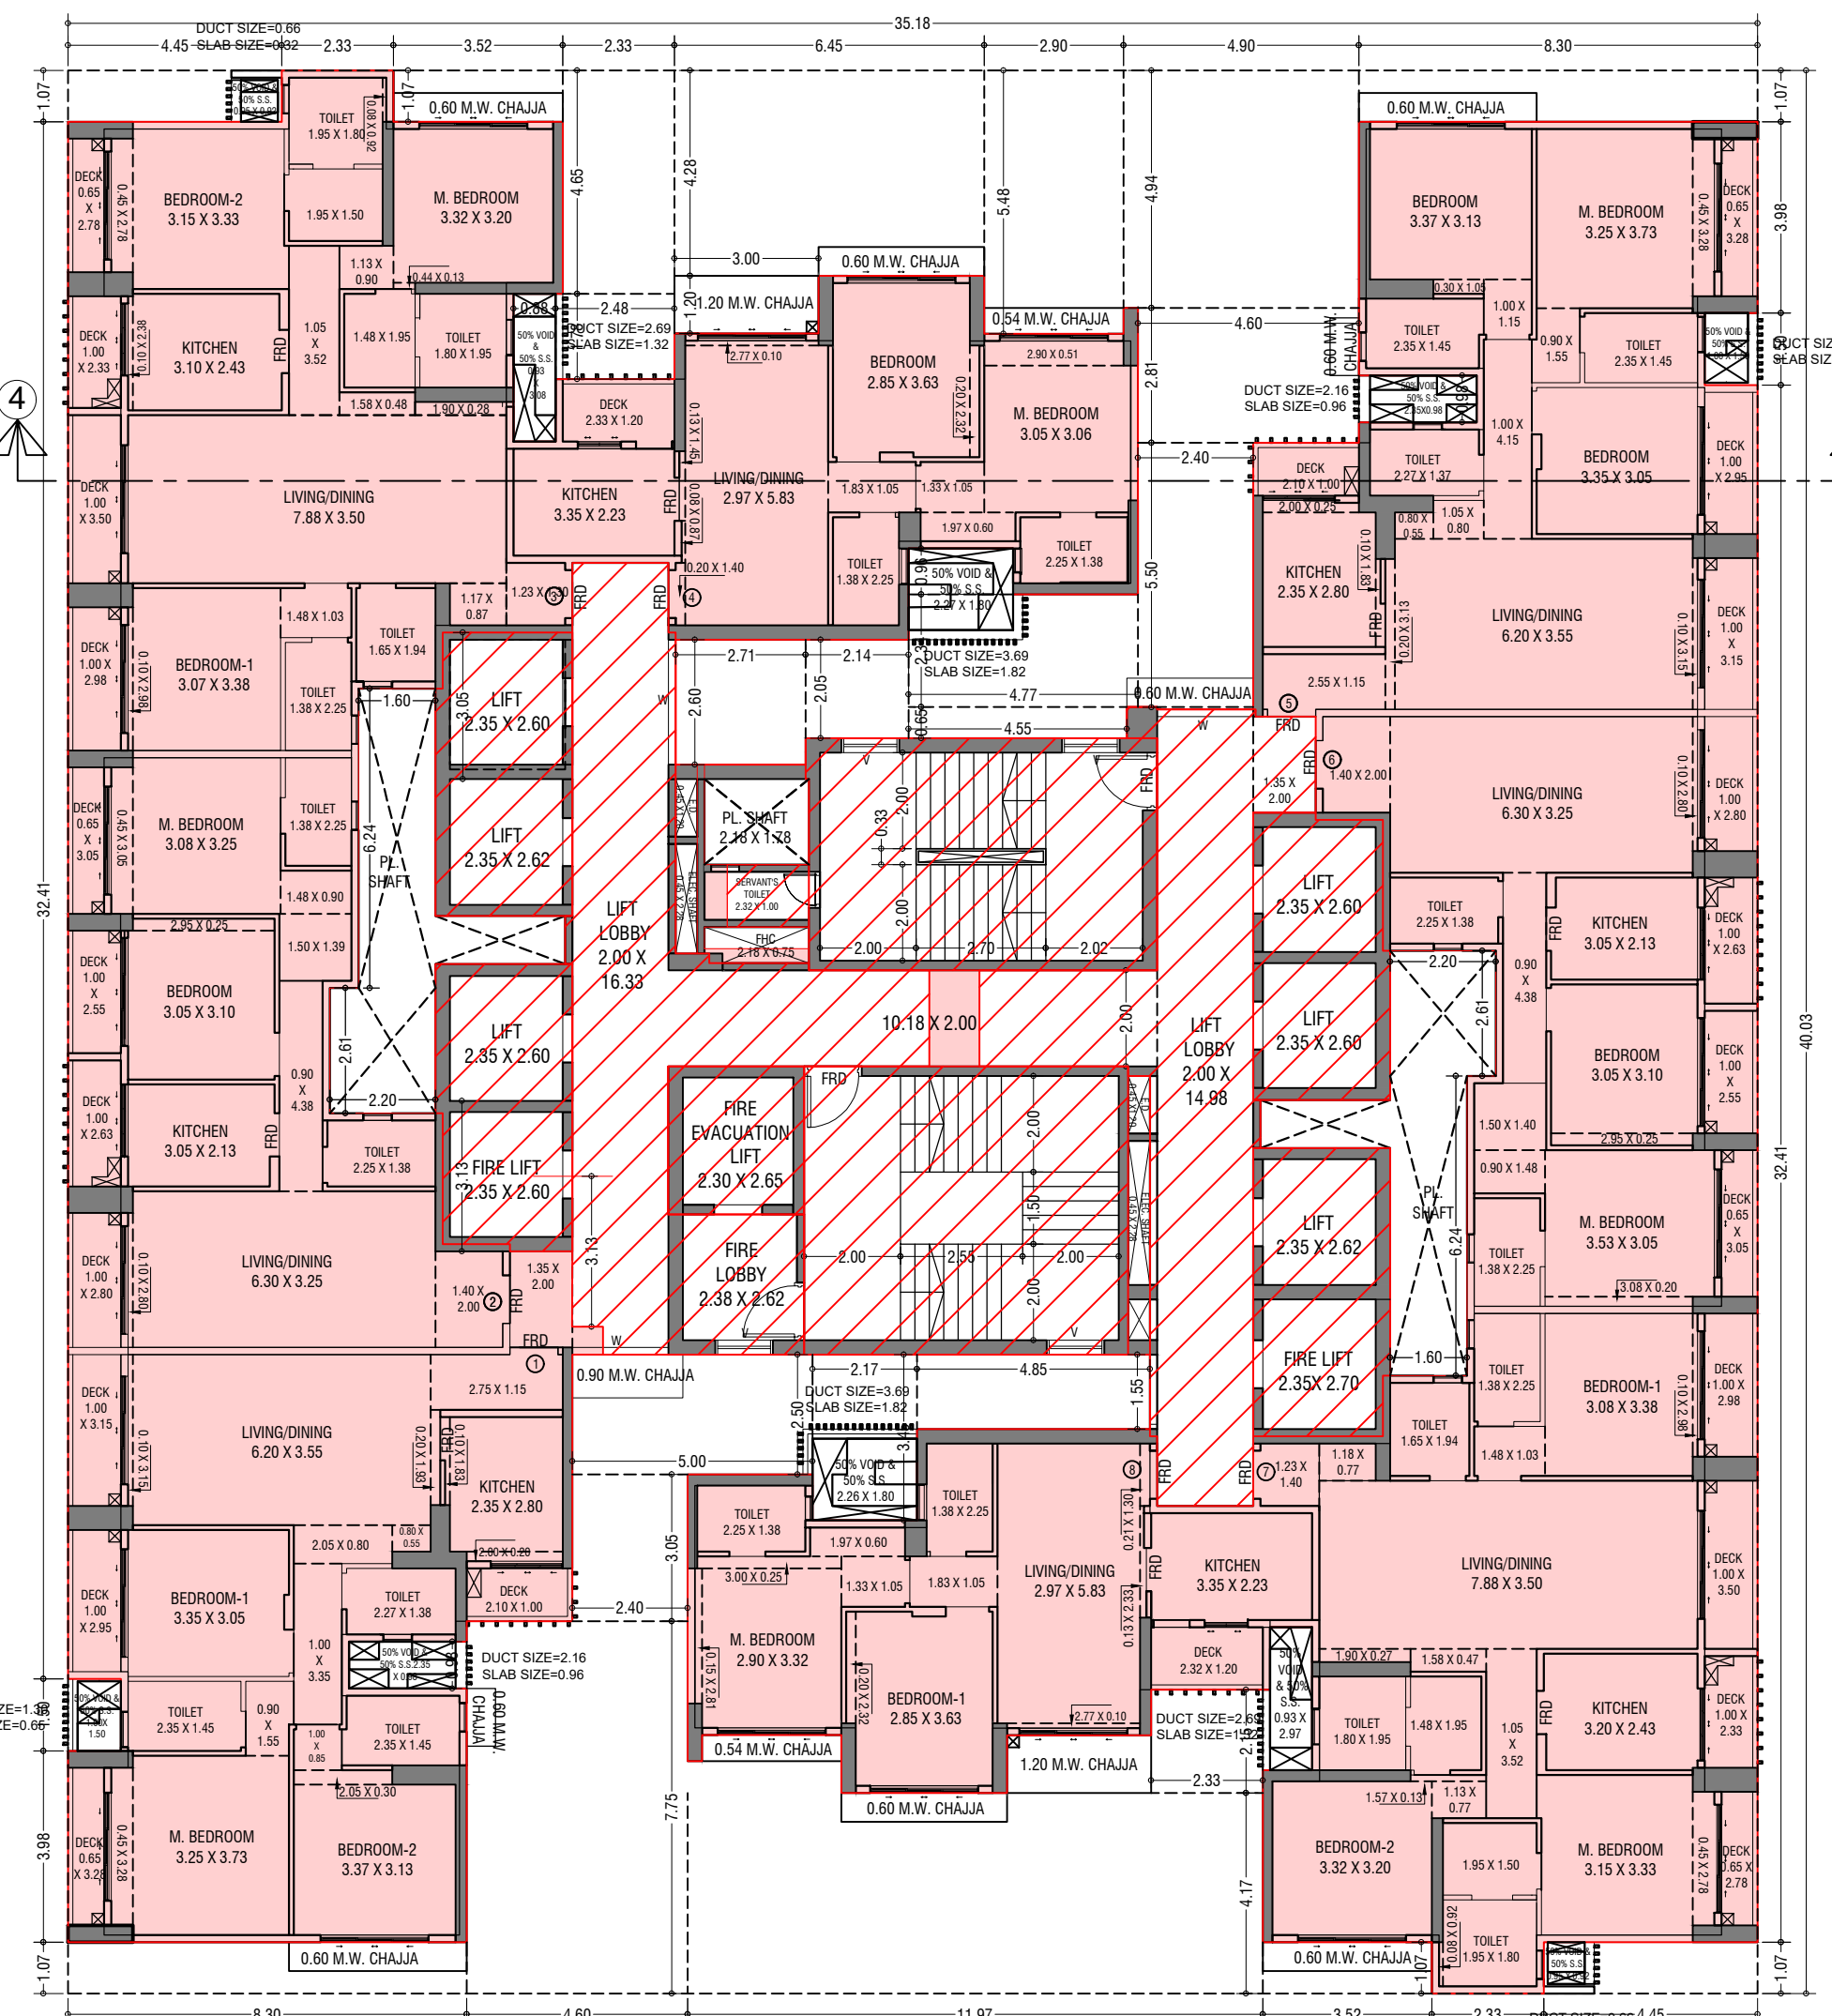


BUILT UP AREA CALCULATOR FOR 4th FLOOR (WING-T-4)	
REMARKS	AREA
1	4.45 X 1.07 X 1.90 = 8.76 SQ.MT
2	3.52 X 1.07 X 2.90 = 10.75 SQ.MT
3	2.23 X 4.65 X 1.90 = 19.83 SQ.MT
4	2.48 X 1.78 X 1.90 = 8.61 SQ.MT
5	0.84 X 3.08 X 1.90 = 3.12 SQ.MT
6	0.45 X 4.28 X 1.90 = 1.61 SQ.MT
7	3.20 X 4.02 X 1.90 = 24.12 SQ.MT
8	4.90 X 4.02 X 1.90 = 37.80 SQ.MT
9	4.00 X 2.81 X 1.90 = 17.20 SQ.MT
10	2.45 X 0.96 X 2.90 = 6.80 SQ.MT
11	2.40 X 5.50 X 1.90 = 25.74 SQ.MT
12	2.00 X 0.95 X 1.90 = 3.61 SQ.MT
13	4.70 X 2.25 X 1.90 = 17.10 SQ.MT
14	2.18 X 0.95 X 1.90 = 3.97 SQ.MT
15	4.55 X 0.65 X 1.90 = 5.36 SQ.MT
16	2.14 X 2.05 X 1.90 = 8.09 SQ.MT
17	2.71 X 2.60 X 1.90 = 10.59 SQ.MT
18	8.30 X 1.07 X 1.90 = 15.88 SQ.MT
19	1.00 X 1.50 X 2.90 = 4.35 SQ.MT
20	3.20 X 0.97 X 1.90 = 5.84 SQ.MT
21	4.45 X 1.07 X 1.90 = 8.76 SQ.MT
22	0.84 X 3.08 X 1.90 = 3.12 SQ.MT
23	2.48 X 1.78 X 1.90 = 8.61 SQ.MT
24	2.23 X 4.65 X 1.90 = 19.83 SQ.MT
25	1.196 X 4.14 X 1.90 = 9.06 SQ.MT
26	4.00 X 0.73 X 1.90 = 5.56 SQ.MT
27	2.40 X 3.05 X 1.90 = 11.32 SQ.MT
28	5.00 X 2.50 X 1.90 = 23.75 SQ.MT
29	2.18 X 1.45 X 1.90 = 7.52 SQ.MT
30	4.45 X 1.07 X 1.90 = 8.76 SQ.MT
31	8.30 X 1.07 X 1.90 = 15.88 SQ.MT
32	1.00 X 1.50 X 2.90 = 4.35 SQ.MT
33	2.90 X 0.54 X 2.90 = 4.51 SQ.MT
TOTAL BUILT UP AREA (A, Y1)	407.42 SQ.MT

LEFT AREA CALCULATION	
REMARKS	AREA
L1	2.85 X 4.71 X 2.90 = 38.96 SQ.MT
L2	2.70 X 1.17 X 2.90 = 8.91 SQ.MT
L3	2.70 X 3.11 X 2.90 = 23.94 SQ.MT
L4	1.30 X 0.15 X 1.90 = 0.38 SQ.MT
L5	1.30 X 0.15 X 1.90 = 0.38 SQ.MT
L6	2.70 X 1.17 X 2.90 = 8.91 SQ.MT
L7	2.70 X 3.11 X 2.90 = 23.94 SQ.MT
L8	1.30 X 0.15 X 1.90 = 0.38 SQ.MT
L9	1.30 X 0.15 X 1.90 = 0.38 SQ.MT
TOTAL LEFT AREA PER FL.	117.52 SQ.MT
TOTAL STAFF AREA CALCULATION	
ST1	7.25 X 3.98 X 1.90 = 54.06 SQ.MT
ST2	7.52 X 0.85 X 1.90 = 2.52 SQ.MT
ST3	6.75 X 6.00 X 1.90 = 78.53 SQ.MT
TOTAL STAFF AREA PER FL.	135.11 SQ.MT
TOTAL STAFF AREA CALCULATION	
ST4	1.50 X 1.45 X 2.90 = 6.30 SQ.MT
ST5	0.15 X 1.00 X 2.90 = 0.43 SQ.MT
ST6	2.15 X 6.68 X 1.90 = 26.36 SQ.MT
ST7	0.15 X 1.00 X 2.90 = 0.43 SQ.MT
ST8	2.85 X 2.15 X 1.90 = 10.37 SQ.MT
ST9	2.70 X 2.90 X 1.90 = 14.85 SQ.MT
ST10	0.60 X 0.50 X 1.90 = 0.57 SQ.MT
ST11	1.65 X 2.00 X 1.90 = 6.27 SQ.MT
ST12	1.25 X 2.00 X 1.90 = 4.75 SQ.MT
ST13	4.45 X 0.85 X 1.90 = 7.47 SQ.MT
ST14	2.00 X 2.34 X 1.90 = 8.46 SQ.MT
ST15	1.70 X 2.00 X 1.90 = 6.46 SQ.MT
ST16	1.25 X 2.00 X 1.90 = 4.75 SQ.MT
ST17	0.60 X 0.50 X 1.90 = 0.57 SQ.MT
ST18	1.65 X 2.00 X 1.90 = 6.27 SQ.MT
ST19	1.25 X 2.00 X 1.90 = 4.75 SQ.MT
ST20	2.00 X 2.34 X 1.90 = 8.46 SQ.MT
ST21	1.70 X 2.00 X 1.90 = 6.46 SQ.MT
ST22	1.25 X 2.00 X 1.90 = 4.75 SQ.MT
ST23	0.60 X 0.50 X 1.90 = 0.57 SQ.MT
ST24	1.65 X 2.00 X 1.90 = 6.27 SQ.MT
ST25	1.25 X 2.00 X 1.90 = 4.75 SQ.MT
ST26	2.00 X 2.34 X 1.90 = 8.46 SQ.MT
ST27	1.70 X 2.00 X 1.90 = 6.46 SQ.MT
ST28	1.25 X 2.00 X 1.90 = 4.75 SQ.MT
ST29	0.60 X 0.50 X 1.90 = 0.57 SQ.MT
ST30	1.65 X 2.00 X 1.90 = 6.27 SQ.MT
ST31	1.25 X 2.00 X 1.90 = 4.75 SQ.MT
ST32	2.00 X 2.34 X 1.90 = 8.46 SQ.MT
ST33	1.70 X 2.00 X 1.90 = 6.46 SQ.MT
ST34	1.25 X 2.00 X 1.90 = 4.75 SQ.MT
ST35	0.60 X 0.50 X 1.90 = 0.57 SQ.MT
ST36	1.65 X 2.00 X 1.90 = 6.27 SQ.MT
ST37	1.25 X 2.00 X 1.90 = 4.75 SQ.MT
ST38	2.00 X 2.34 X 1.90 = 8.46 SQ.MT
ST39	1.70 X 2.00 X 1.90 = 6.46 SQ.MT
ST40	1.25 X 2.00 X 1.90 = 4.75 SQ.MT
ST41	0.60 X 0.50 X 1.90 = 0.57 SQ.MT
ST42	1.65 X 2.00 X 1.90 = 6.27 SQ.MT
ST43	1.25 X 2.00 X 1.90 = 4.75 SQ.MT
ST44	2.00 X 2.34 X 1.90 = 8.46 SQ.MT
ST45	1.70 X 2.00 X 1.90 = 6.46 SQ.MT
ST46	1.25 X 2.00 X 1.90 = 4.75 SQ.MT
ST47	0.60 X 0.50 X 1.90 = 0.57 SQ.MT
ST48	1.65 X 2.00 X 1.90 = 6.27 SQ.MT
ST49	1.25 X 2.00 X 1.90 = 4.75 SQ.MT
ST50	2.00 X 2.34 X 1.90 = 8.46 SQ.MT
ST51	1.70 X 2.00 X 1.90 = 6.46 SQ.MT
ST52	1.25 X 2.00 X 1.90 = 4.75 SQ.MT
ST53	0.60 X 0.50 X 1.90 = 0.57 SQ.MT
ST54	1.65 X 2.00 X 1.90 = 6.27 SQ.MT
ST55	1.25 X 2.00 X 1.90 = 4.75 SQ.MT
ST56	2.00 X 2.34 X 1.90 = 8.46 SQ.MT
ST57	1.70 X 2.00 X 1.90 = 6.46 SQ.MT
ST58	1.25 X 2.00 X 1.90 = 4.75 SQ.MT
ST59	0.60 X 0.50 X 1.90 = 0.57 SQ.MT
ST60	1.65 X 2.00 X 1.90 = 6.27 SQ.MT
ST61	1.25 X 2.00 X 1.90 = 4.75 SQ.MT
ST62	2.00 X 2.34 X 1.90 = 8.46 SQ.MT
ST63	1.70 X 2.00 X 1.90 = 6.46 SQ.MT
ST64	1.25 X 2.00 X 1.90 = 4.75 SQ.MT
ST65	0.60 X 0.50 X 1.90 = 0.57 SQ.MT
ST66	1.65 X 2.00 X 1.90 = 6.27 SQ.MT
ST67	1.25 X 2.00 X 1.90 = 4.75 SQ.MT
ST68	2.00 X 2.34 X 1.90 = 8.46 SQ.MT
ST69	1.70 X 2.00 X 1.90 = 6.46 SQ.MT
ST70	1.25 X 2.00 X 1.90 = 4.75 SQ.MT
ST71	0.60 X 0.50 X 1.90 = 0.57 SQ.MT
ST72	1.65 X 2.00 X 1.90 = 6.27 SQ.MT
ST73	1.25 X 2.00 X 1.90 = 4.75 SQ.MT
ST74	2.00 X 2.34 X 1.90 = 8.46 SQ.MT
ST75	1.70 X 2.00 X 1.90 = 6.46 SQ.MT
ST76	1.25 X 2.00 X 1.90 = 4.75 SQ.MT
ST77	0.60 X 0.50 X 1.90 = 0.57 SQ.MT
ST78	1.65 X 2.00 X 1.90 = 6.27 SQ.MT
ST79	1.25 X 2.00 X 1.90 = 4.75 SQ.MT
ST80	2.00 X 2.34 X 1.90 = 8.46 SQ.MT
ST81	1.70 X 2.00 X 1.90 = 6.46 SQ.MT
ST82	1.25 X 2.00 X 1.90 = 4.75 SQ.MT
ST83	0.60 X 0.50 X 1.90 = 0.57 SQ.MT
ST84	1.65 X 2.00 X 1.90 = 6.27 SQ.MT
ST85	1.25 X 2.00 X 1.90 = 4.75 SQ.MT
ST86	2.00 X 2.34 X 1.90 = 8.46 SQ.MT
ST87	1.70 X 2.00 X 1.90 = 6.46 SQ.MT
ST88	1.25 X 2.00 X 1.90 = 4.75 SQ.MT
ST89	0.60 X 0.50 X 1.90 = 0.57 SQ.MT
ST90	1.65 X 2.00 X 1.90 = 6.27 SQ.MT
ST91	1.25 X 2.00 X 1.90 = 4.75 SQ.MT
ST92	2.00 X 2.34 X 1.90 = 8.46 SQ.MT
ST93	1.70 X 2.00 X 1.90 = 6.46 SQ.MT
ST94	1.25 X 2.00 X 1.90 = 4.75 SQ.MT
ST95	0.60 X 0.50 X 1.90 = 0.57 SQ.MT
ST96	1.65 X 2.00 X 1.90 = 6.27 SQ.MT
ST97	1.25 X 2.00 X 1.90 = 4.75 SQ.MT
ST98	2.00 X 2.34 X 1.90 = 8.46 SQ.MT
ST99	1.70 X 2.00 X 1.90 = 6.46 SQ.MT
ST100	1.25 X 2.00 X 1.90 = 4.75 SQ.MT
ST101	0.60 X 0.50 X 1.90 = 0.57 SQ.MT
ST102	1.65 X 2.00 X 1.90 = 6.27 SQ.MT
ST103	1.25 X 2.00 X 1.90 = 4.75 SQ.MT
ST104	2.00 X 2.34 X 1.90 = 8.46 SQ.MT
ST105	1.70 X 2.00 X 1.90 = 6.46 SQ.MT
ST106	1.25 X 2.00 X 1.90 = 4.75 SQ.MT
ST107	0.60 X 0.50 X 1.90 = 0.57 SQ.MT
ST108	1.65 X 2.00 X 1.90 = 6.27 SQ.MT
ST109	1.25 X 2.00 X 1.90 = 4.75 SQ.MT
ST110	2.00 X 2.34 X 1.90 = 8.46 SQ.MT
ST111	1.70 X 2.00 X 1.90 = 6.46 SQ.MT
ST112	1.25 X 2.00 X 1.90 = 4.75 SQ.MT
ST113	0.60 X 0.50 X 1.90 = 0.57 SQ.MT
ST114	1.65 X 2.00 X 1.90 = 6.27 SQ.MT
ST115	1.25 X 2.00 X 1.90 = 4.75 SQ.MT
ST116	2.00 X 2.34 X 1.90 = 8.46 SQ.MT
ST117	1.70 X 2.00 X 1.90 = 6.46 SQ.MT
ST118	1.25 X 2.00 X 1.90 = 4.75 SQ.MT
ST119	0.60 X 0.50 X 1.90 = 0.57 SQ.MT
ST120	1.65 X 2.00 X 1.90 = 6.27 SQ.MT
ST121	1.25 X 2.00 X 1.90 = 4.75 SQ.MT
ST122	2.00 X 2.34 X 1.90 = 8.46 SQ.MT
ST123	1.70 X 2.00 X 1.90 = 6.46 SQ.MT
ST124	1.25 X 2.00 X 1.90 = 4.75 SQ.MT
ST125	0.60 X 0.50 X 1.90 = 0.57 SQ.MT
ST126	1.65 X 2.00 X 1.90 = 6.27 SQ.MT
ST127	1.25 X 2.00 X 1.90 = 4.75 SQ.MT
ST128	2.00 X 2.34 X 1.90 = 8.46 SQ.MT
ST129	1.70 X 2.00 X 1.90 = 6.46 SQ.MT
ST130	1.25 X 2.00 X 1.90 = 4.75 SQ.MT
ST131	0.60 X 0.50 X 1.90 = 0.57 SQ.MT
ST132	1.65 X 2.00 X 1.90 = 6.27 SQ.MT
ST133	1.25 X 2.00 X 1.90 = 4.75 SQ.MT
ST134	2.00 X 2.34 X 1.90 = 8.46 SQ.MT
ST135	1.70 X 2.00 X 1.90 = 6.46 SQ.MT
ST136	1.25 X 2.00 X 1.90 = 4.75 SQ.MT
ST137	0.60 X 0.50 X 1.90 = 0.57 SQ.MT
ST138	1.65 X 2.00 X 1.90 = 6.27 SQ.MT
ST139	1.25 X 2.00 X 1.90 = 4.75 SQ.MT
ST140	2.00 X 2.34 X 1.90 = 8.46 SQ.MT
ST141	1.70 X 2.00 X 1.90 = 6.46 SQ.MT
ST142	1.25 X 2.00 X 1.90 = 4.75 SQ.MT
ST143	0.60 X 0.50 X 1.90 = 0.57 SQ.MT
ST144	1.65 X 2.00 X 1.90 = 6.27 SQ.MT
ST145	1.25 X 2.00 X 1.90 = 4.75 SQ.MT
ST146	2.00 X 2.34 X 1.90 = 8.46 SQ.MT
ST147	1.70 X 2.00 X 1.90 = 6.46 SQ.MT
ST148	1.25 X 2.00 X 1.90 = 4.75 SQ.MT
ST149	0.60 X 0.50 X 1.90 = 0.57 SQ.MT
ST150	1.65 X 2.00 X 1.90 = 6.27 SQ.MT
ST151	1.25 X 2.00 X 1.90 = 4.75 SQ.MT
ST152	2.00 X 2.34 X 1.90 = 8.46 SQ.MT
ST153	1.70 X 2.00 X 1.90 = 6.46 SQ.MT
ST154	1.25 X 2.00 X 1.90 = 4.75 SQ.MT
ST155	0.60 X 0.50 X 1.90 = 0.57 SQ.MT
ST156	1.65 X 2.00 X 1.90 = 6.27 SQ.MT
ST157	1.25 X 2.00 X 1.90 = 4.75 SQ.MT
ST158	2.00 X 2.34 X 1.90 = 8.46 SQ.MT
ST159	1.70 X 2.00 X 1.90 = 6.46 SQ.MT
ST160	1.25 X 2.00 X 1.90 = 4.75 SQ.MT
ST161	0.60 X 0.50 X 1.90 = 0.57 SQ.MT
ST162	1.65 X 2.00 X 1.90 = 6.27 SQ.MT
ST163	1.25 X 2.00 X 1.90 = 4.75 SQ.MT
ST164	2.00 X 2.34 X 1.90 = 8.46 SQ.MT
ST165	1.70 X 2.00 X 1.90 = 6.46 SQ.MT
ST166	1.25 X 2.00 X 1.90 = 4.75 SQ.MT
ST167	0.60 X 0.50 X 1.90 = 0.57 SQ.MT
ST168	1.65 X 2.00 X 1.90 = 6.27 SQ.MT
ST169	1.25 X 2.00 X 1.90 = 4.75 SQ.MT
ST170	2.00 X 2.34 X 1.90 = 8.46 SQ.MT
ST171	1.70 X 2.00 X 1.90 = 6.46 SQ.MT
ST172	1.25 X 2.00 X 1.90 = 4.75 SQ.MT
ST173	0.60 X 0.50 X 1.90 = 0.57 SQ.MT
ST174	1.65 X 2.00 X 1.90 = 6.27 SQ.MT
ST175	1.25 X 2.00 X 1.90 = 4.75 SQ.MT
ST176	2.00 X 2.34 X 1.90 = 8.46 SQ.MT
ST177	1.70 X 2.00 X 1.90 = 6.46 SQ.MT
ST178	1.25 X 2.00 X 1.90 = 4.75 SQ.MT
ST179	0.60 X 0.50 X 1.90 = 0.57 SQ.MT
ST180	1.65 X 2.00 X 1.90 = 6.27 SQ.MT
ST181	1.25 X 2.00 X 1.90 = 4.75 SQ.MT
ST182	2.00 X 2.34 X 1.90 = 8.46 SQ.MT
ST183	1.70 X 2.00 X 1.90 = 6.46 SQ.MT
ST184	1.25 X 2.00 X 1.90 = 4.75 SQ.MT
ST185	0.60 X 0.50 X 1.90 = 0.57 SQ.MT
ST186	1.65 X 2.00 X 1.90 = 6.27 SQ.MT
ST187	1.25 X 2.00 X 1.90 = 4.75 SQ.MT
ST188	2.00 X 2.34 X 1.90 = 8.46 SQ.MT
ST189	1.70 X 2.00 X 1.90 = 6.46 SQ.MT
ST190	1.25 X 2.00 X 1.90 = 4.75 SQ.MT
ST191	0.60 X 0.50 X 1.90 = 0.57 SQ.MT
ST192	1.65 X 2.00 X 1.90 = 6.27 SQ.MT
ST193	1.25 X 2.00 X 1.90 = 4.75 SQ.MT
ST194	2.00 X 2.34 X 1.90 = 8.46 SQ.MT
ST195	1.70 X 2.00 X 1.90 = 6.46 SQ.MT
ST196	1.25 X 2.00 X 1.90 = 4.75 SQ.MT
ST197	0.60 X 0.50 X 1.90 = 0.57 SQ.MT
ST198	1.65 X 2.00 X 1.90 = 6.27 SQ.MT
ST199	1.25 X 2.00 X 1.90 = 4.75 SQ.MT
ST200	2.00 X 2.34 X 1.90 = 8.46 SQ.MT
ST201	1.70 X 2.00 X 1.90 = 6.46 SQ.MT
ST202	1.25 X 2.00 X 1.90 = 4.75 SQ.MT
ST203	0.60 X 0.50 X 1.90 = 0.57 SQ.MT
ST204	1.65 X 2.00 X 1.90 = 6.27 SQ.MT
ST205	1.25 X 2.00 X 1.90 = 4.75 SQ.MT
ST206	2.00 X 2.34 X 1.90 = 8.46 SQ.MT
ST207	1.70 X 2.00 X 1.90 = 6.46 SQ.MT
ST208	1.25 X 2.00 X 1.90 = 4.75 SQ.MT
ST209	0.60 X 0.50 X 1.90 = 0.57 SQ.MT
ST210	1.65 X 2.00 X 1.90 = 6.27 SQ.MT
ST211	1.25 X 2.00 X 1.90 = 4.75 SQ.MT
ST212	2.00 X 2.34 X 1.90 = 8.46 SQ.MT
ST213	1.70 X 2.00 X 1.90 = 6.46 SQ.MT
ST214	1.25 X 2.00 X 1.90 = 4.75 SQ.MT
ST215	0.60 X 0.50 X 1.90 = 0.57 SQ.MT
ST216	1.65 X 2.00 X 1.90 = 6.27 SQ.MT
ST217	1.25 X 2.00 X 1.90 = 4.75 SQ.MT
ST218	2.00 X 2.34 X 1.90 = 8.46 SQ.MT
ST219	1.70 X 2.00 X 1.90 = 6.46 SQ.MT
ST220	1.25 X 2.00 X 1.90 = 4.75 SQ.MT
ST221	0.60 X 0.50 X 1.90 = 0.57 SQ.MT
ST222	1.65 X 2.00 X 1.90 = 6.27 SQ.MT
ST223	1.25 X 2.00 X 1.90 = 4.75 SQ.MT
ST224	2.00 X 2.34 X 1.90 = 8.46 SQ.MT
ST225	1.70 X 2.00 X 1.90 = 6.46 SQ.MT
ST226	1.25 X 2.00 X 1.90 = 4.75 SQ.MT
ST227	0.60 X 0.50 X 1.90 = 0.57 SQ.MT

CONTENTS OF SHEET
5th to 9th TYPICAL FLOOR PLAN, 10th, 17th & 24TH REFUGE FLOOR PLAN, LINE AREA DIAGRAM, AREA CALCULATION, & REFUGE AREA STATEMENT. (WING-T-4)

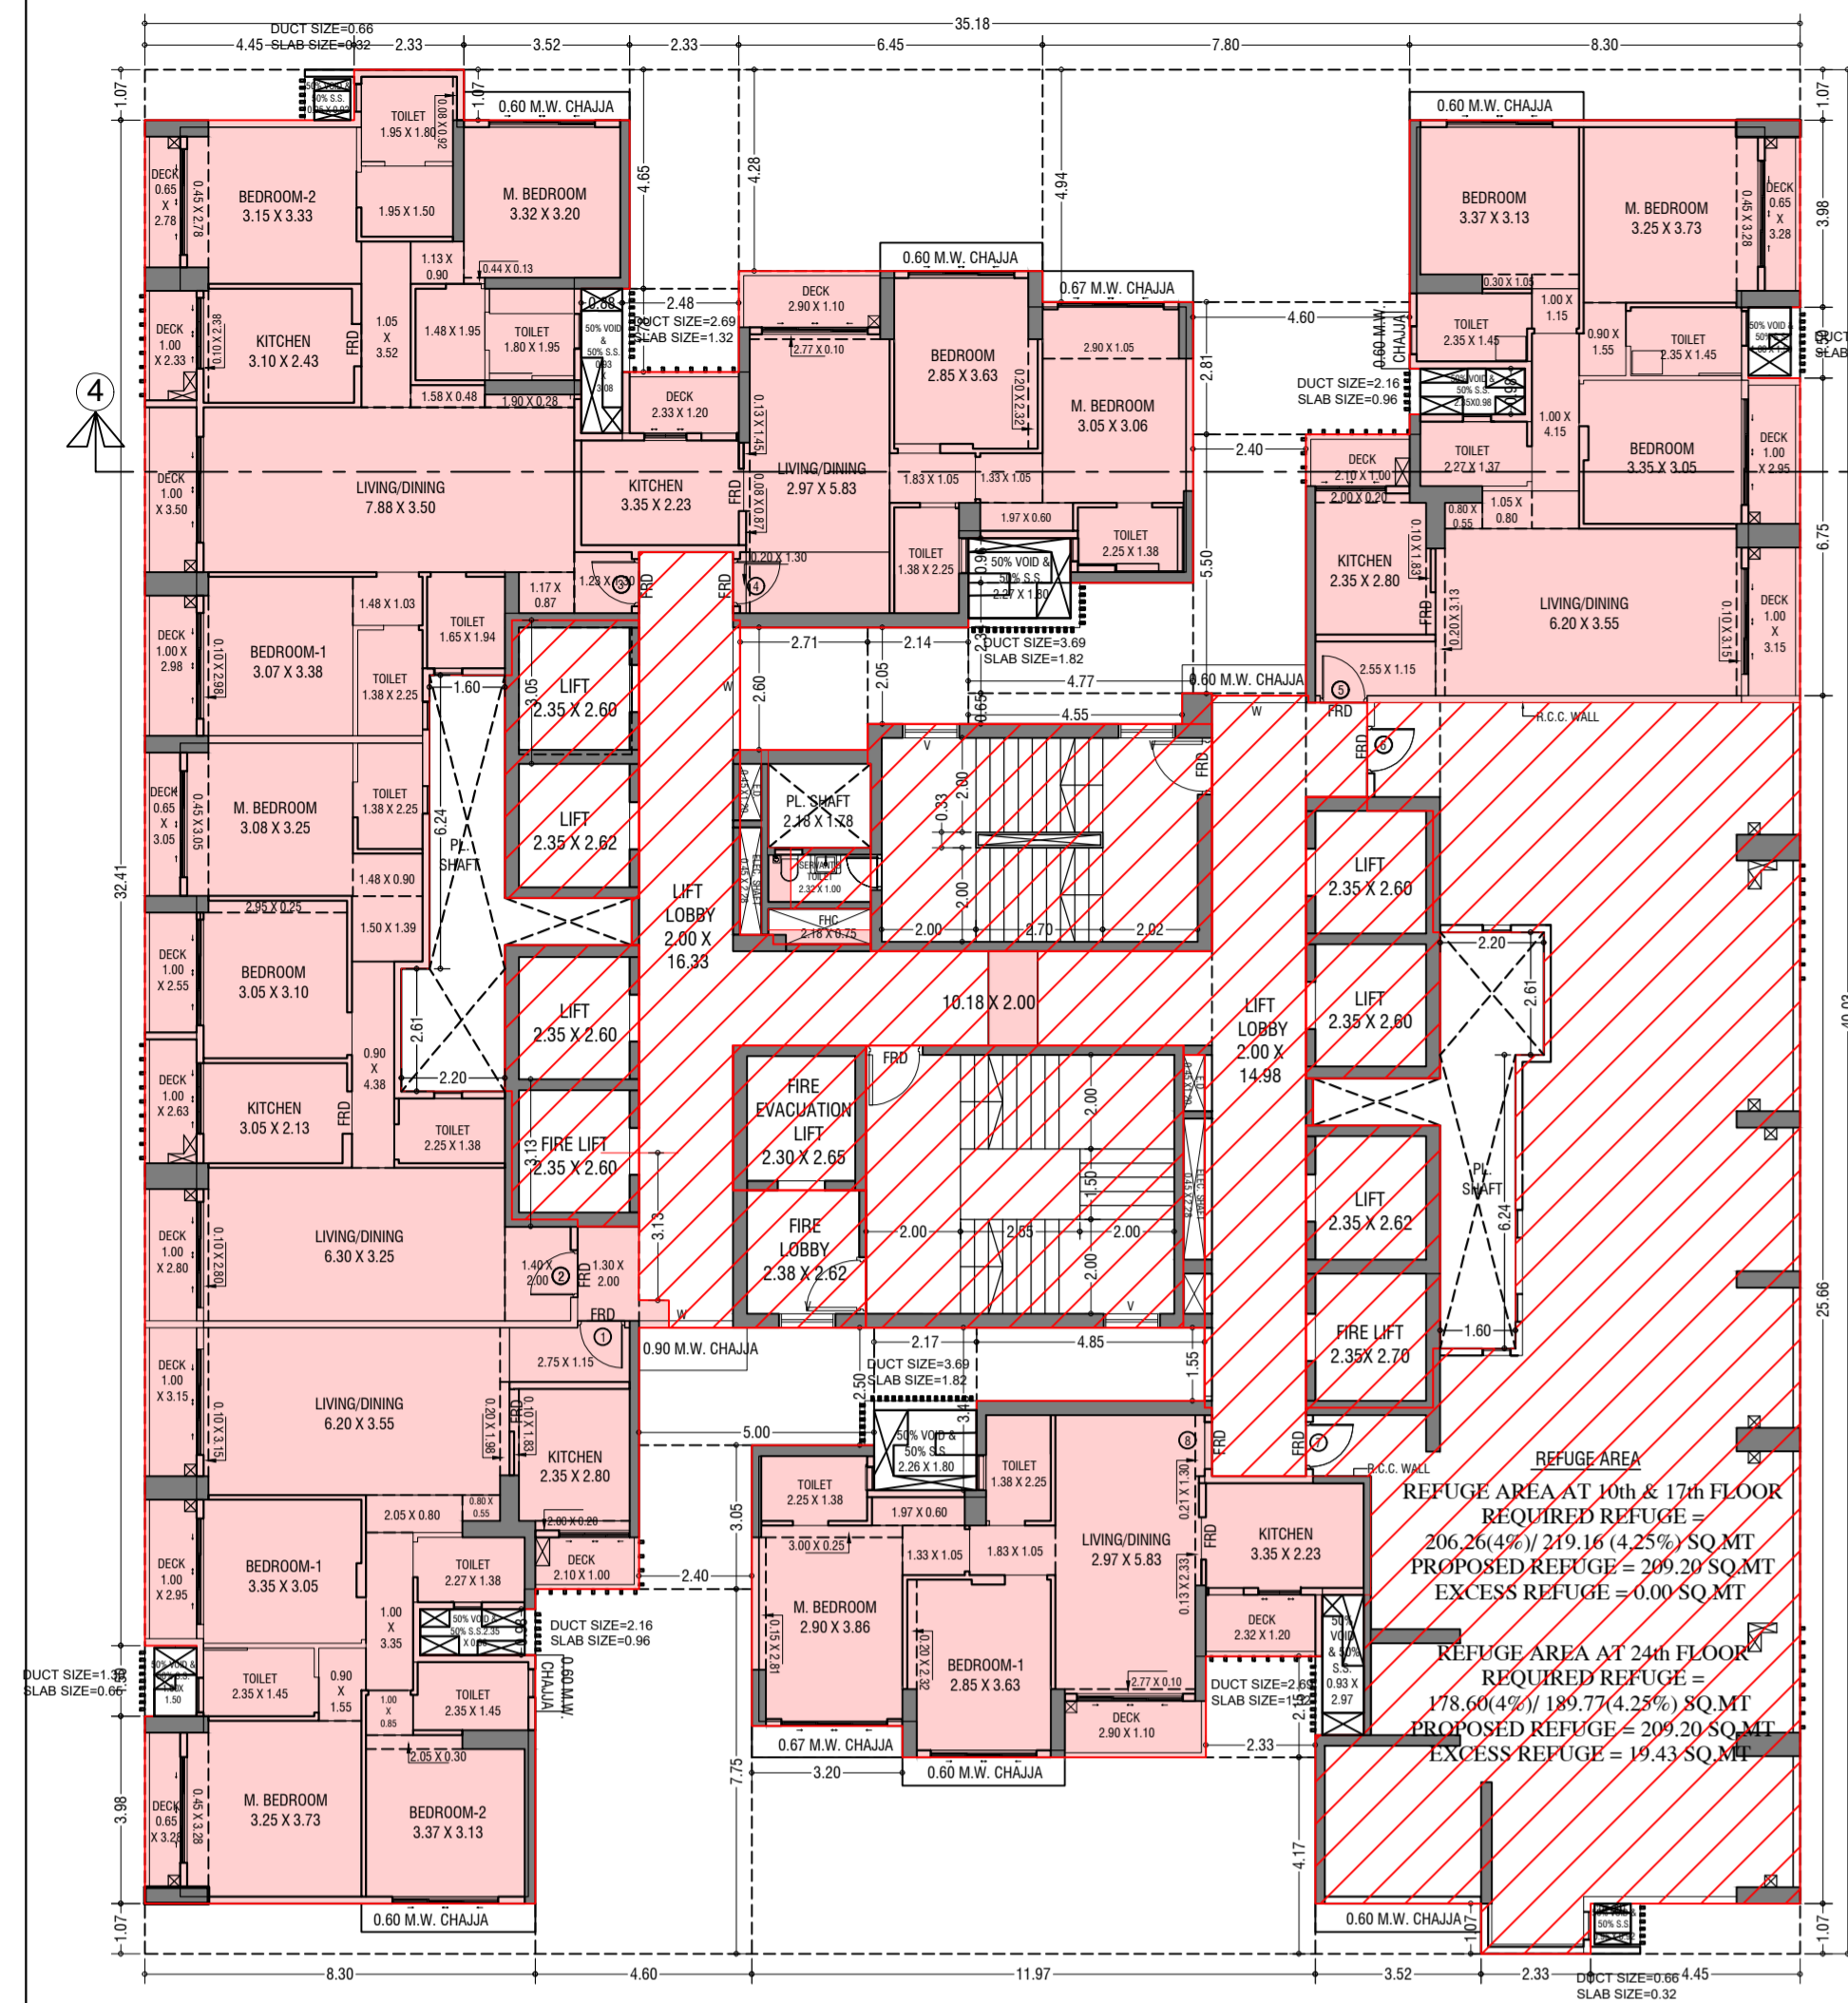


10th, 17th & 24th REFUGE FLOOR PLAN (WING-T-4)
SCALE: 1:100

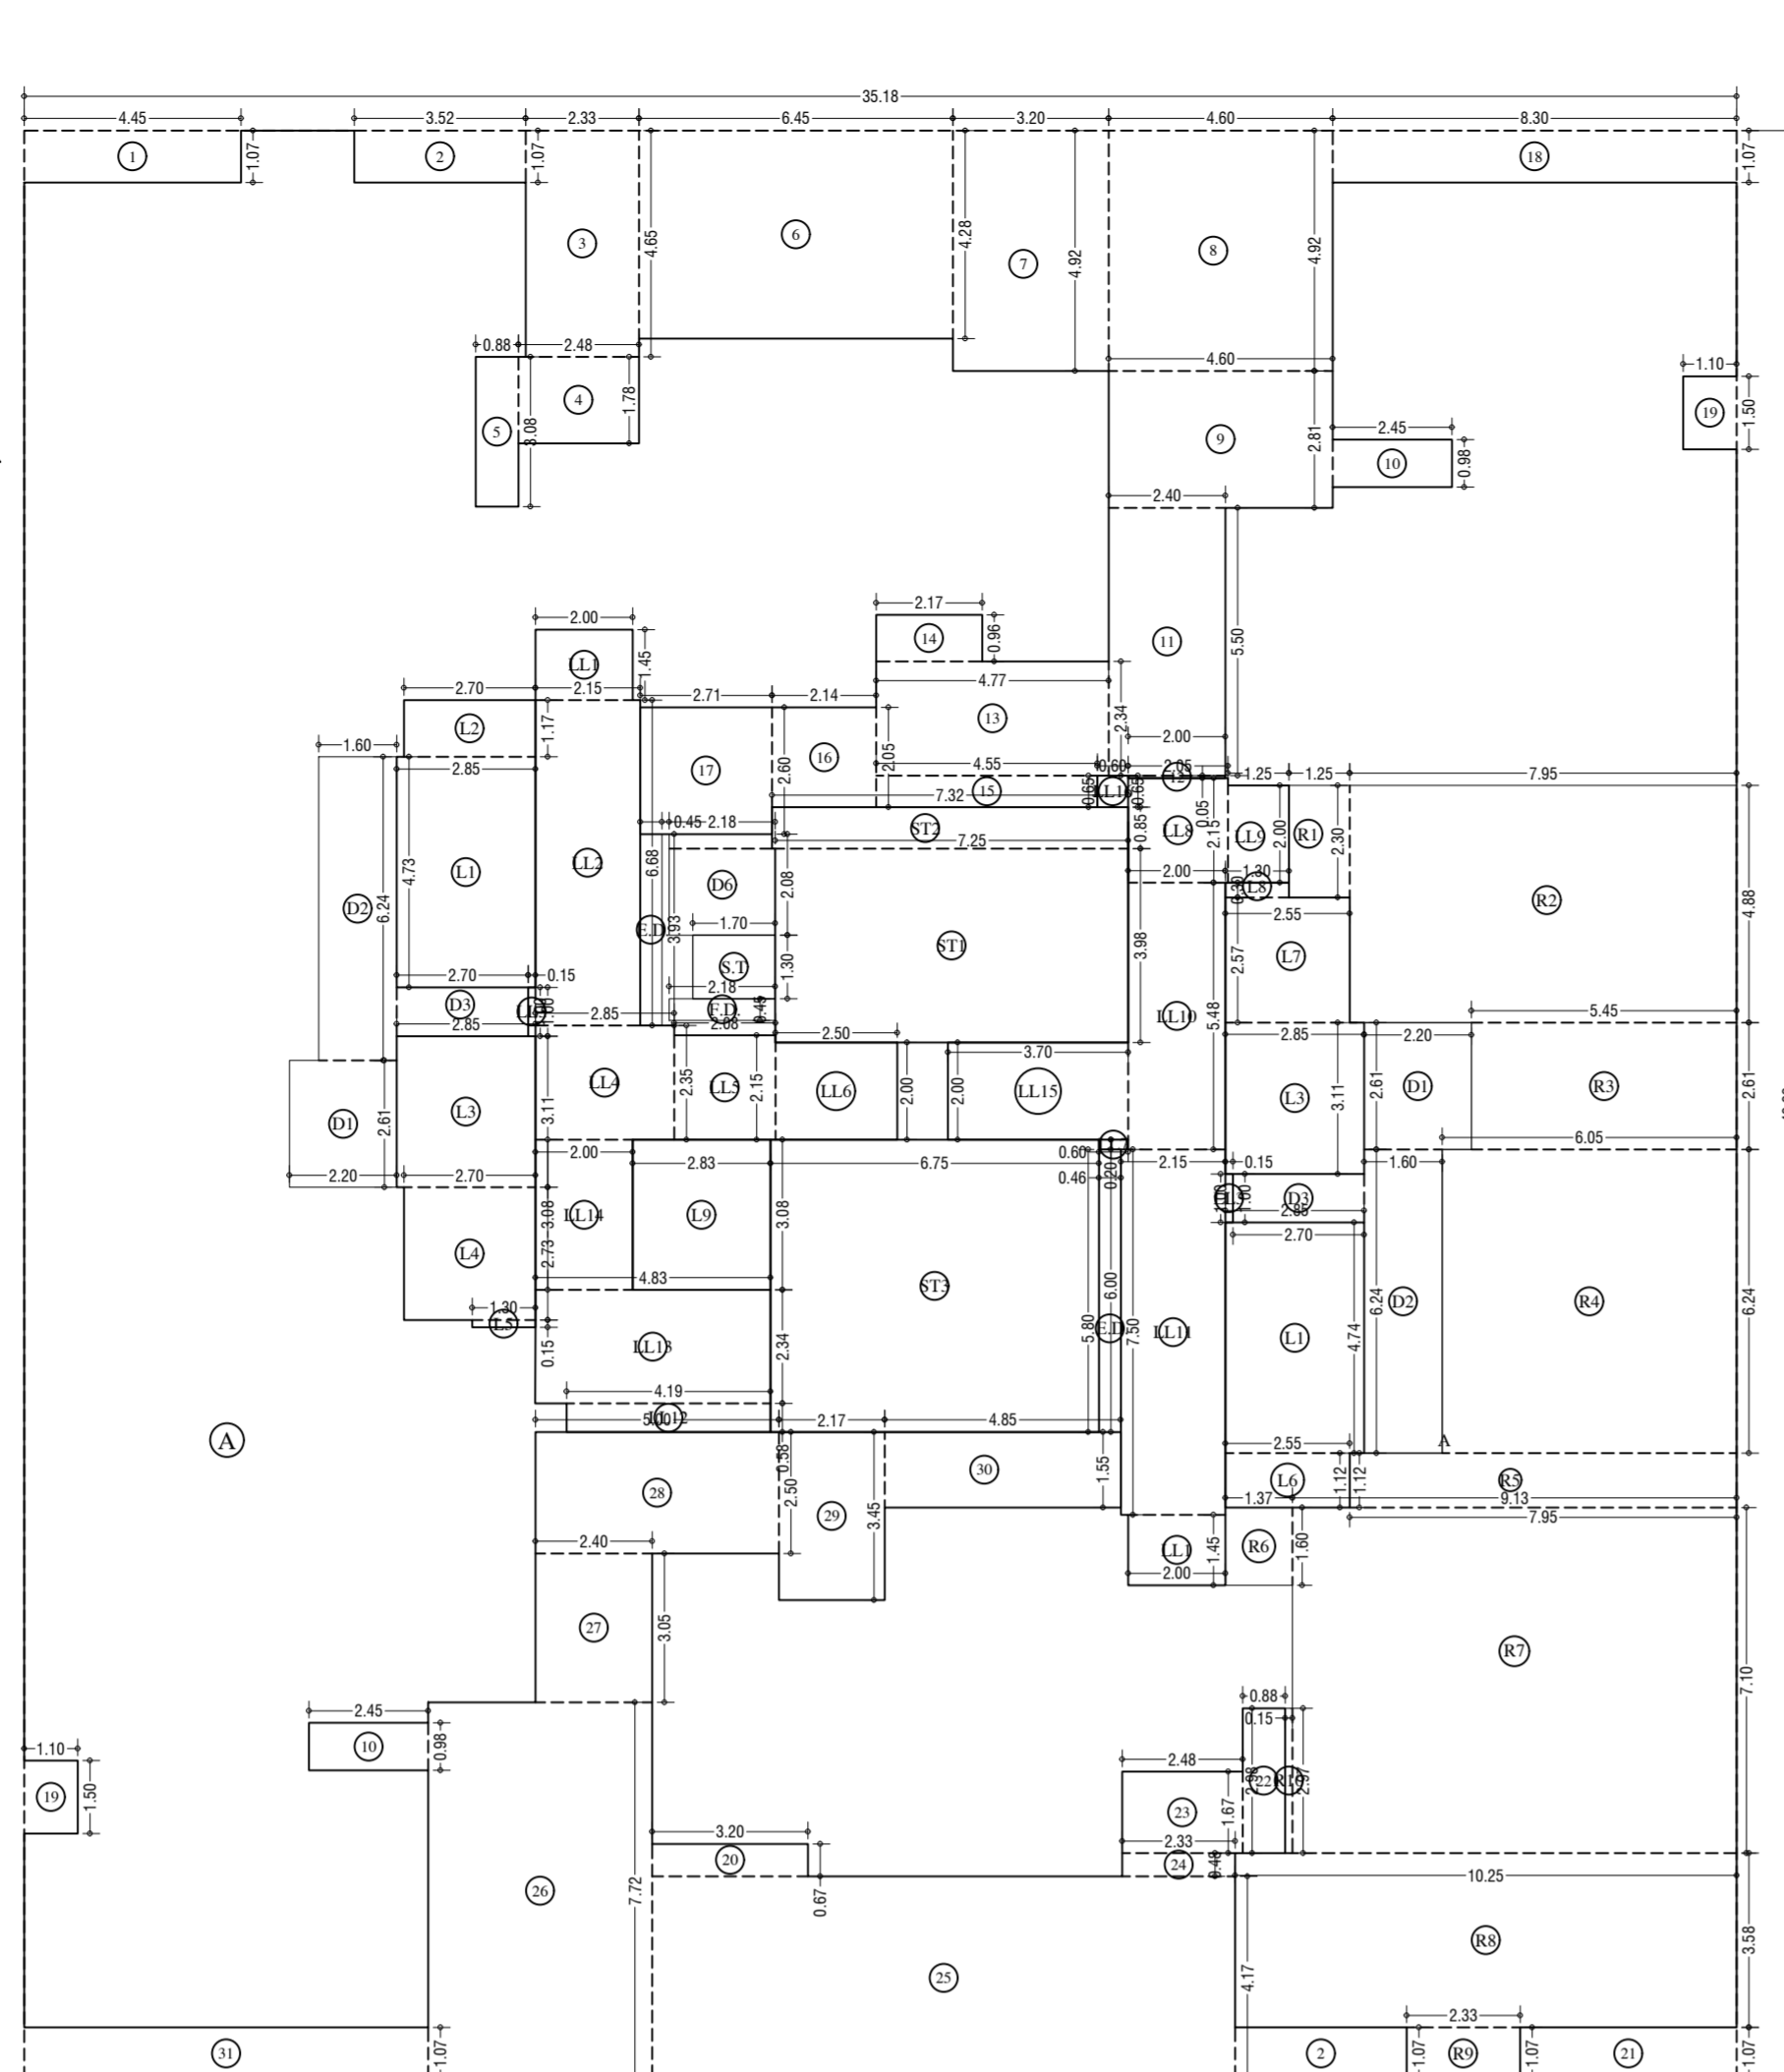

LINE AREA DIAGRAM FOR 10th, 17th & 24th REFUGE FLOOR. (WING-T-4)
SCALE: 1:100


Table with 3 columns: ROOM NO., ROOM AREA, and TOTAL AREA. It lists 44 rooms and their respective areas, including bedrooms, living areas, and a total area of 1891.50 SQM.

Table with 3 columns: ROOM NO., ROOM AREA, and TOTAL AREA. It lists 44 rooms and their respective areas, including bedrooms, living areas, and a total area of 1891.50 SQM.

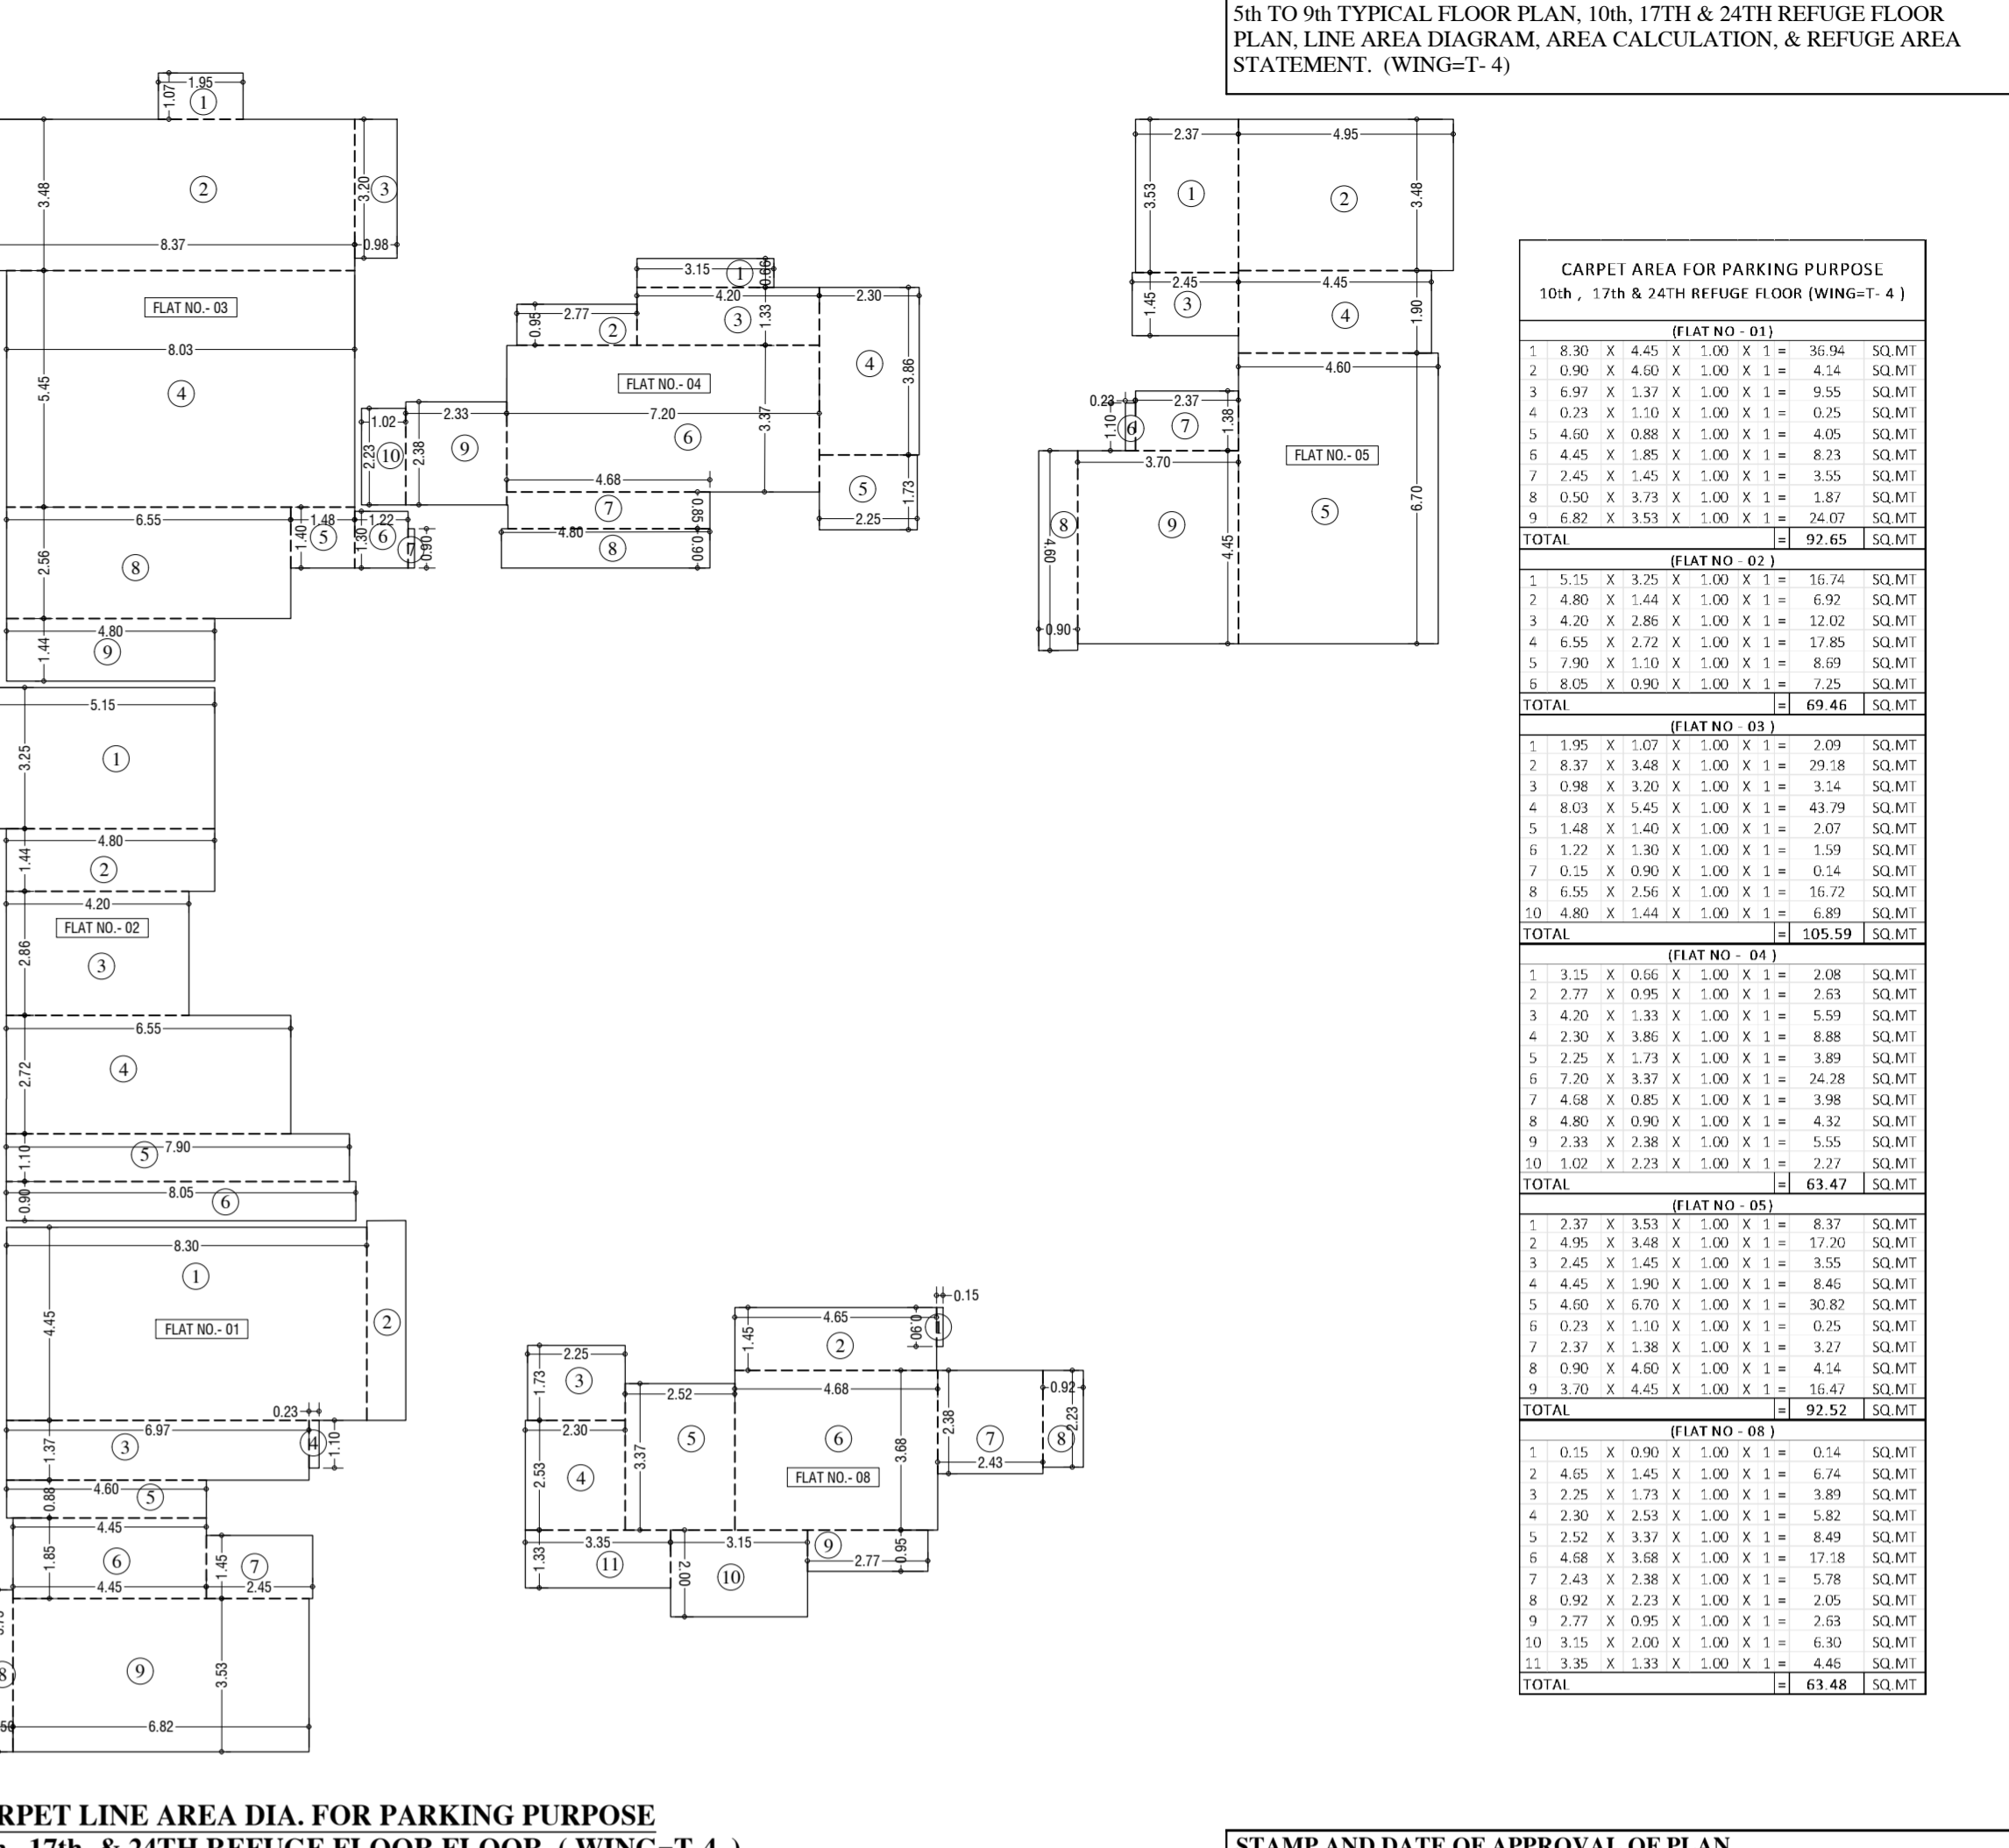


CARPET LINE AREA DIA. FOR PARKING PURPOSE
10th, 17th & 24TH REFUGE FLOOR. (WING-T-4)
SCALE: 1:100

Table with 3 columns: ROOM NO., ROOM AREA, and TOTAL AREA. It lists 44 rooms and their respective areas, including bedrooms, living areas, and a total area of 1891.50 SQM.

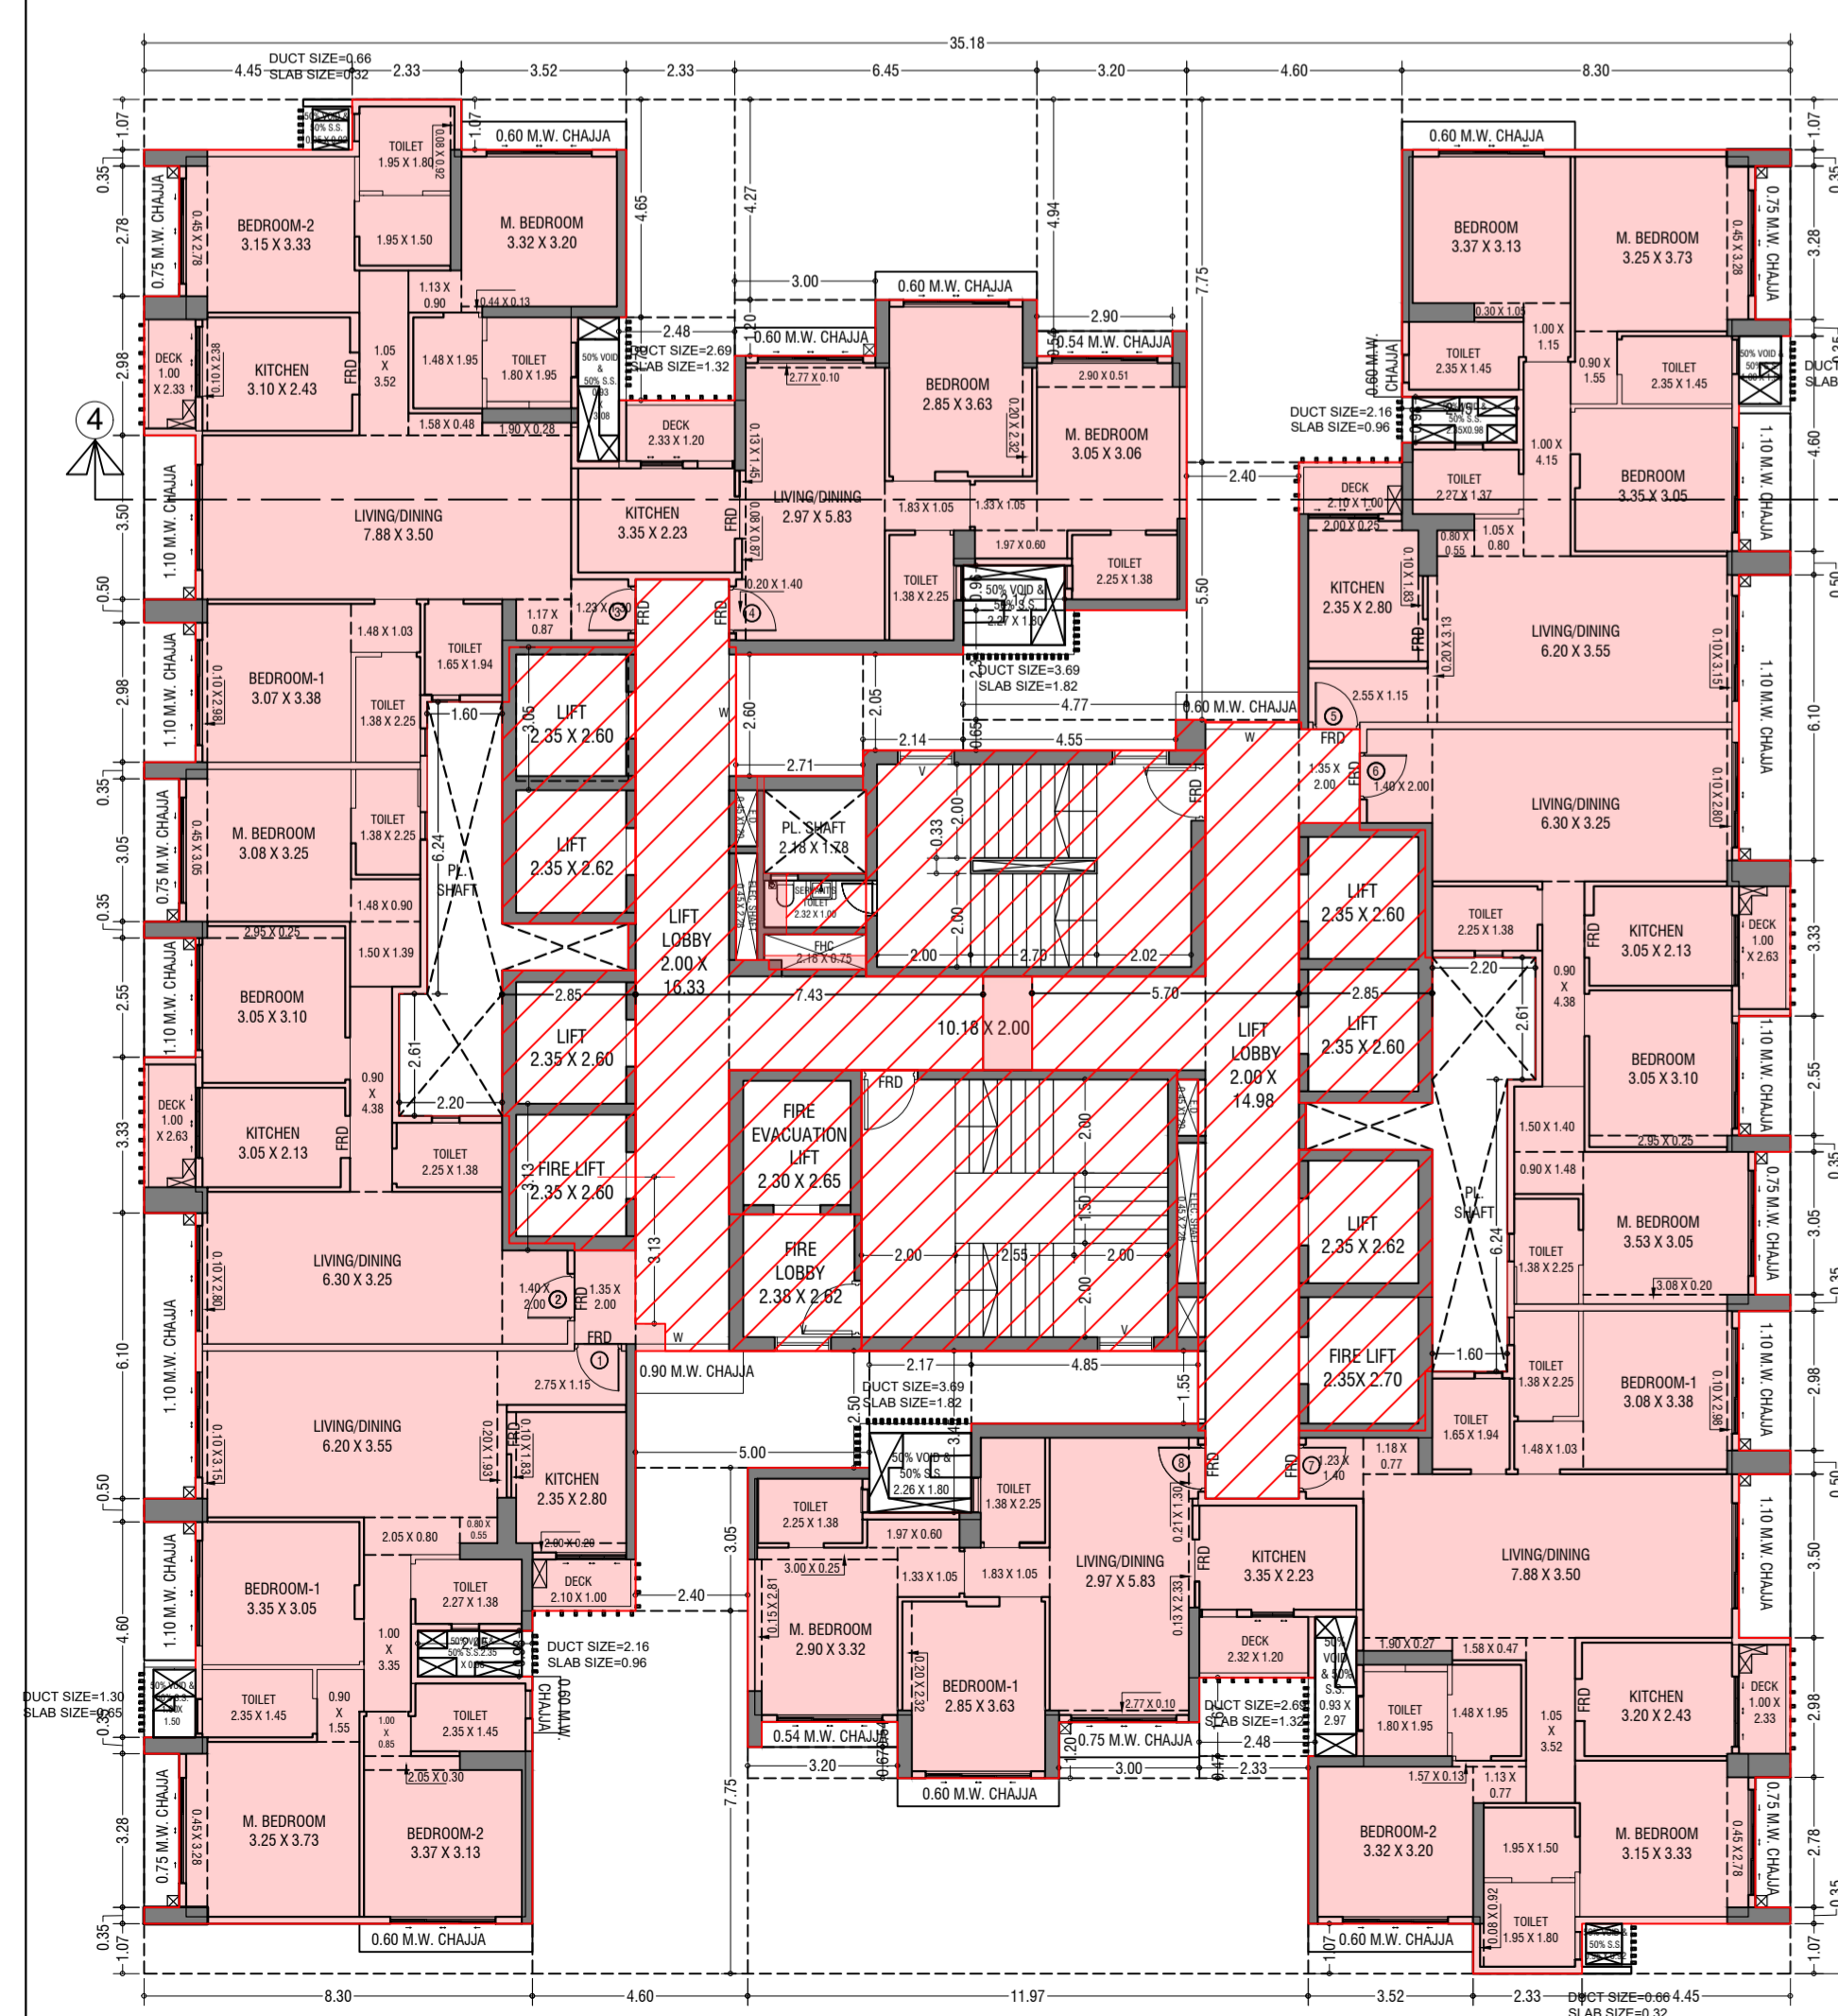


5th to 9th TYPICAL FLOOR PLAN (WING-T-4)
SCALE: 1:100

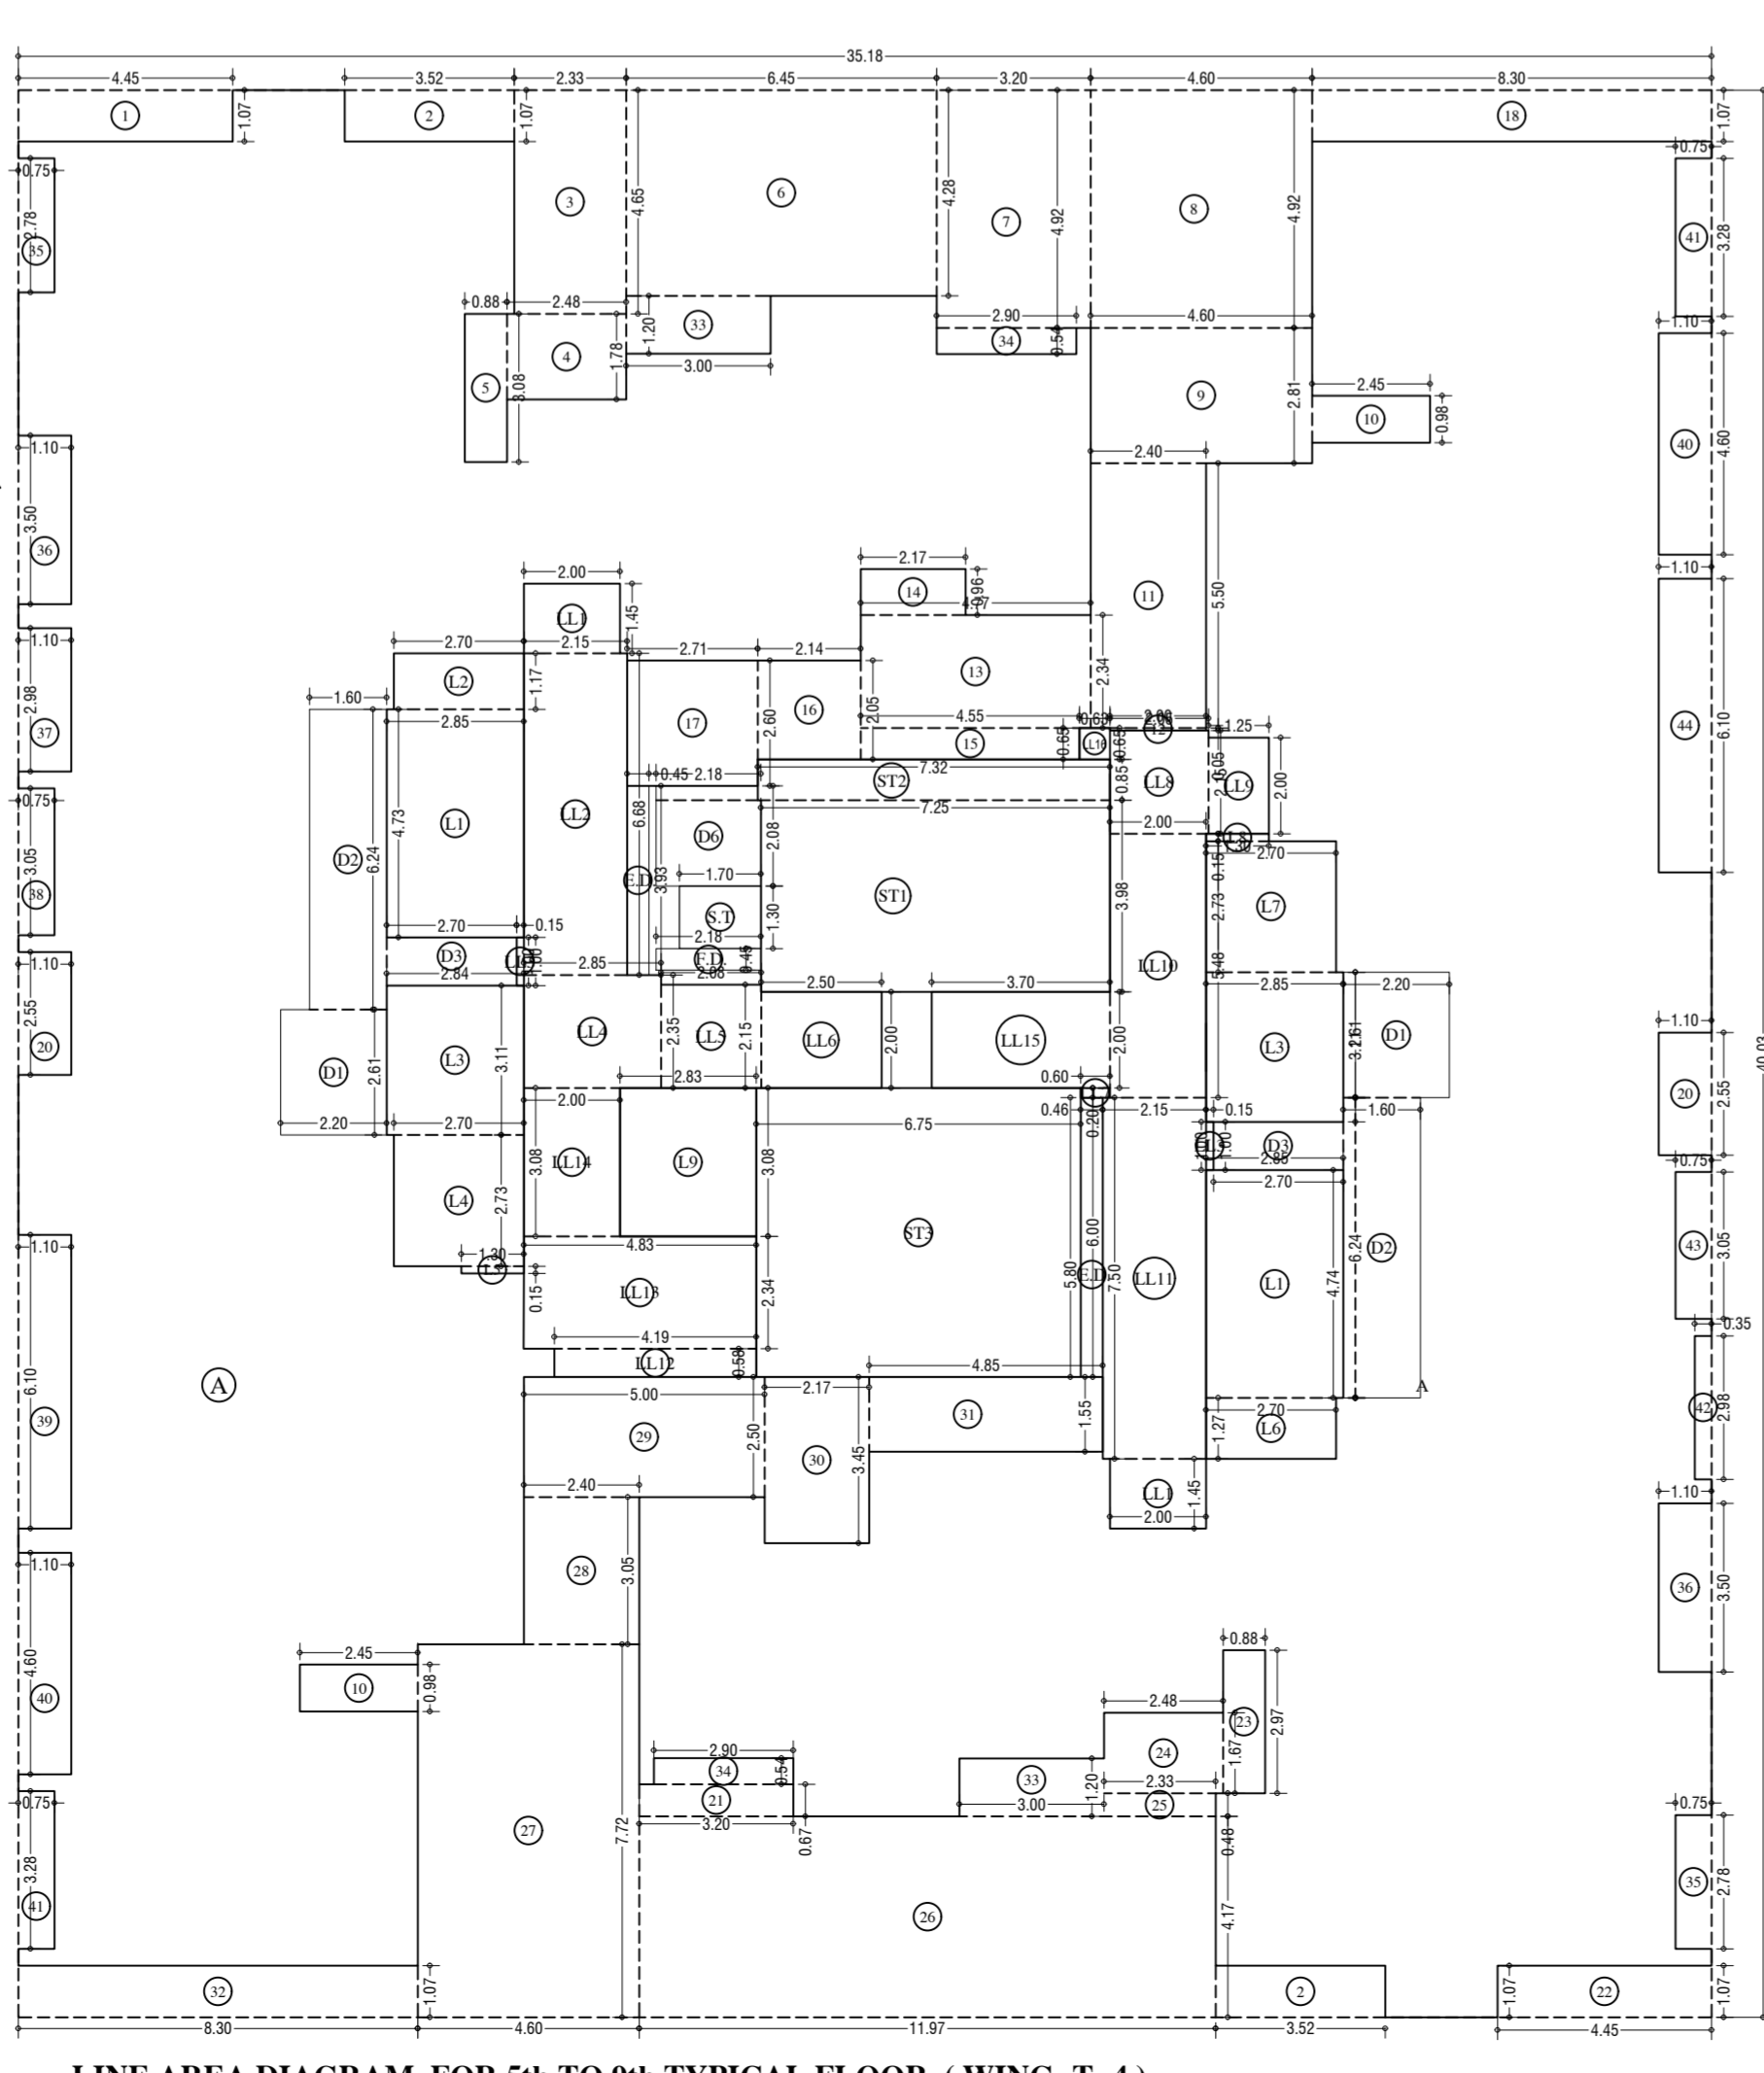

LINE AREA DIAGRAM FOR 5th to 9th TYPICAL FLOOR. (WING-T-4)
SCALE: 1:100

Table with 3 columns: ROOM NO., ROOM AREA, and TOTAL AREA. It lists 44 rooms and their respective areas, including bedrooms, living areas, and a total area of 1891.50 SQM.

Table with 3 columns: ROOM NO., ROOM AREA, and TOTAL AREA. It lists 44 rooms and their respective areas, including bedrooms, living areas, and a total area of 1891.50 SQM.

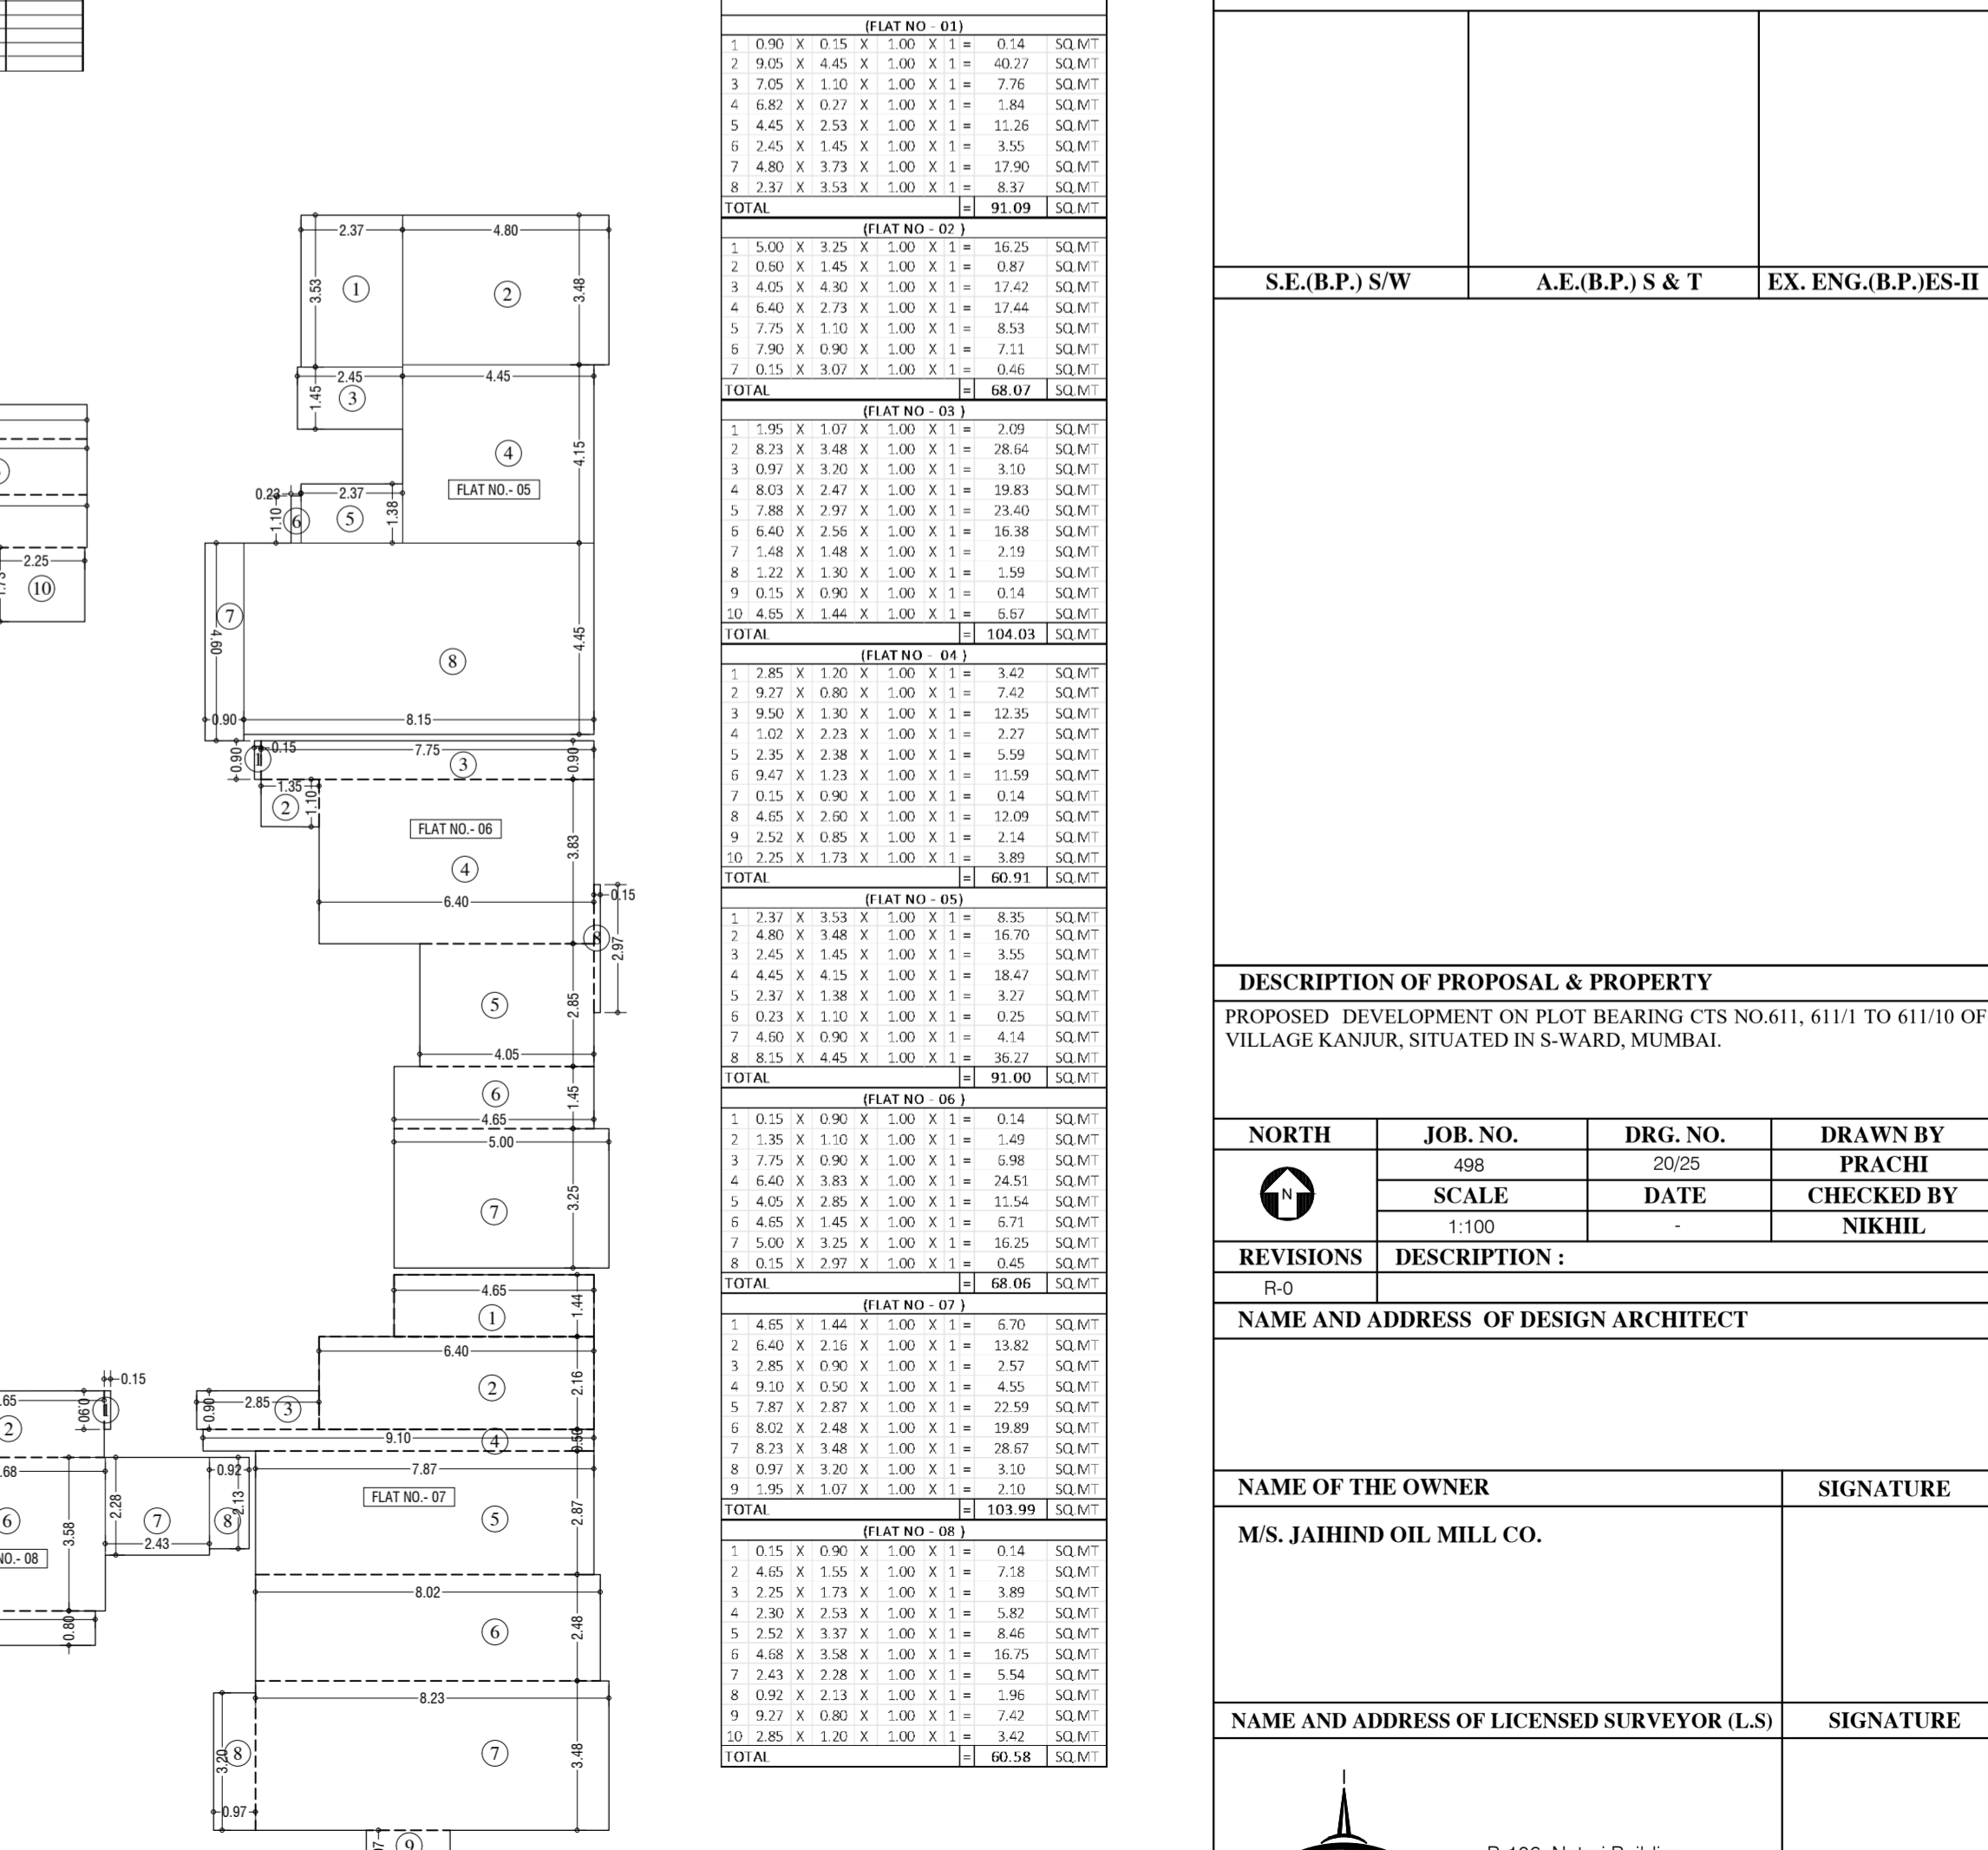

CARPET LINE AREA DIA. FOR PARKING PURPOSE
5th to 9th FLOOR. (WING-T-4)
SCALE: 1:100

Table with 3 columns: ROOM NO., ROOM AREA, and TOTAL AREA. It lists 44 rooms and their respective areas, including bedrooms, living areas, and a total area of 1891.50 SQM.

STAMP AND DATE OF APPROVAL OF PLAN
APPROVED SUBJECT TO THE CONDITIONS MENTIONED IN THIS OFFICE LETTER NO P-12131/2022(611 And Other's) Ward/Kanjur-W

S.E.(R.P.) S/W A.E.(R.P.) S & T EX. ENG.(R.P./ES-II

DESCRIPTION OF PROPOSAL & PROPERTY
PROPOSED DEVELOPMENT ON PLOT BEARING CTS NO.611, 6111 to 6110 to 6110/10 OF VILLAGE KANJUR, SITUATED IN S.W. MUMBAI.

REVISIONS DESCRIPTION:

NAME AND ADDRESS OF DESIGN ARCHITECT


NAME OF THE OWNER M.S. JAHND OIL MILL CO. SIGNATURE

NAME AND ADDRESS OF LICENSED SURVEYOR (L.S.) SIGNATURE

CONTENTS OF SHEET
11th, 18th & 25th TYPICAL FLOOR PLAN, 12th to 16th, 19th to 23rd
TYPICAL FLOOR PLAN, LINE AREA DIAGRAM & AREA CALCULATION.
(WING=T-4)




12th to 16th & 19th to 23rd TYPICAL FLOOR PLAN (WING=T-4)
SCALE: 1:100

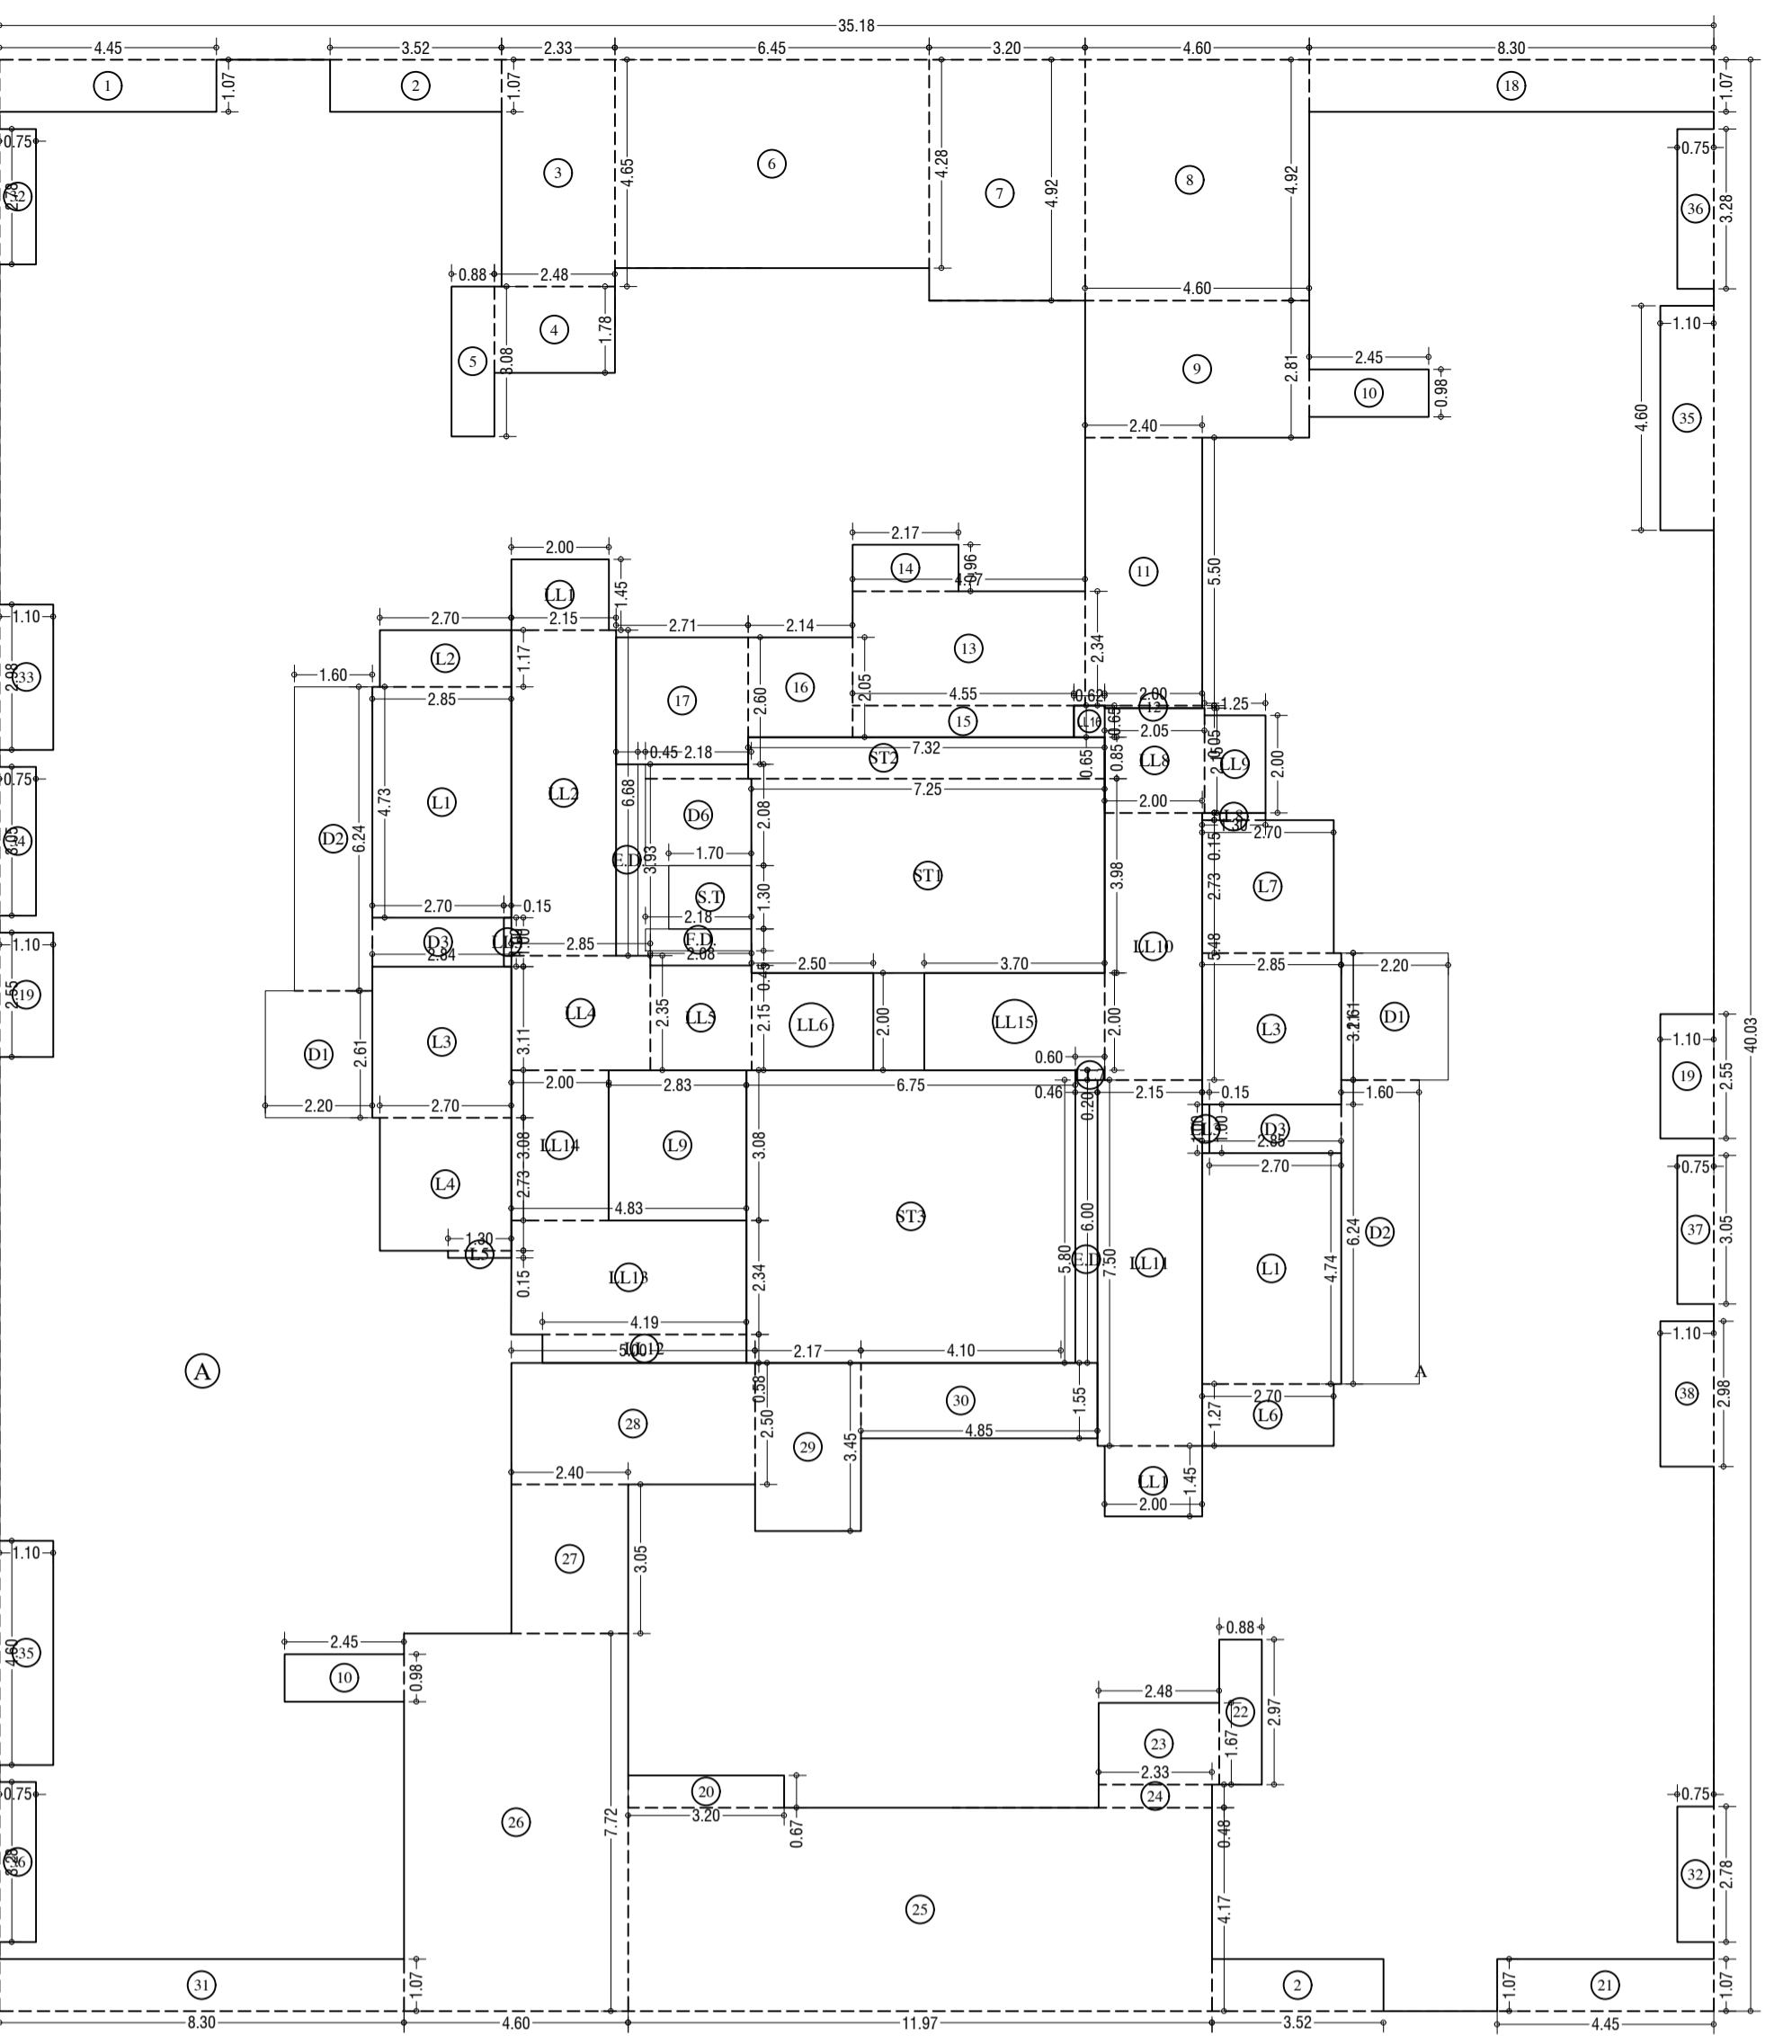


LINE AREA DIAGRAM FOR 12th to 16th & 19th to 23rd TYPICAL FLOOR. (WING=T-4 & T5)
SCALE: 1:100

Table with multiple columns for room descriptions, dimensions, and area calculations. Includes sub-sections for 'MULTI-FLOOR AREA CALCULATION', 'LIFT AREA CALCULATION', 'STAIRCASE AREA CALCULATION', 'LIFT LOBBY AREA CALCULATION', 'SERVANT TOILET AREA CALCULATION', 'DUCT AREA CALCULATION', 'NET FLOOR AREA', and 'TOTAL FLOOR AREA'.

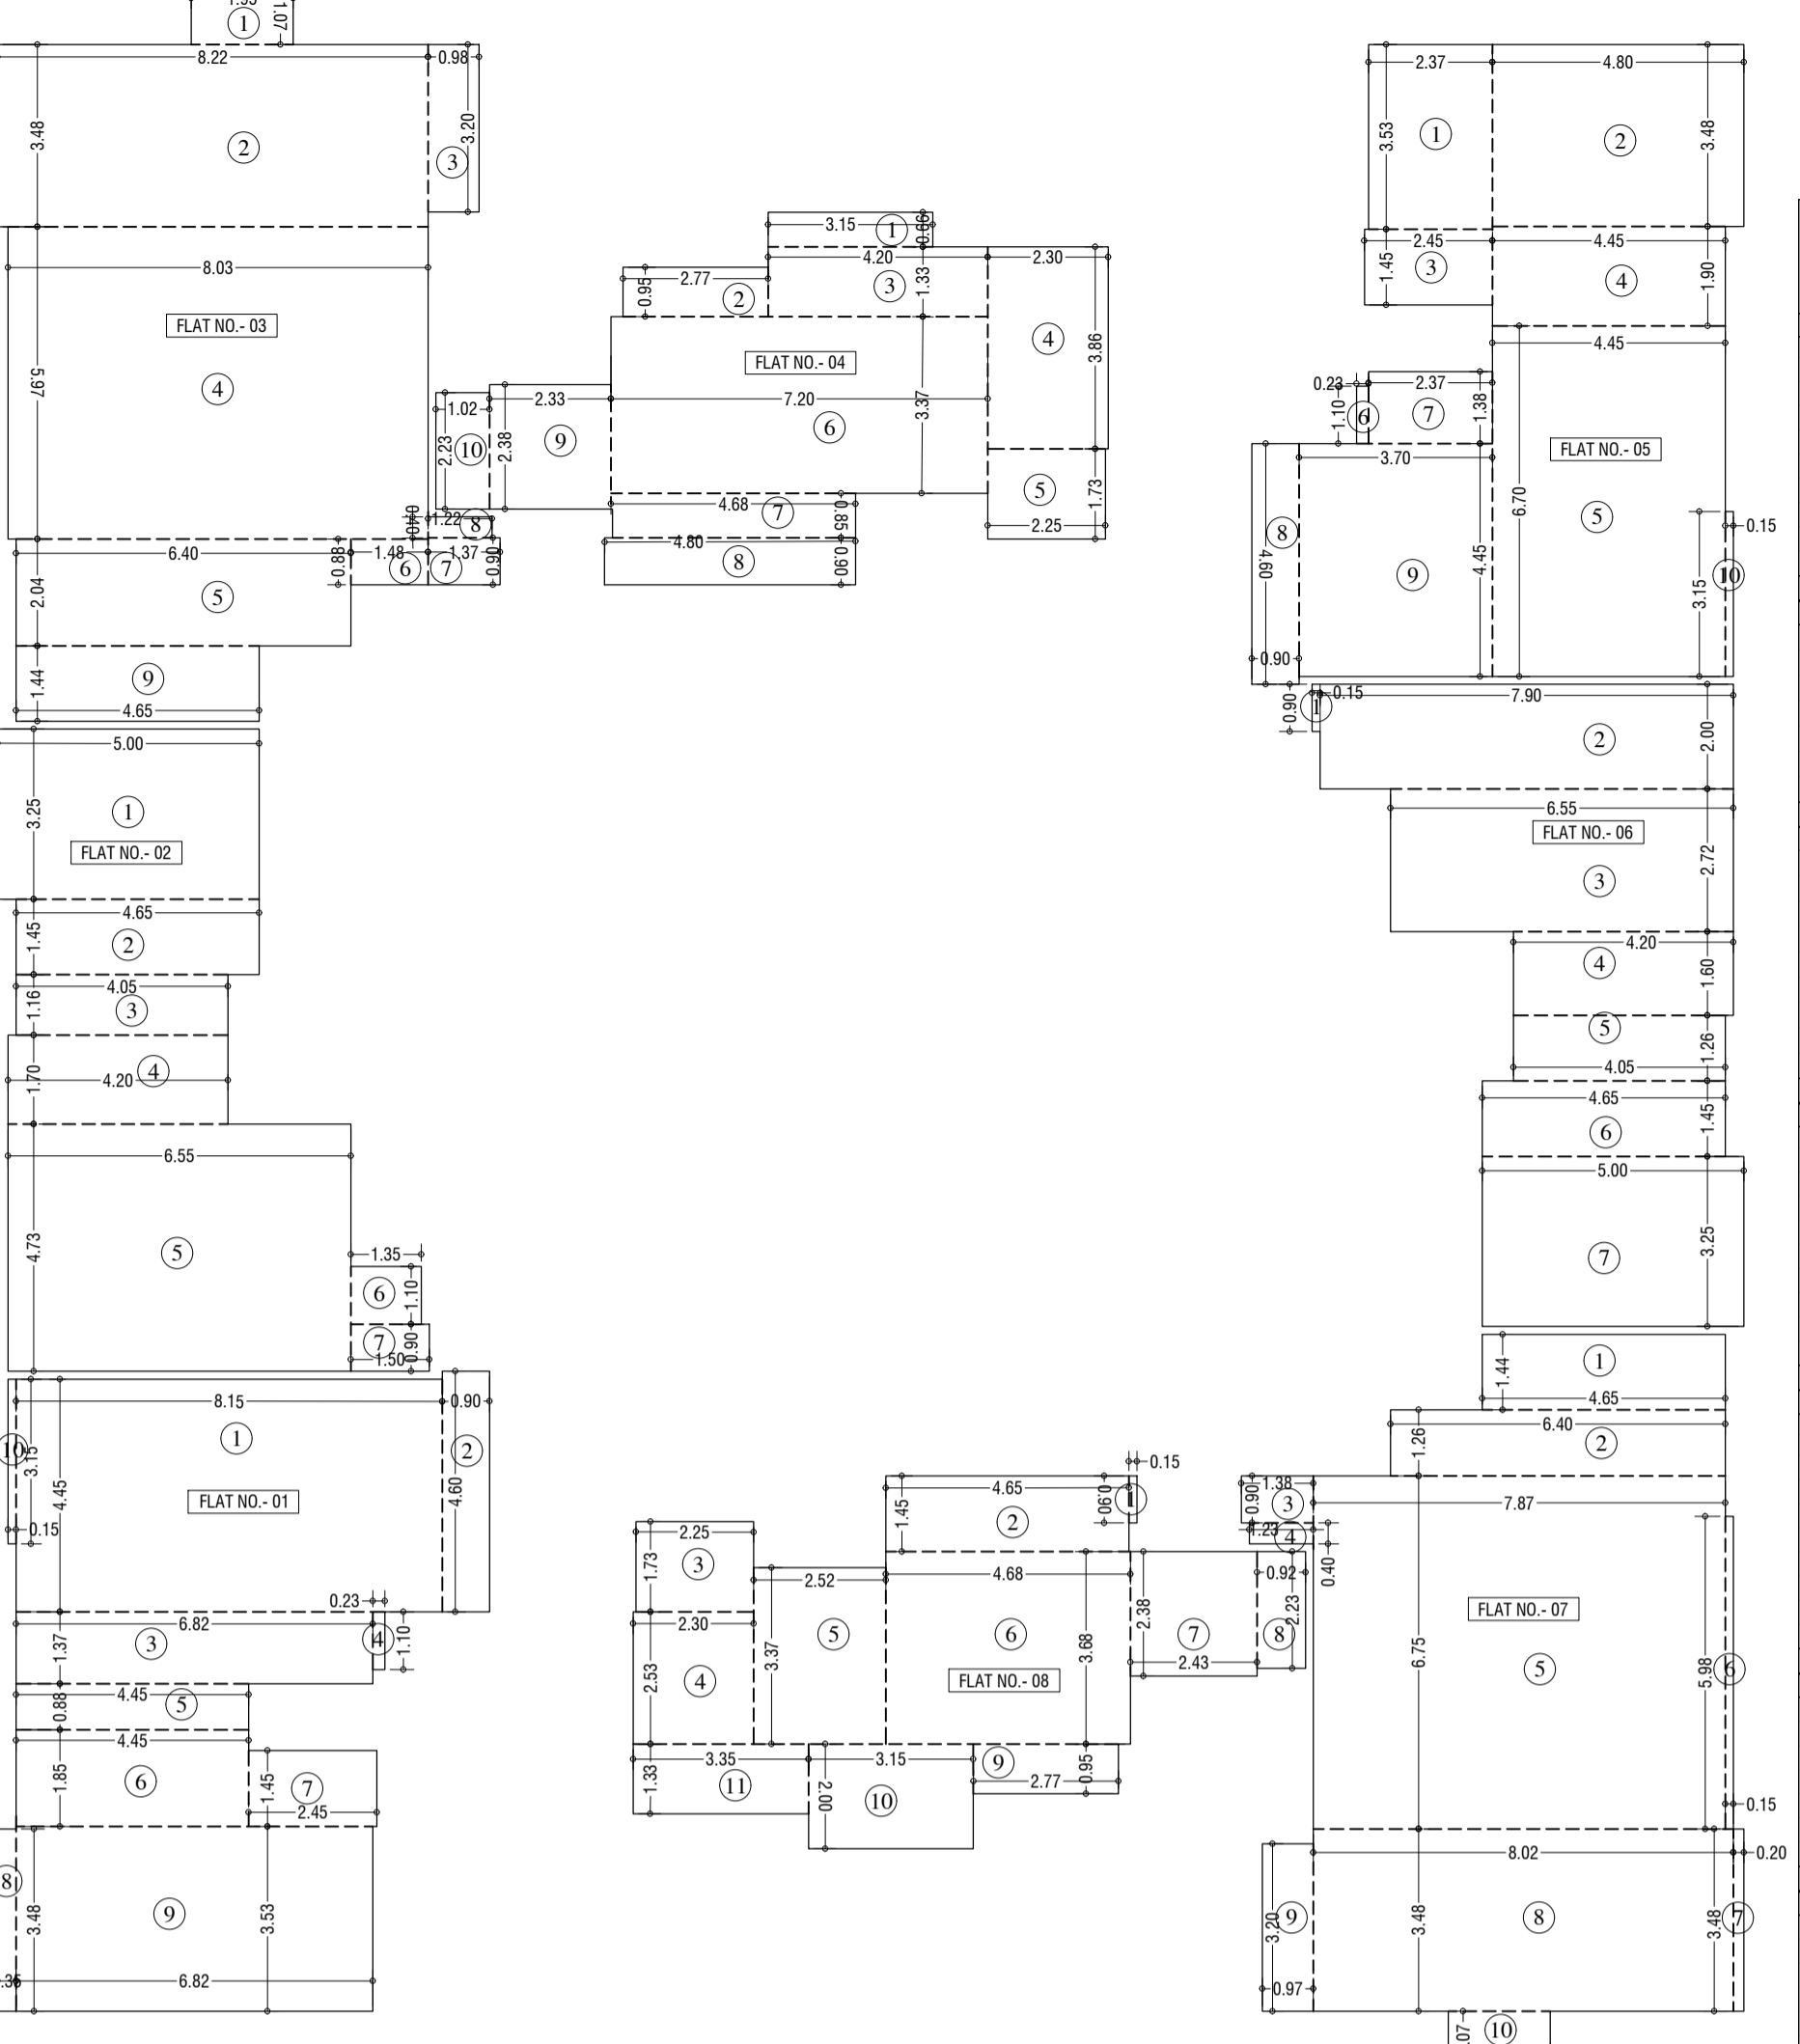


CARPET LINE AREA DIA. FOR PARKING PURPOSE
12th to 16th & 19th to 23rd TYPICAL FLOOR. (WING=T-4)
SCALE: 1:100

Table with multiple columns for flat numbers (FLAT NO. 01 to 11) and their corresponding area calculations. Includes sub-sections for 'CARPET AREA FOR PARKING PURPOSE' and 'TOTAL' for each flat.

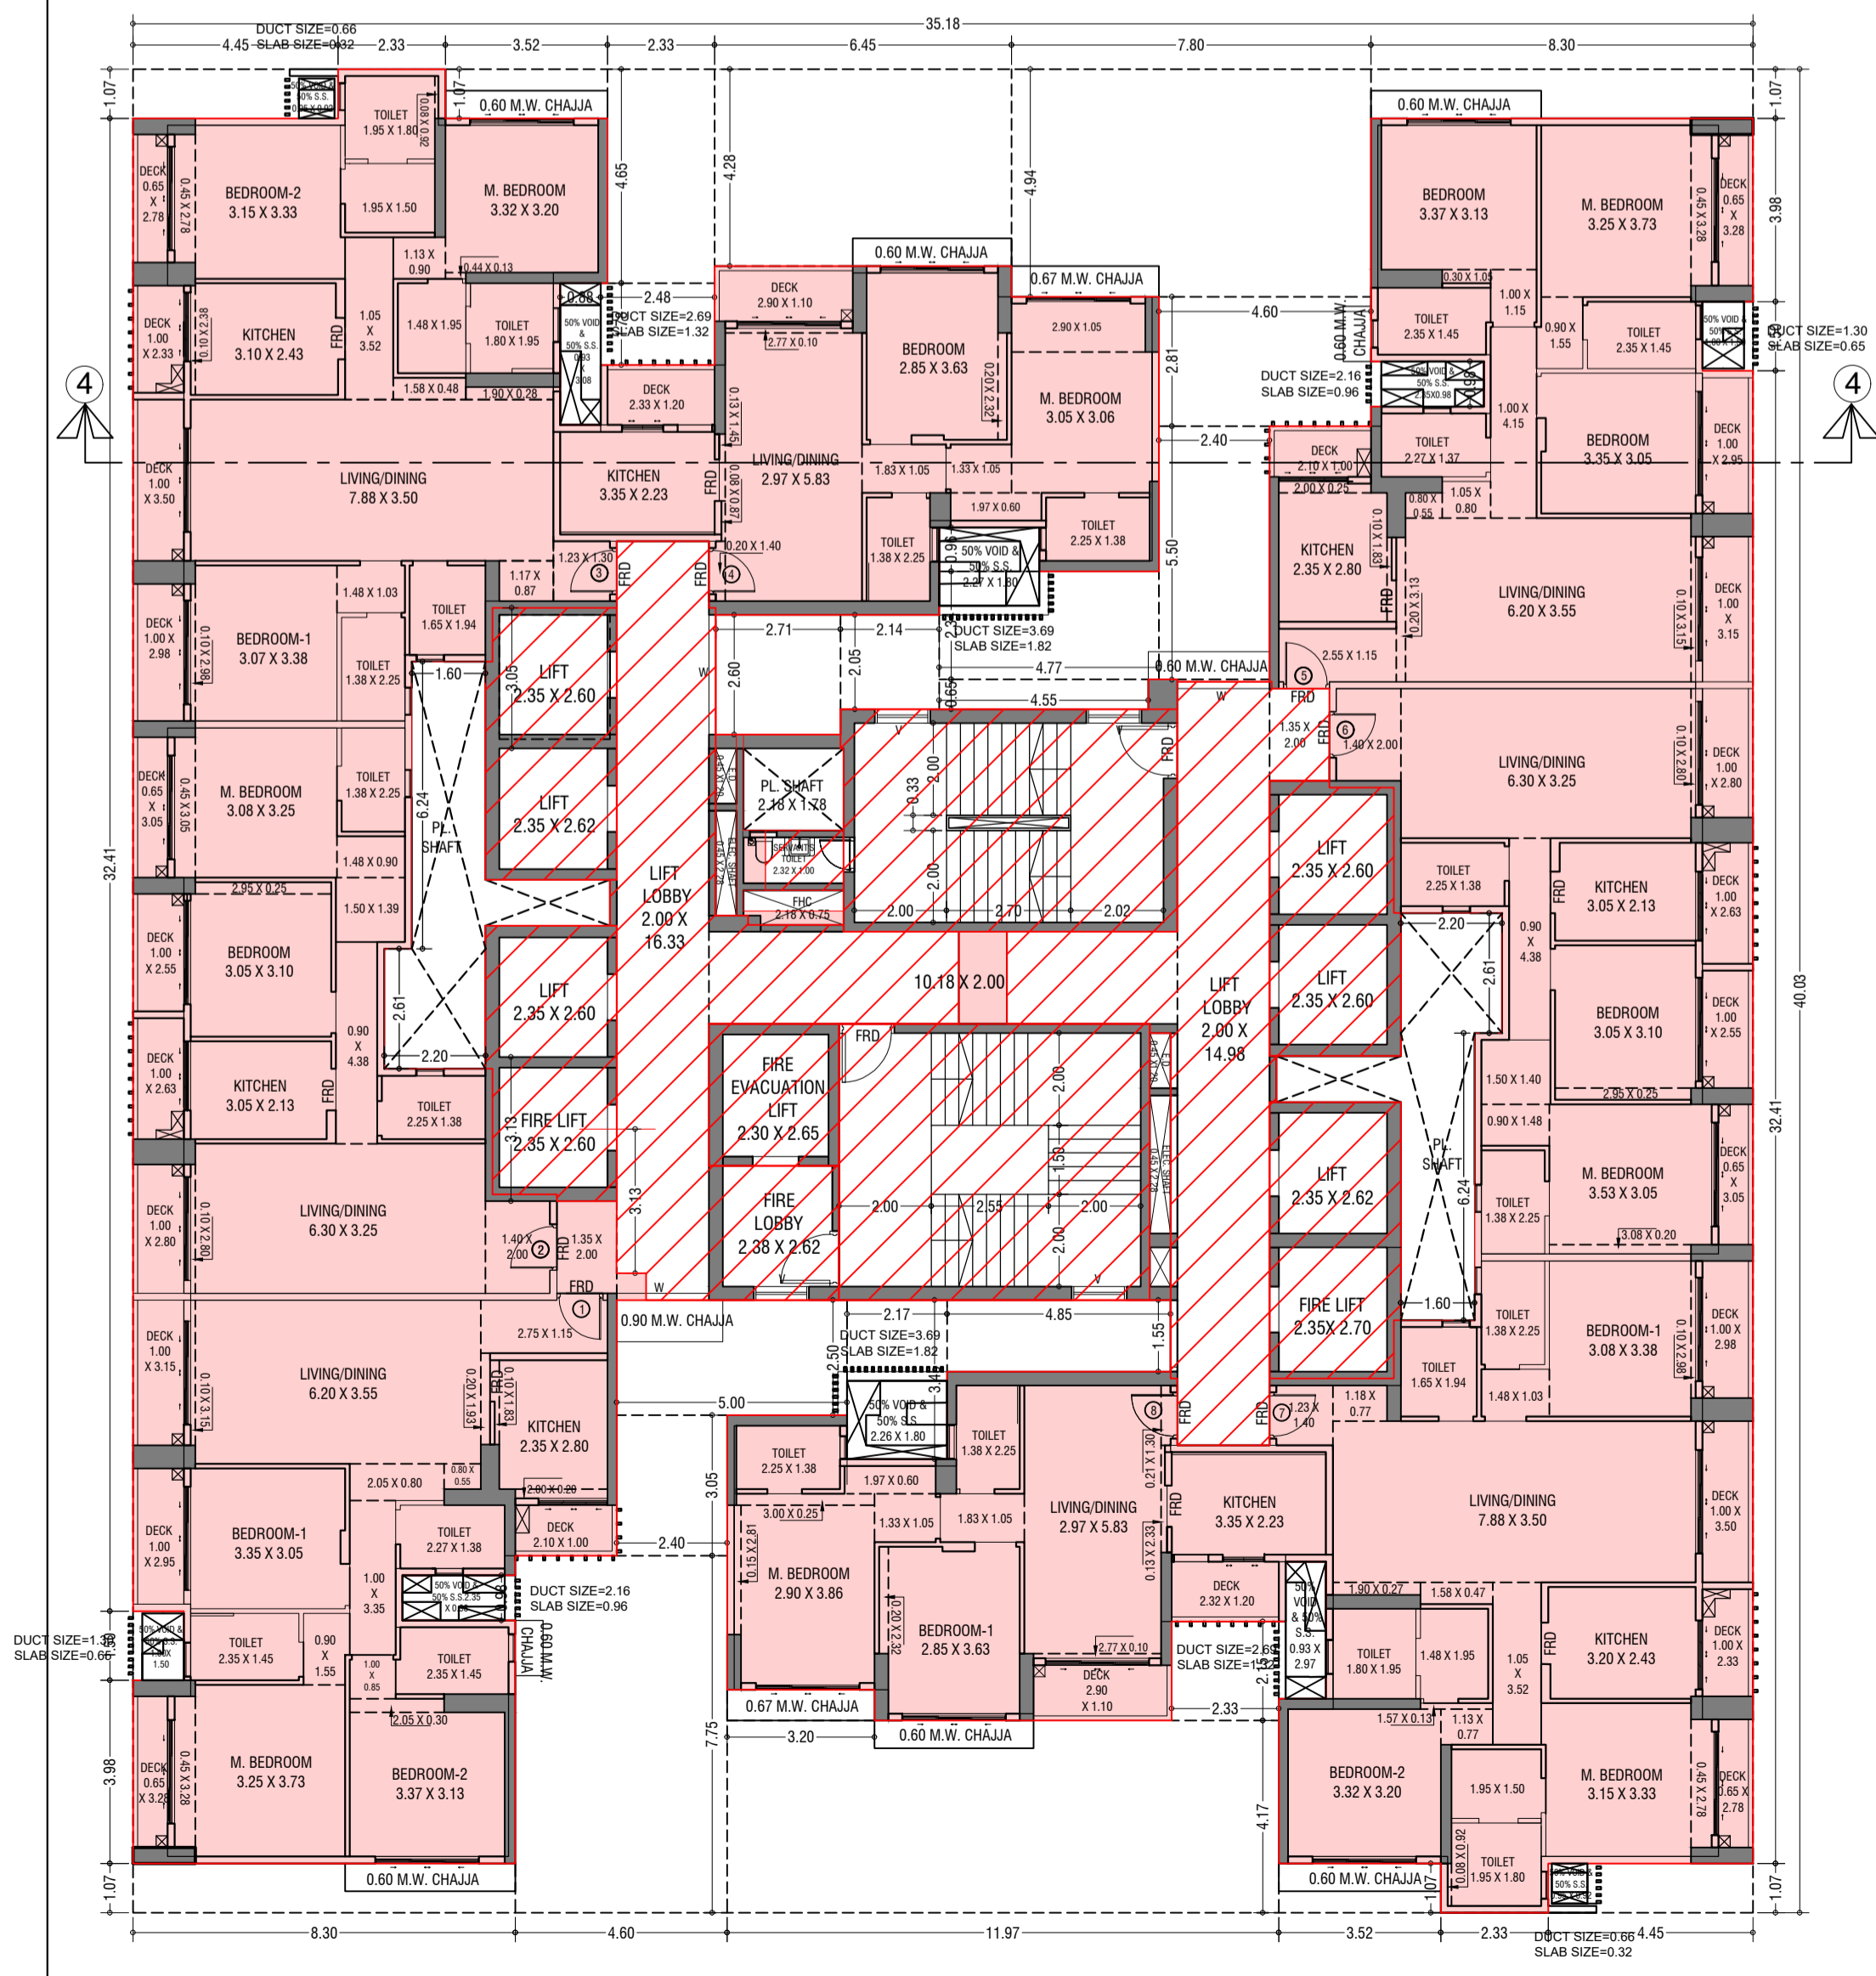


11th, 18th & 25th FLOOR PLAN (WING=T-4)
SCALE: 1:100

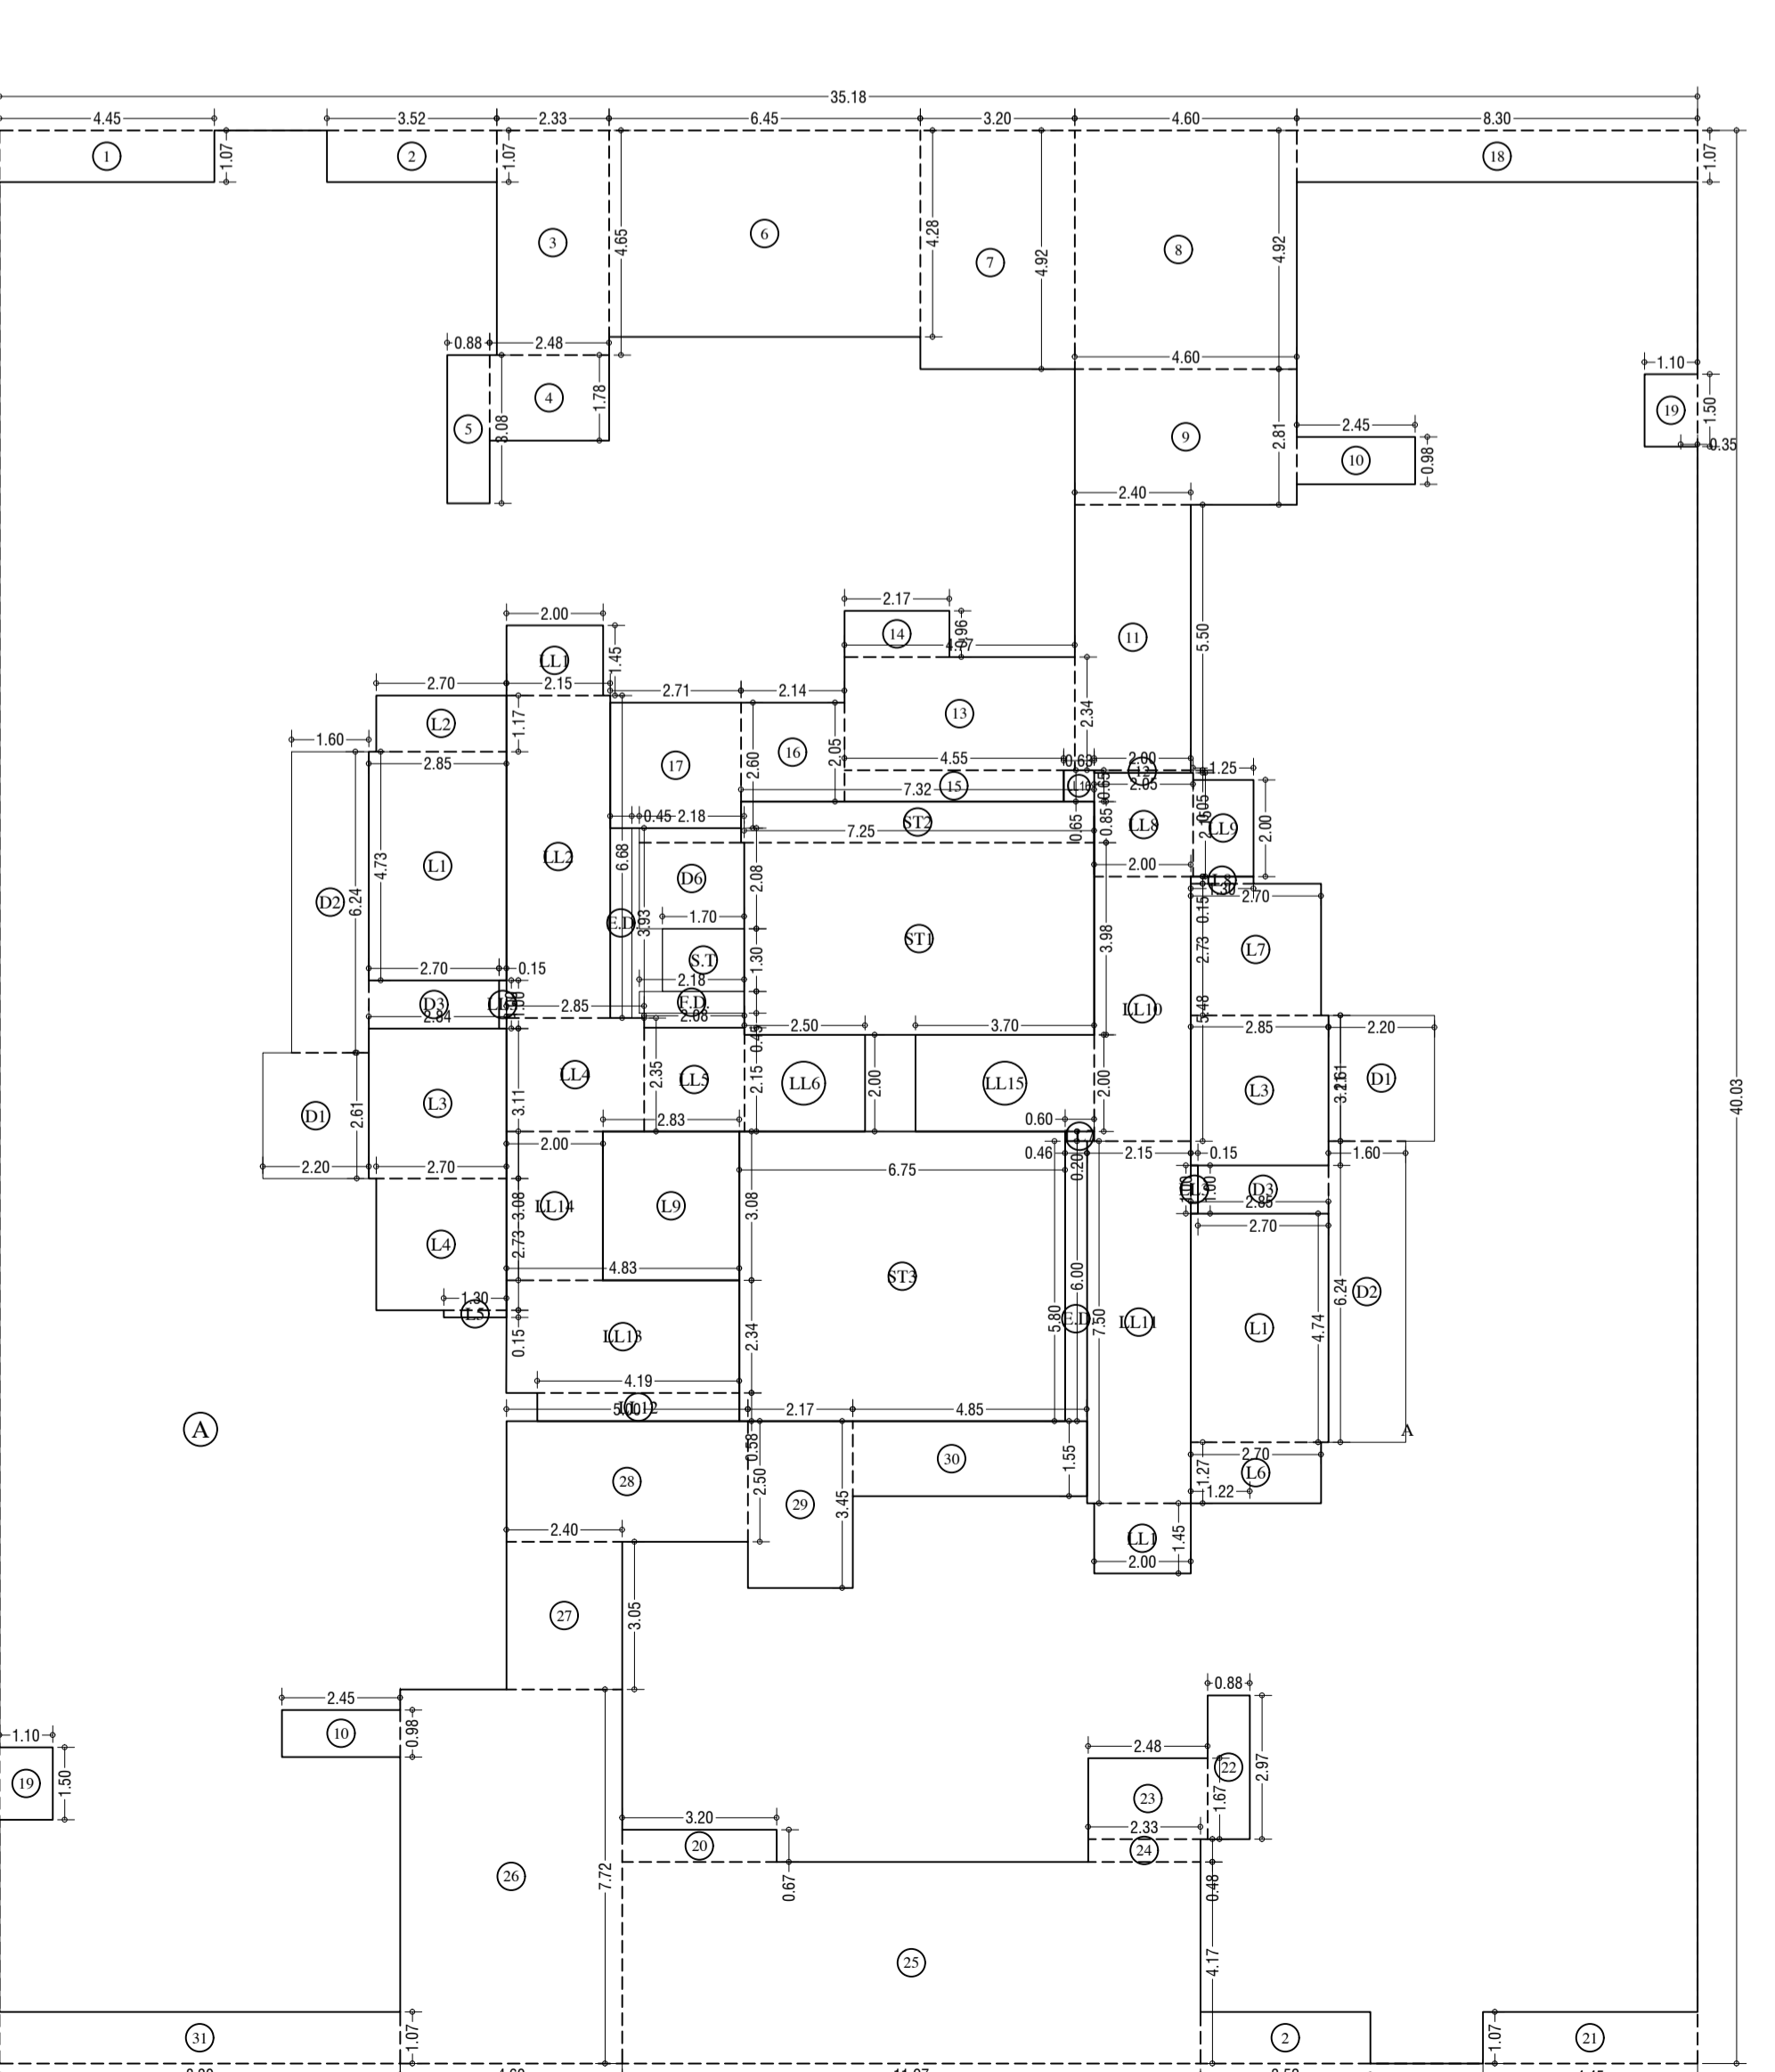

LINE AREA DIAGRAM FOR 11th, 18th & 25th FLOOR. (WING=T-4)
SCALE: 1:100


Table with multiple columns for room descriptions, dimensions, and area calculations. Includes sub-sections for 'MULTI-FLOOR AREA CALCULATION', 'LIFT AREA CALCULATION', 'STAIRCASE AREA CALCULATION', 'LIFT LOBBY AREA CALCULATION', 'SERVANT TOILET AREA CALCULATION', 'DUCT AREA CALCULATION', 'NET FLOOR AREA', and 'TOTAL FLOOR AREA'.

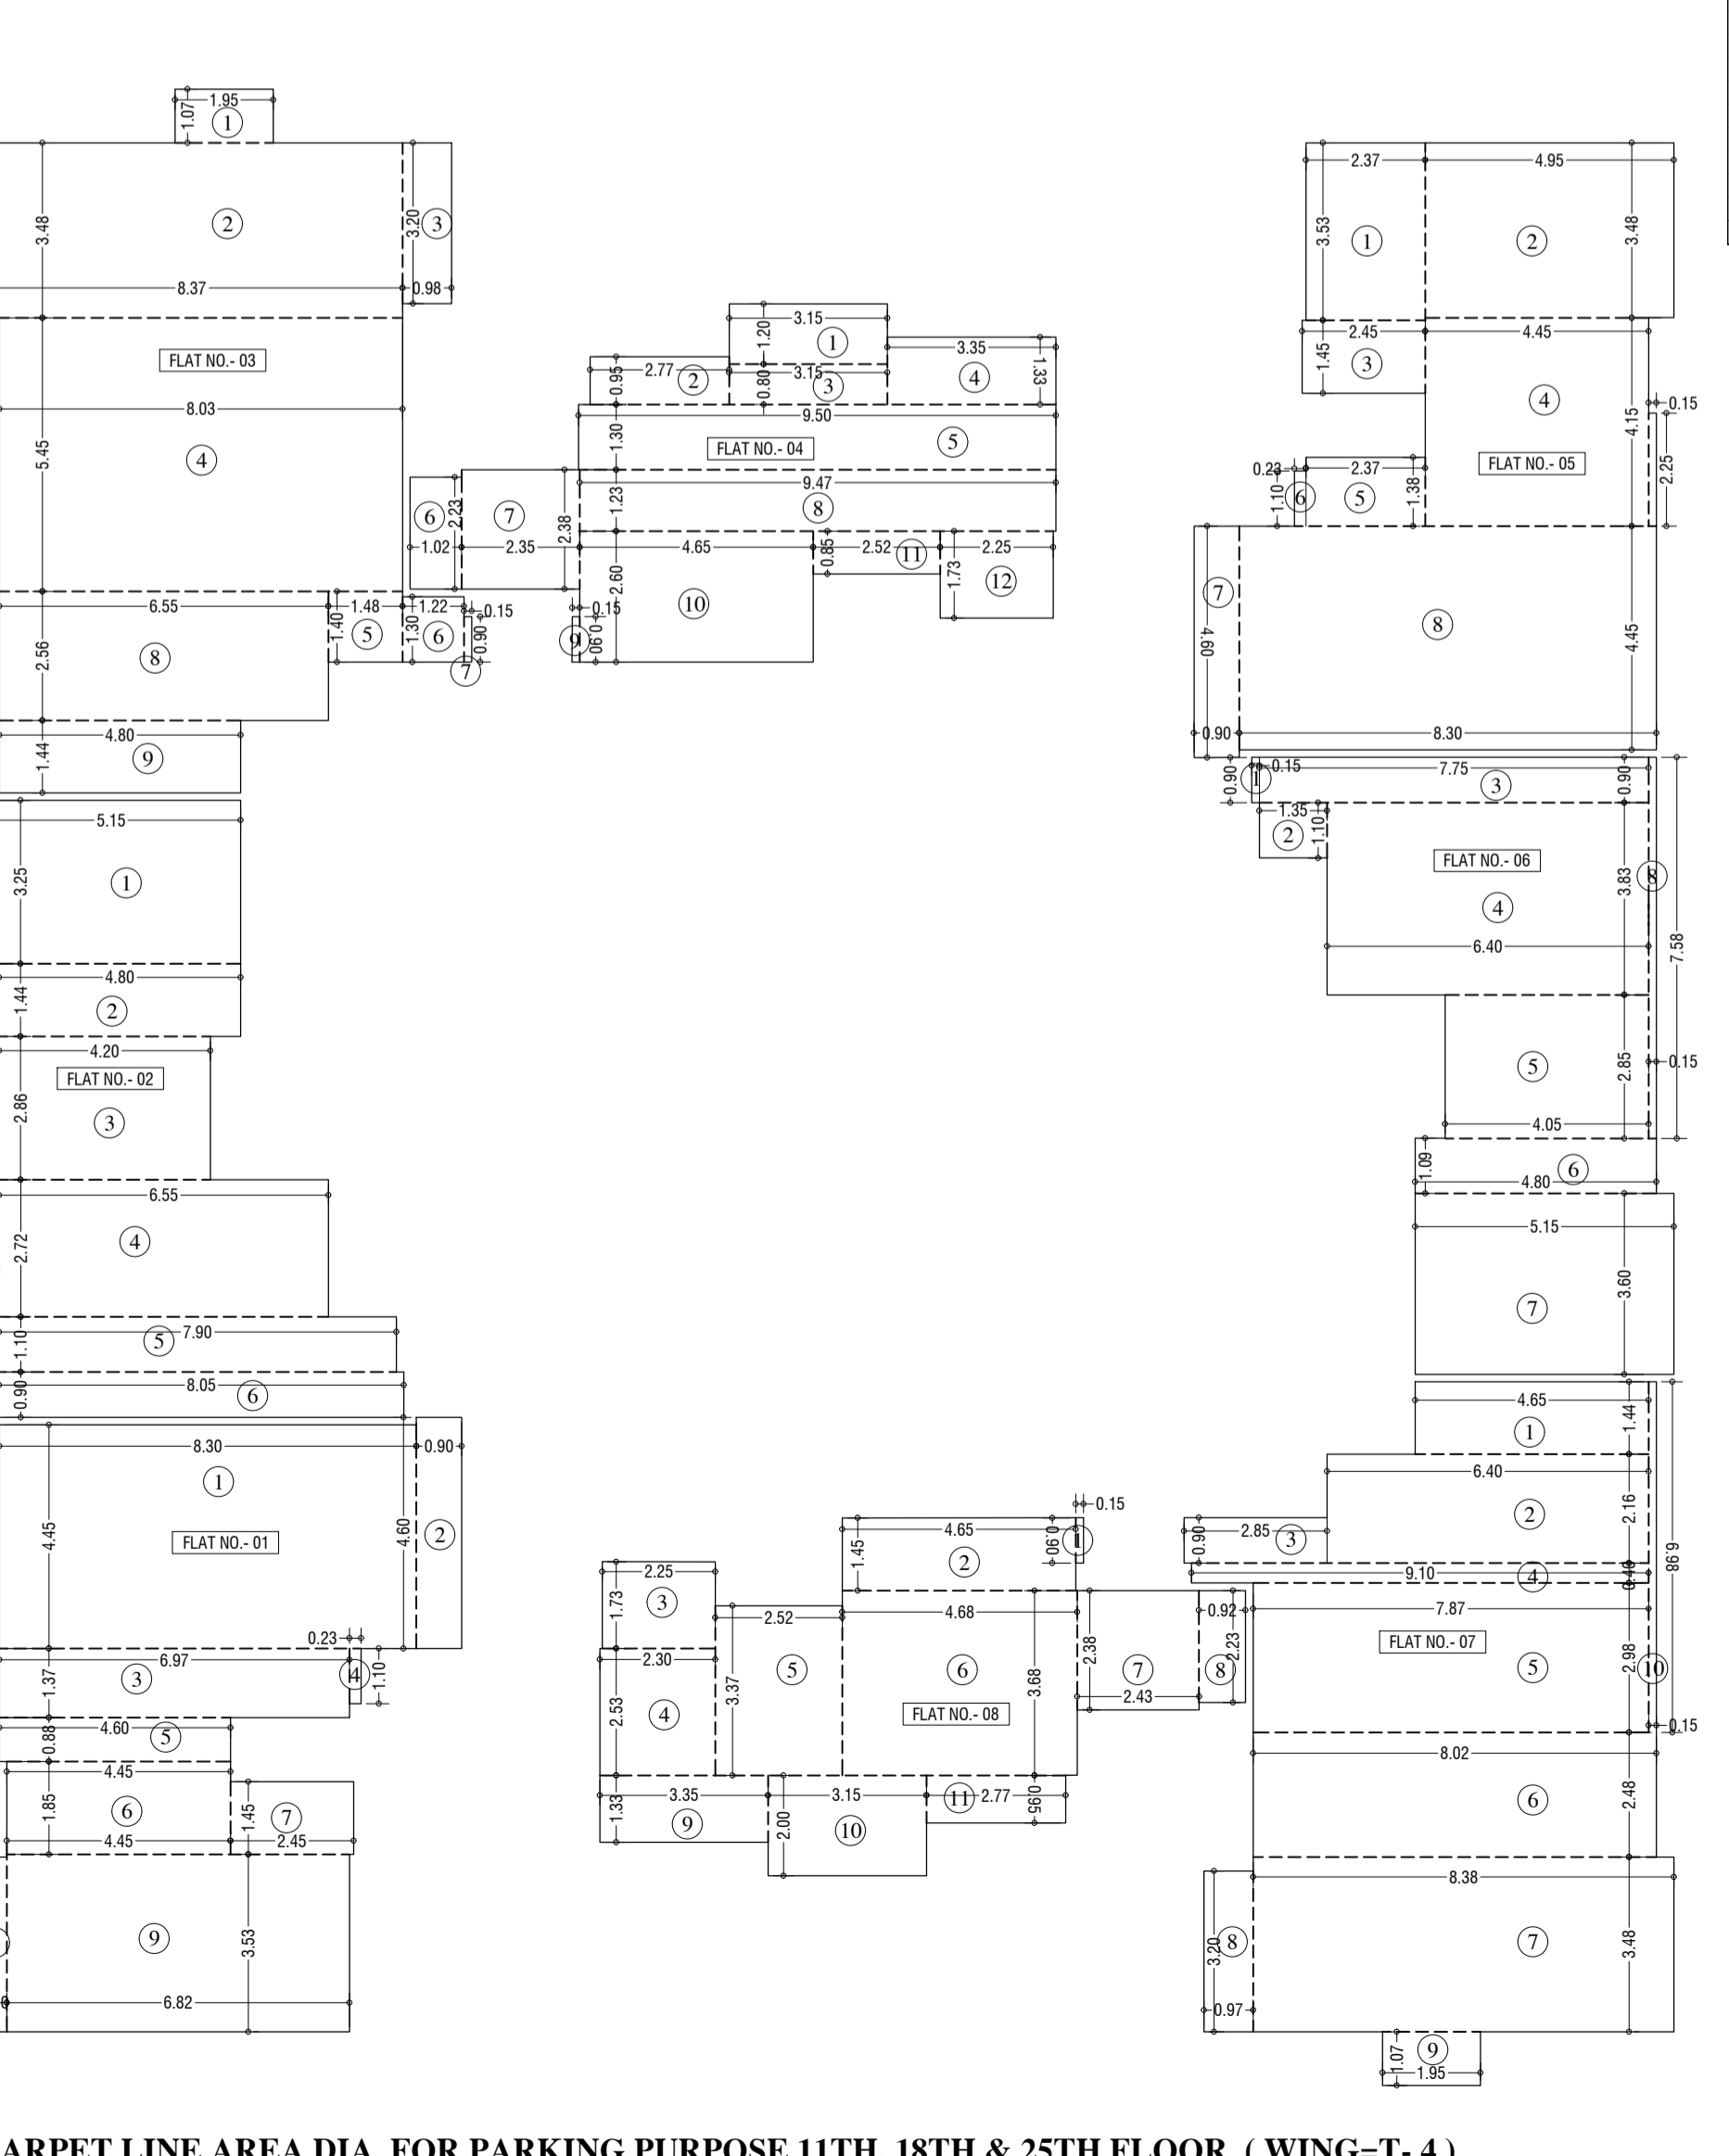


CARPET LINE AREA DIA. FOR PARKING PURPOSE 11th, 18th & 25th FLOOR. (WING=T-4)
SCALE: 1:100

Stamp and date of approval of plan. Includes 'APPROVED SUBJECT TO THE CONDITIONS MENTIONED IN THIS OFFICE LETTER NO.P-12131/2022/611 And Other's Ward/Kanjur-W'. Below the stamp is a table with columns for 'S.E.(B.P.) SW', 'A.E.(B.P.) S & T', and 'EX. ENG.(B.P.)SE-II'. It also contains a 'PROPOSAL OF PROPOSAL & PROPERTY' section, a 'REVISIONS' table, and a 'NAME AND ADDRESS OF DESIGN ARCHITECT' section.


PROFORMA -B
CONTENTS OF SHEET
26th to 29th TYPICAL FLOOR PLAN, LINE AREA DIAGRAM, AREA CALCULATION, TERRACE FLOOR PLAN & OHT PLAN. (WING=T-4)

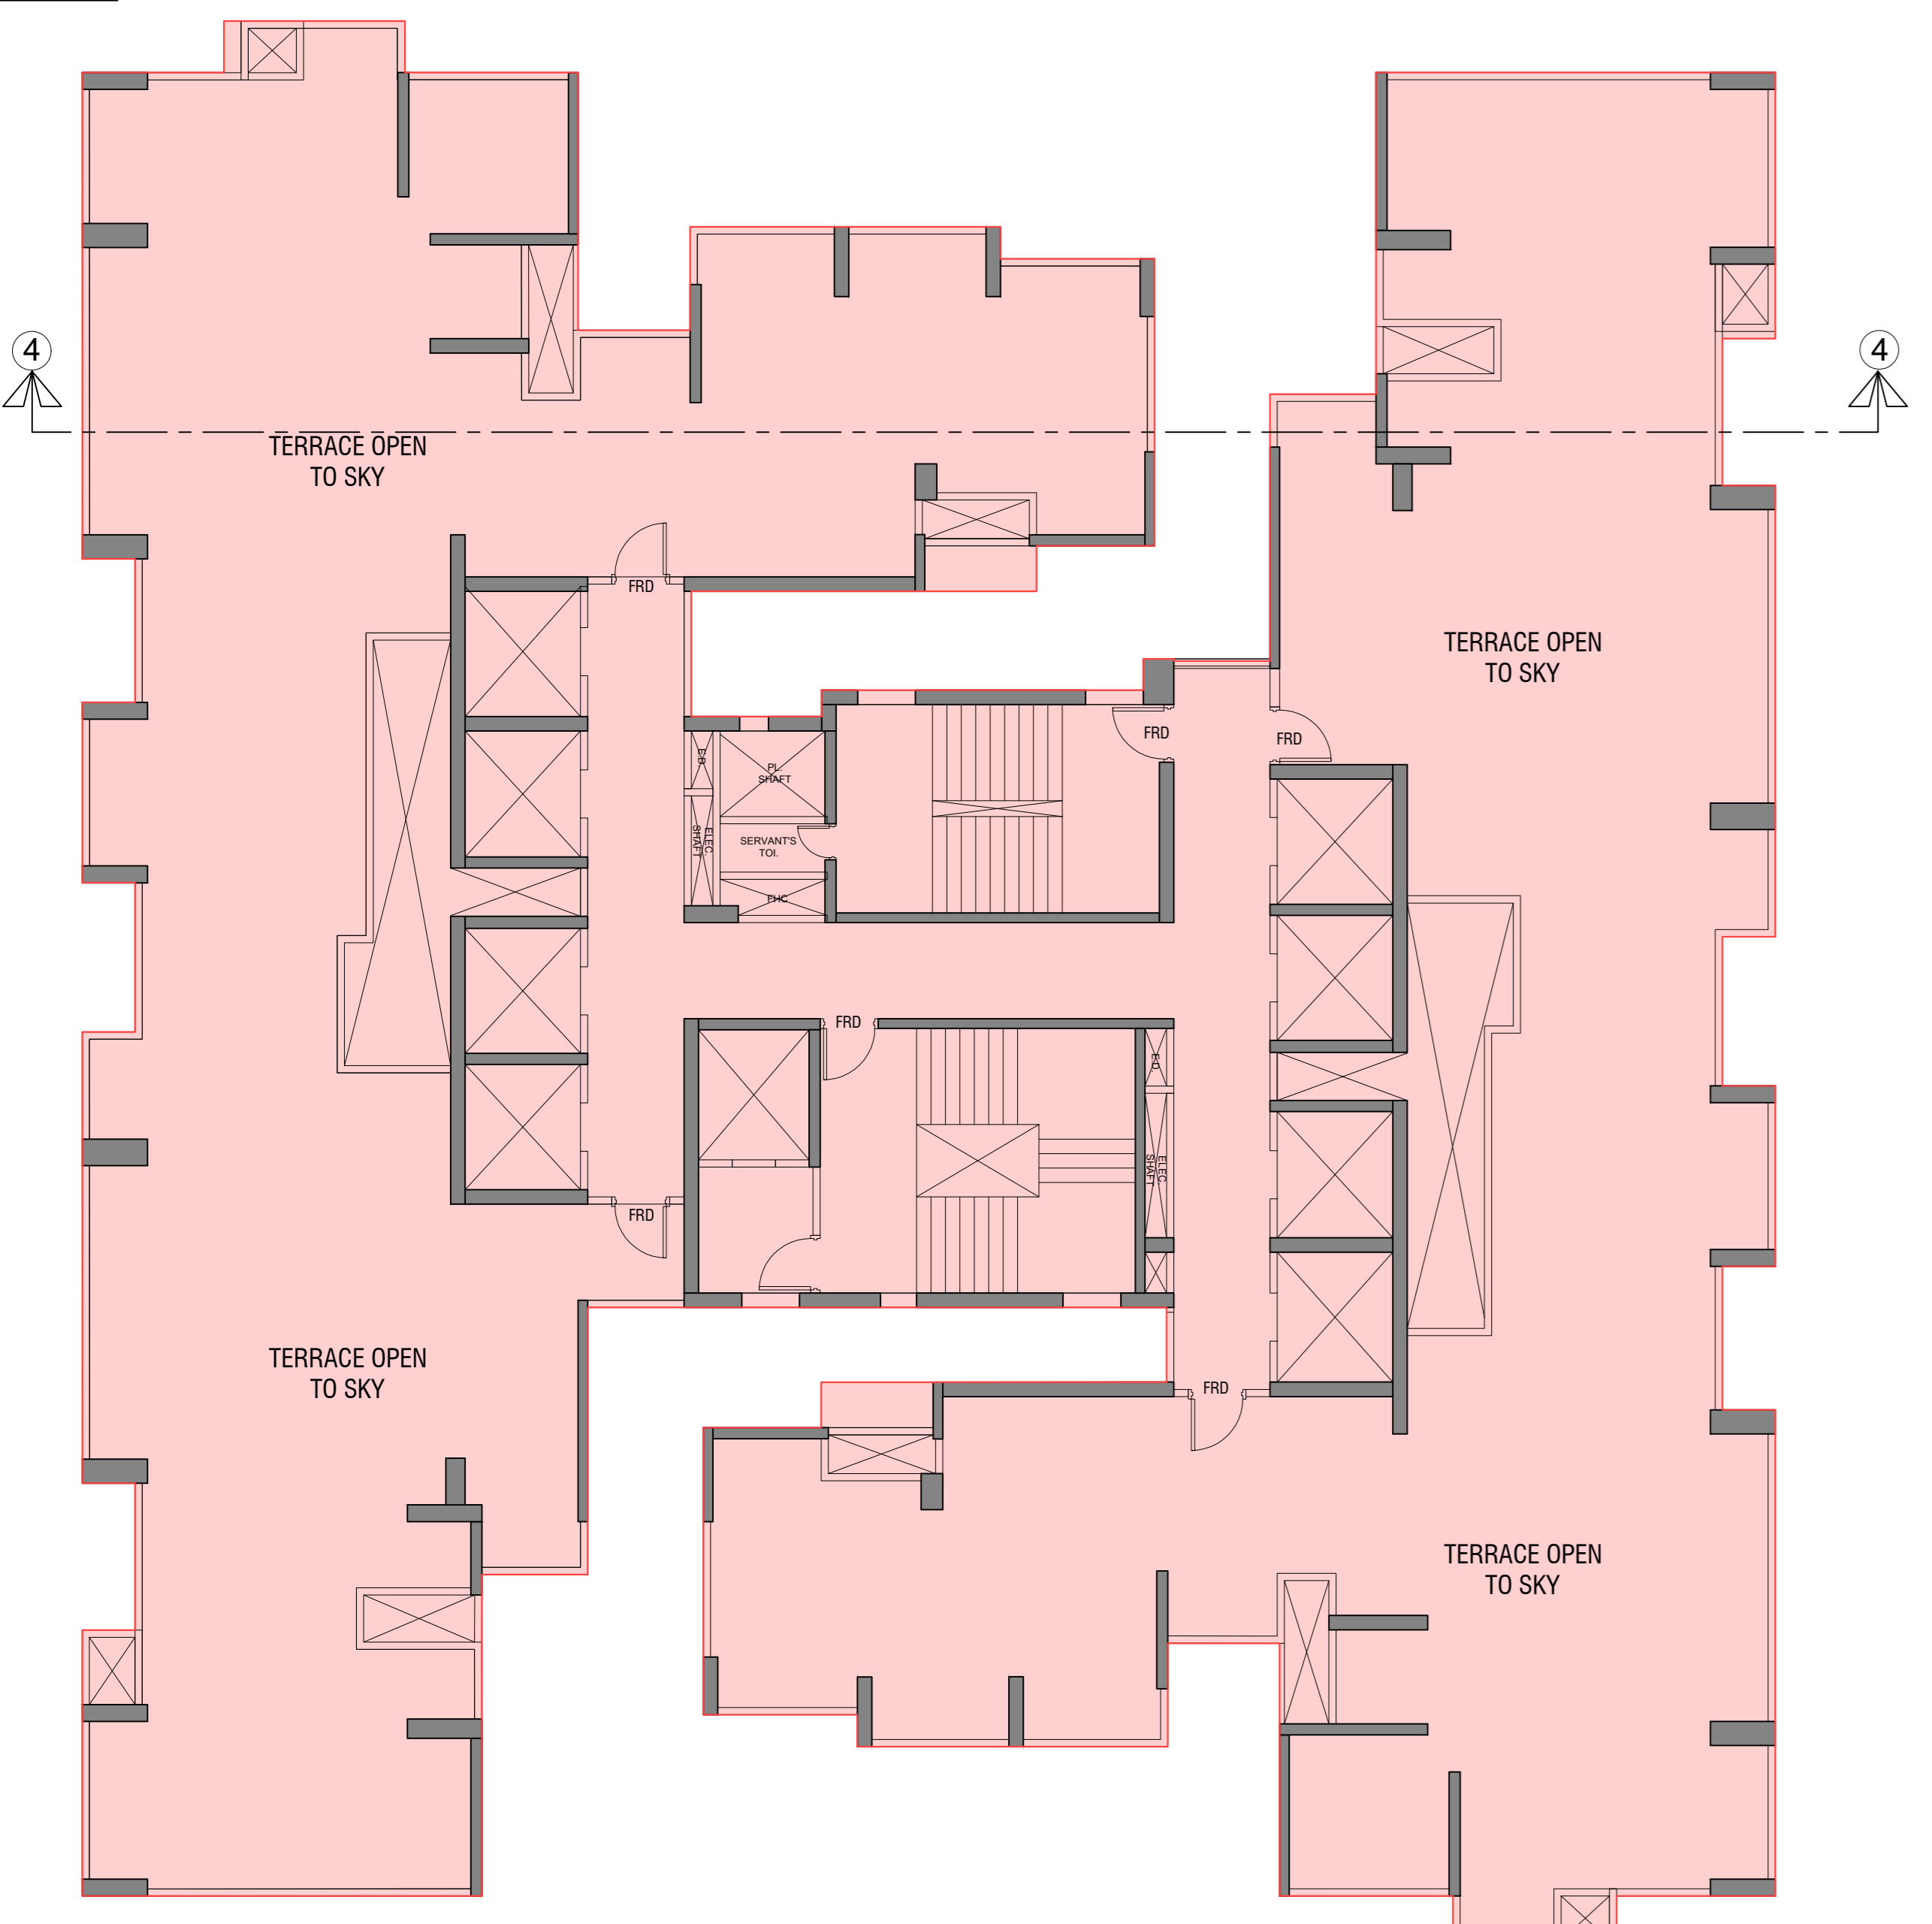

TERRACE FLOOR PLAN (WING=T-4)
SCALE: 1:100

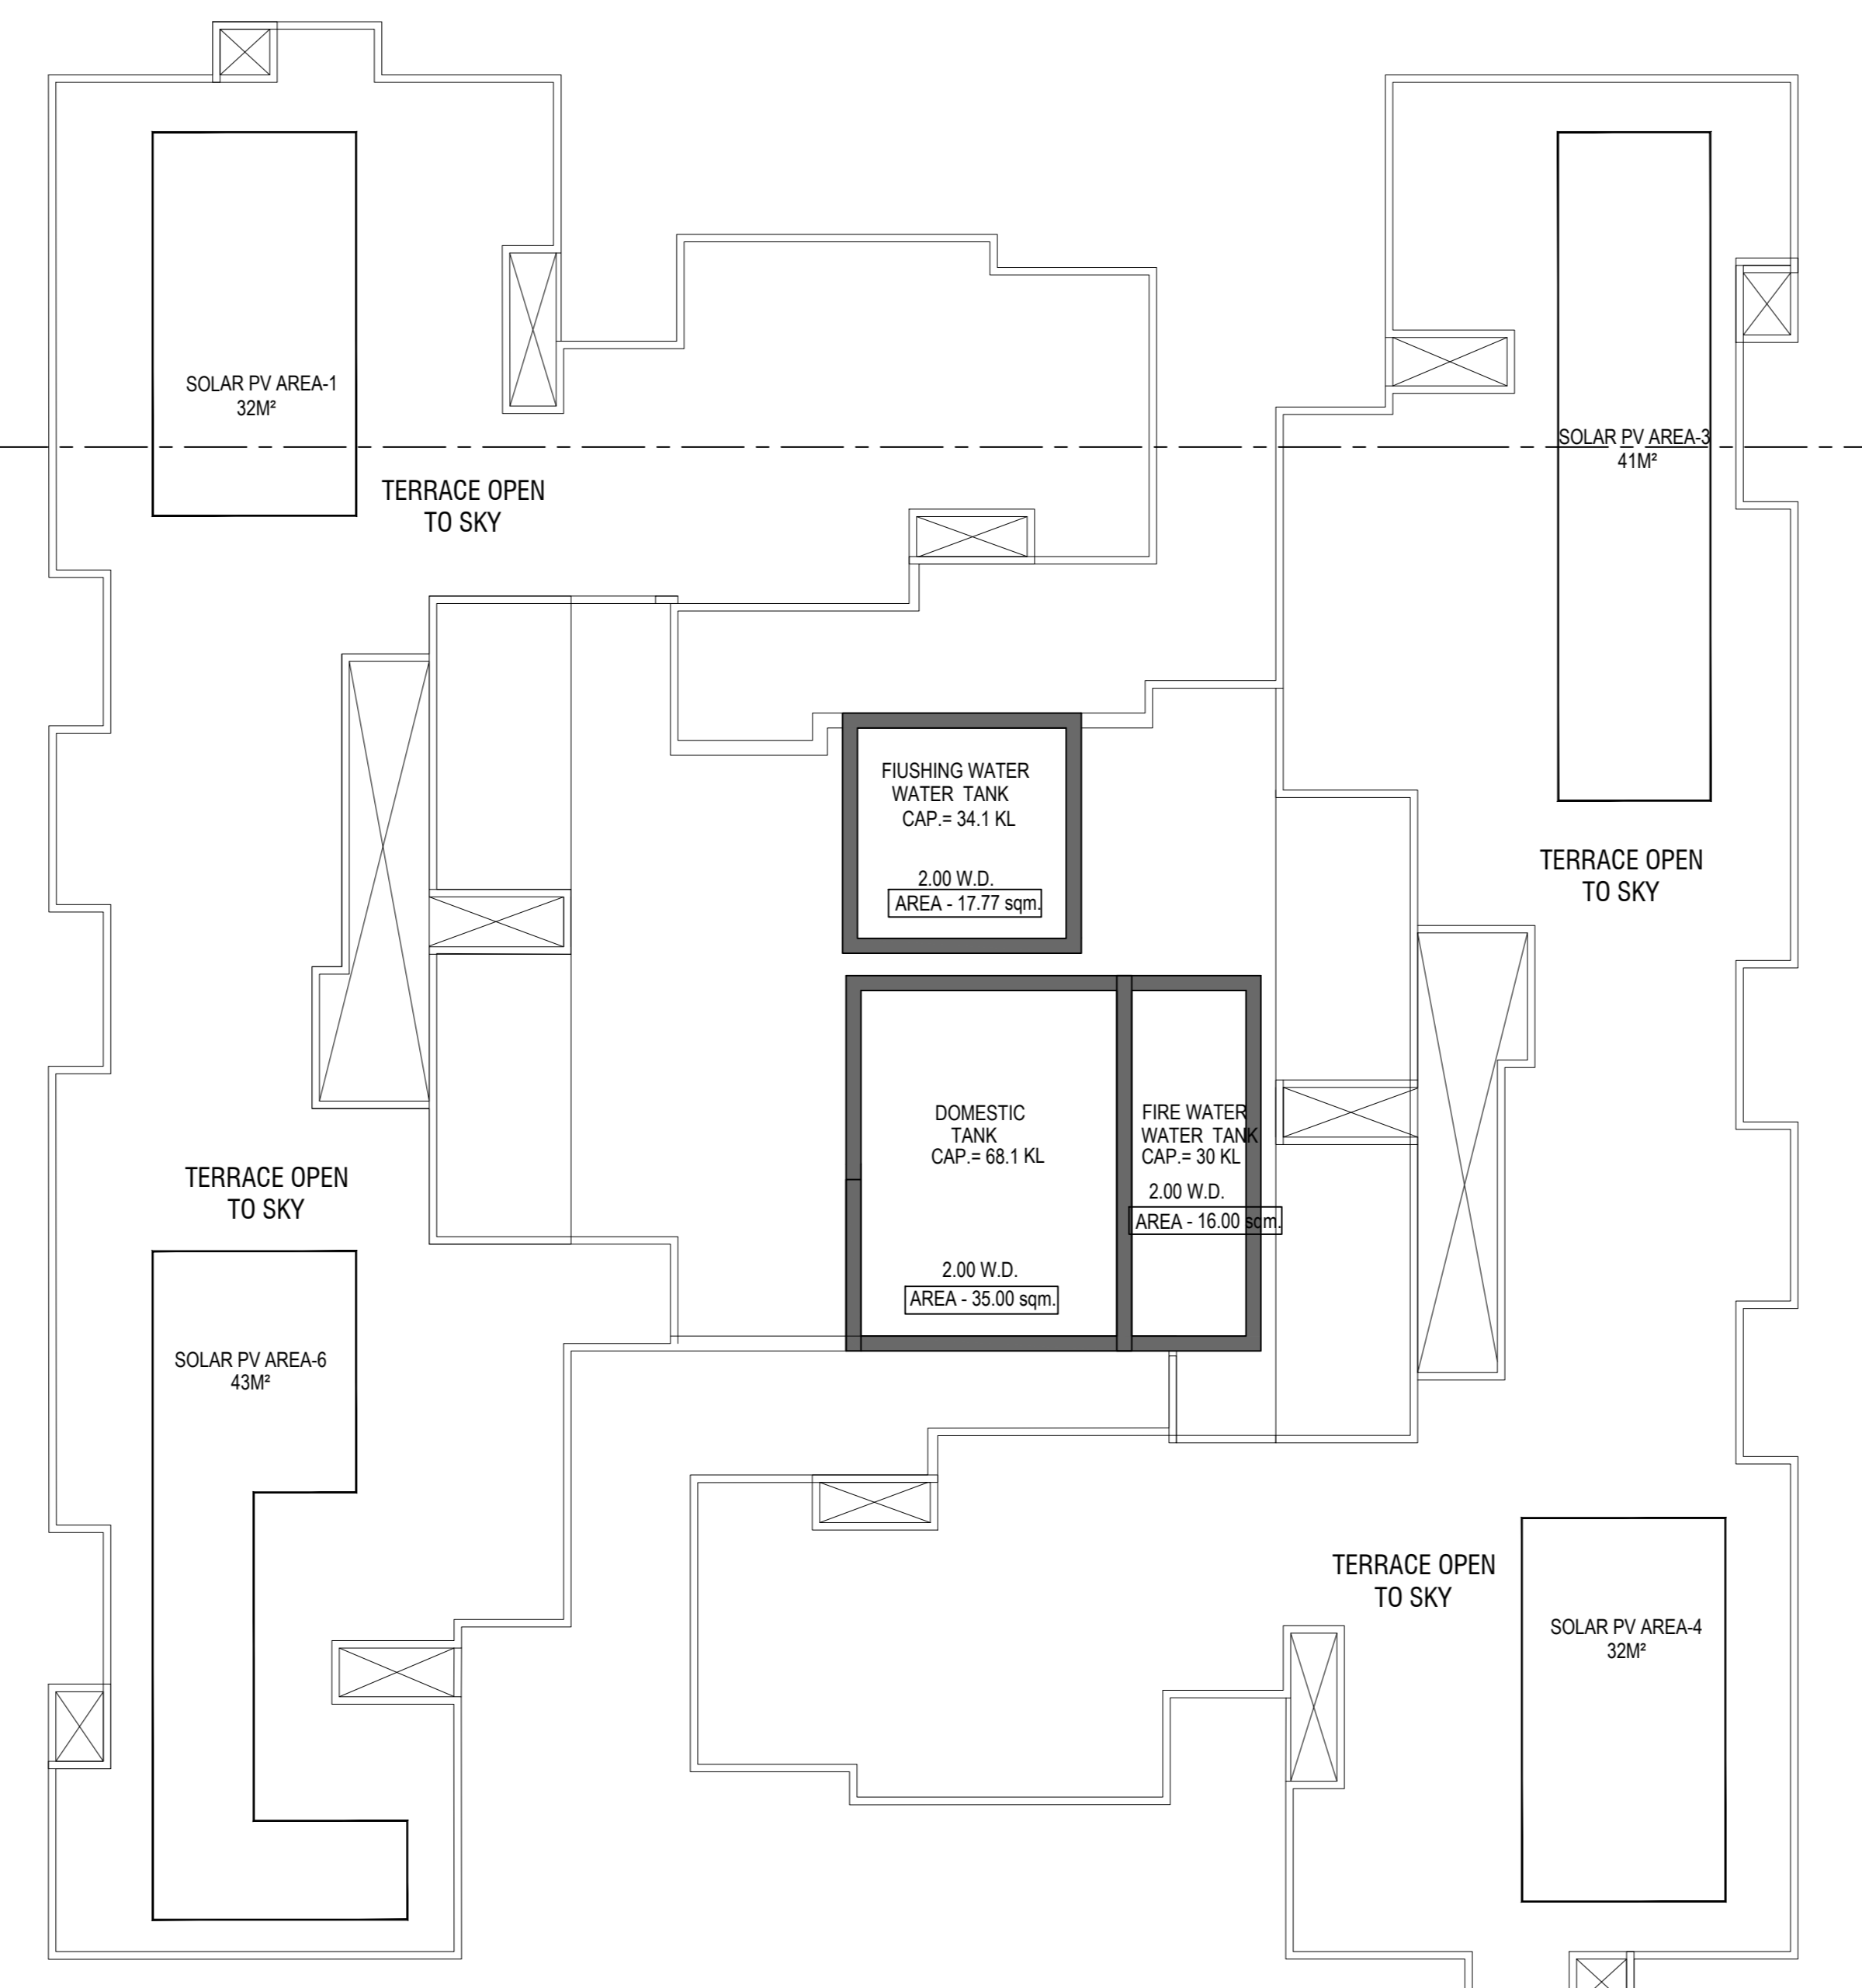

OHT PLAN (WING=T-4)
SCALE: 1:100

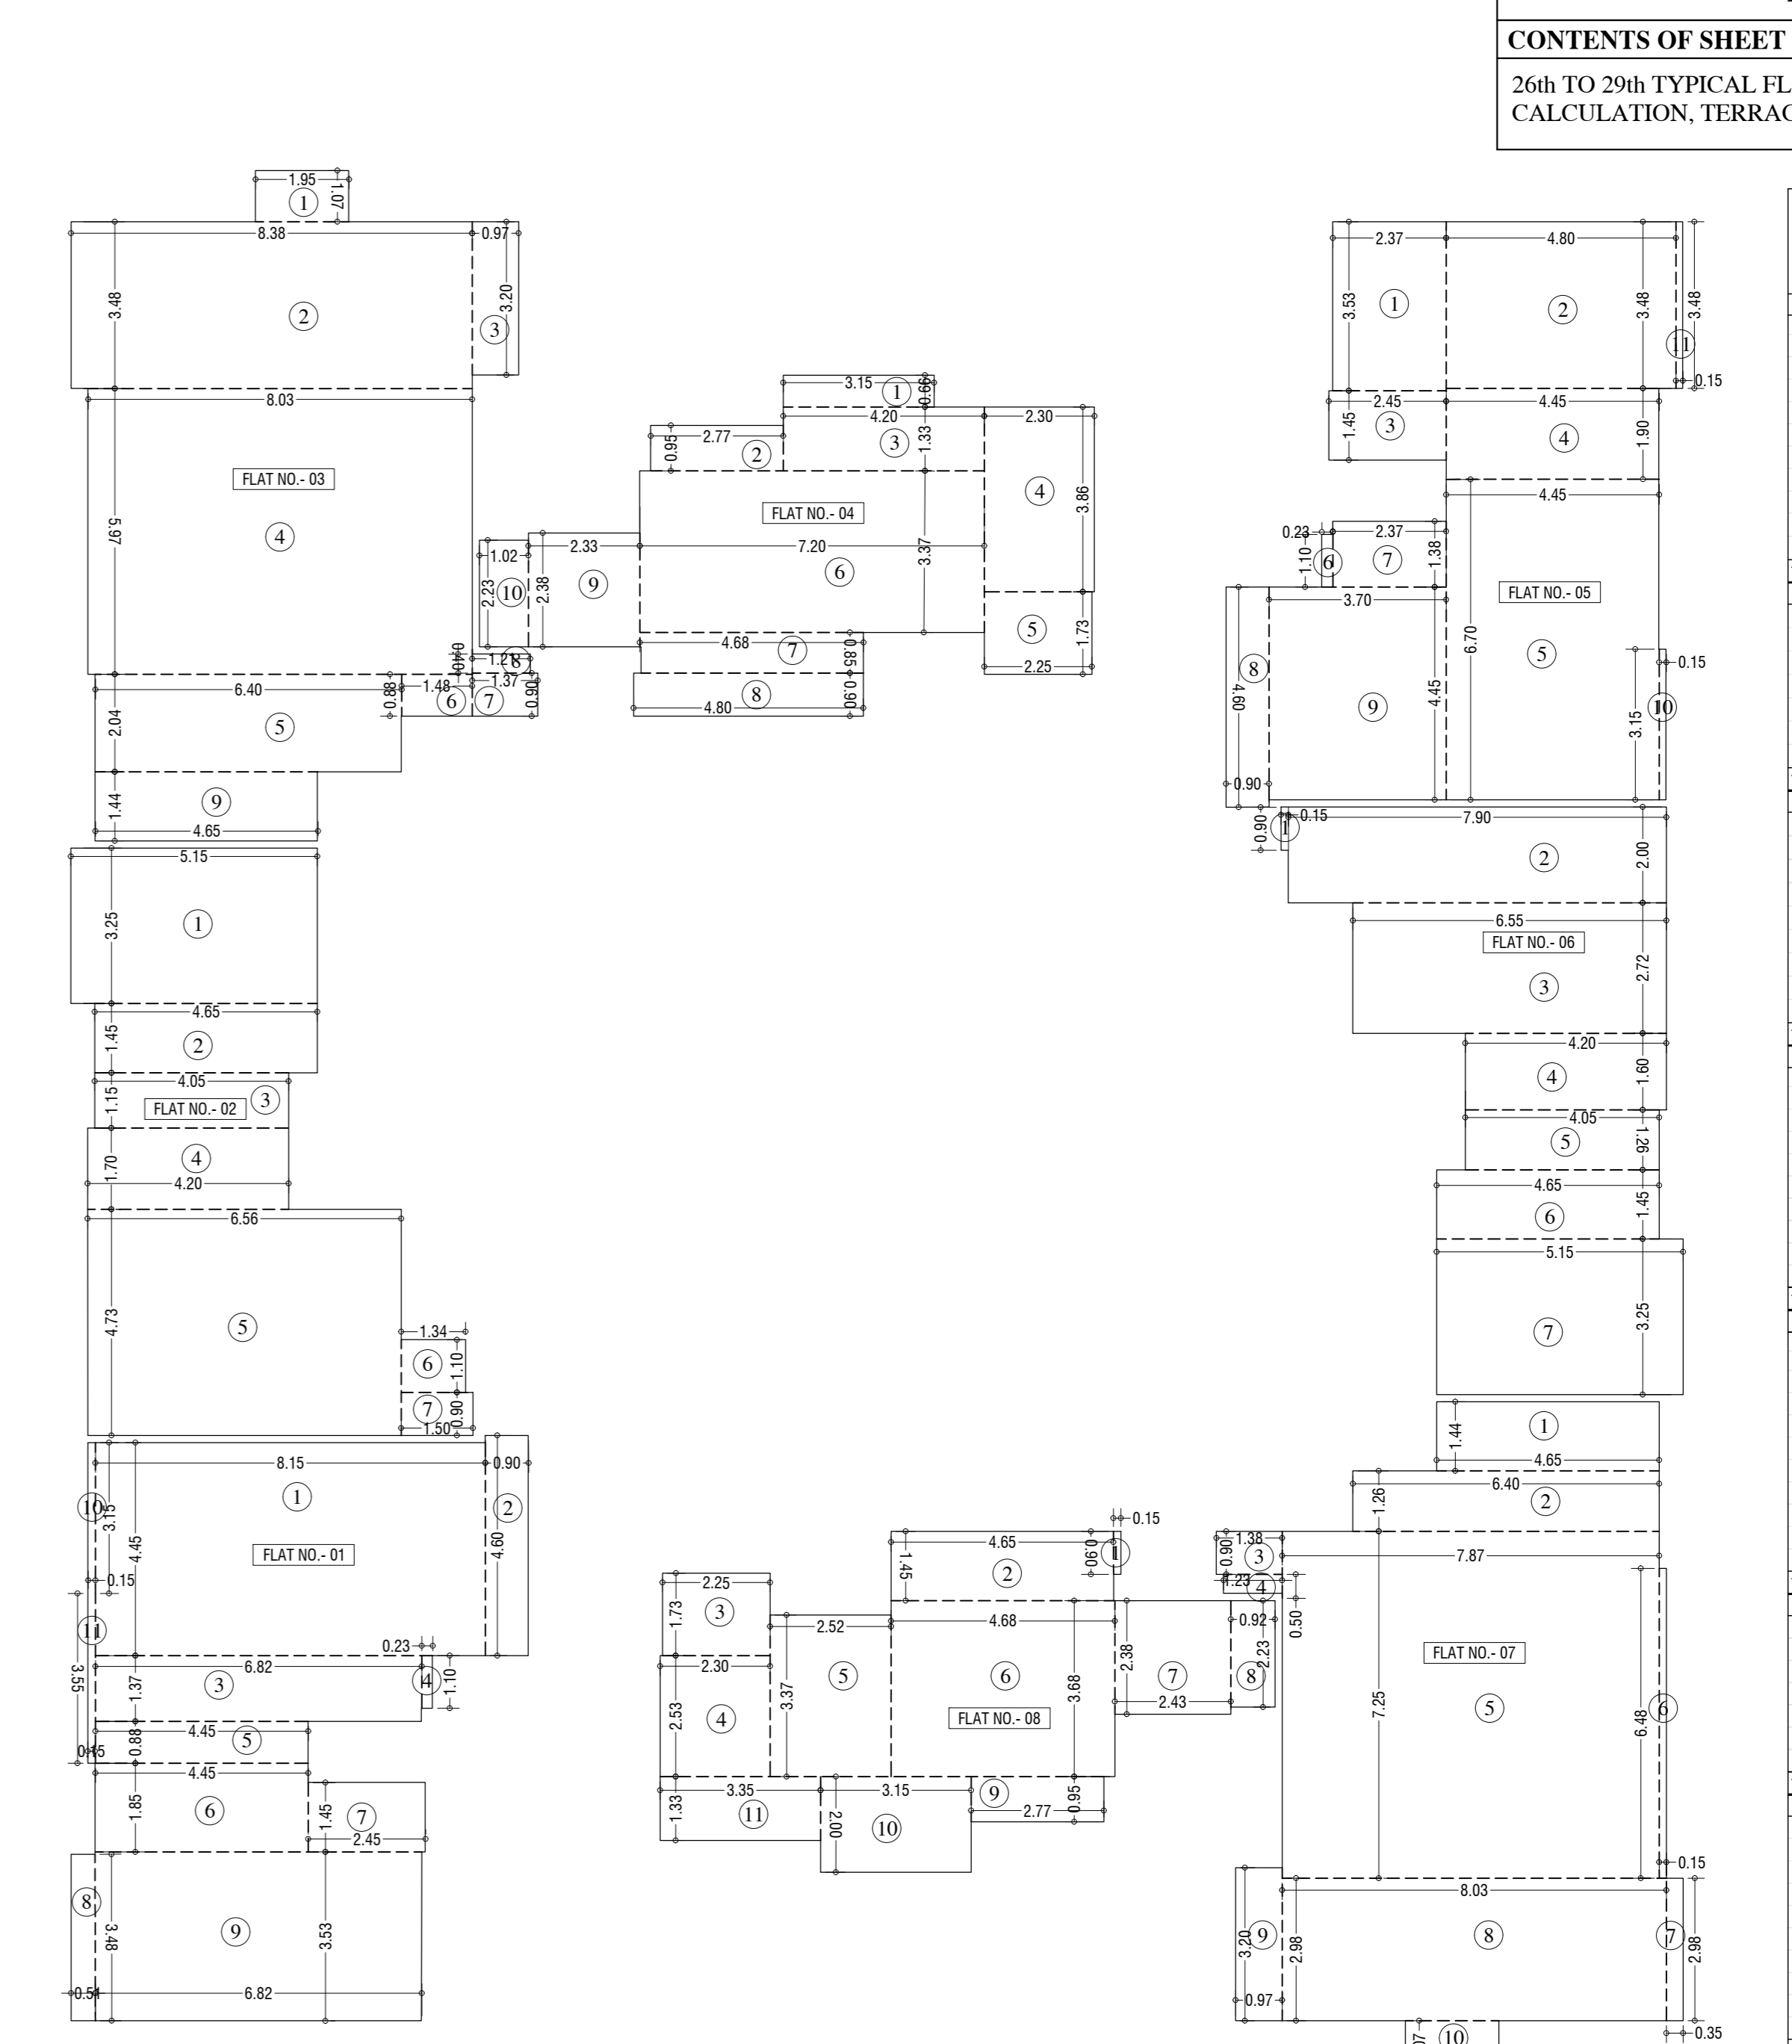


CARPET LINE AREA DIA. FOR PARKING PURPOSE 26th TO 29th TYPICAL FLOOR (WING=T-4)
SCALE: 1:100

Table with multiple columns: CARPET AREA FOR PARKING PURPOSE, 26th TO 29th TYPICAL FLOOR (WING=T-4). Rows include flat numbers (e.g., FLAT NO.-01 to FLAT NO.-08) and their respective areas in sqm, with a total area of 92.54 sqm.



26th TO 29th TYPICAL FLOOR PLAN (WING=T-4)
SCALE: 1:100

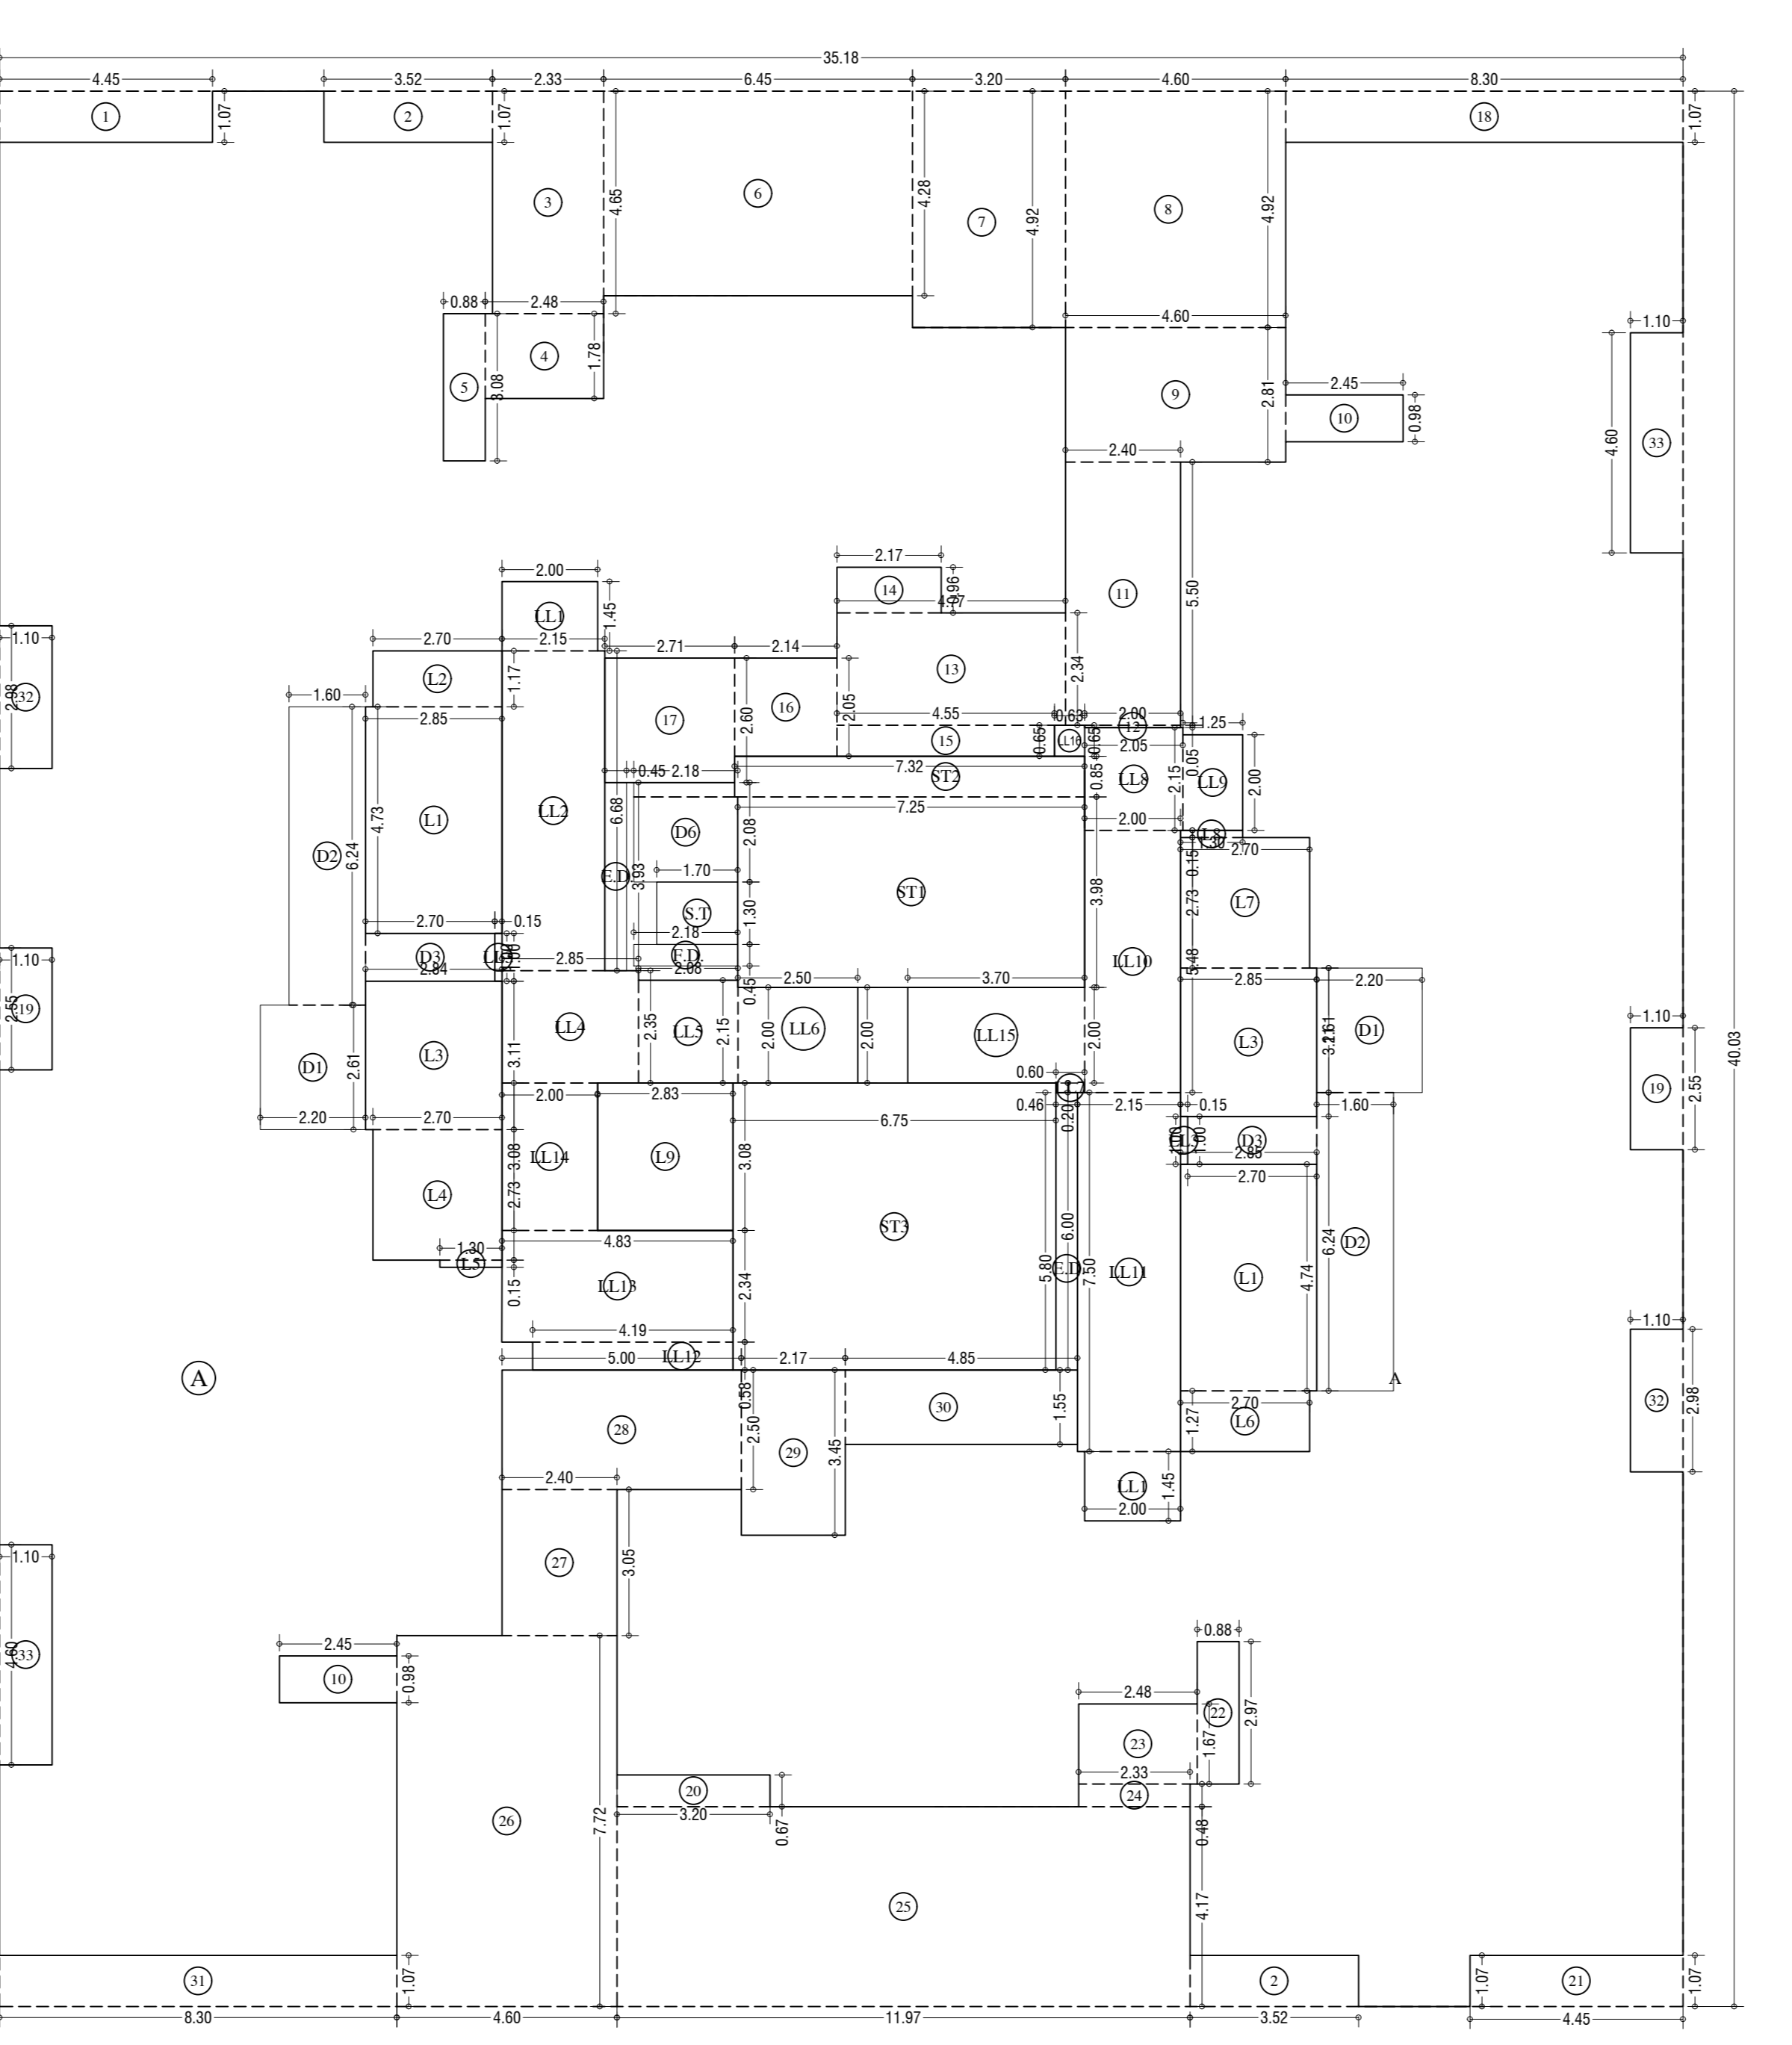

LINE AREA DIAGRAM FOR 26TH TO 29TH FLOOR (WING=T-4)
SCALE: 1:100

Table titled 'BUILT UP AREA FOR 26TH TO 29TH CALCULATION (WING=T-4)'. It lists various areas (A, B, C, etc.) and their corresponding built-up areas, with a total built-up area of 1079.16 sqm.

Table titled 'LIFT AREA CALCULATION'. It lists lift shafts (L1 to L16) and their respective areas, with a total lift area of 96.45 sqm.


Table titled 'STAIRCASE AREA CALCULATION'. It lists staircase areas (ST1 to ST3) and their respective areas, with a total staircase area of 75.58 sqm.


STAMP AND DATE OF APPROVAL OF PLAN
APPROVED SUBJECT TO THE CONDITIONS MENTIONED IN THIS OFFICE LETTER NO P-12131/2022/611 And Other/S Ward/Kanjur-W

DESCRIPTION OF PROPOSAL & PROPERTY
PROPOSED DEVELOPMENT ON PLOT BEARING CTS NO.611, 611/1 TO 611/10 OF VILLAGE KANIUR, SITUATED IN S-WARD, MUMBAI.


Table with columns: NORTH, JOB NO., DRG. NO., DRAWN BY, SCALE, DATE, CHECKED BY. Values include 498, 22/25, PRACHI, 1:100, NIKHIL.

Table with columns: NAME OF THE OWNER, SIGNATURE, NAME AND ADDRESS OF LICENSED SURVEYOR (L.S.), SIGNATURE. Owner: M/S. JAIHIND OIL MILL CO.

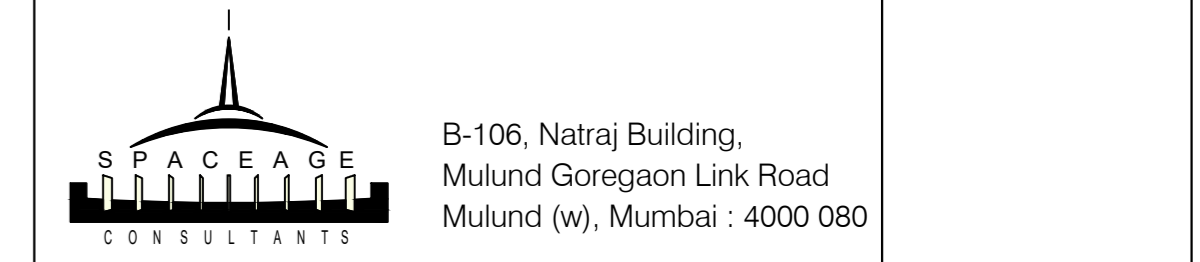


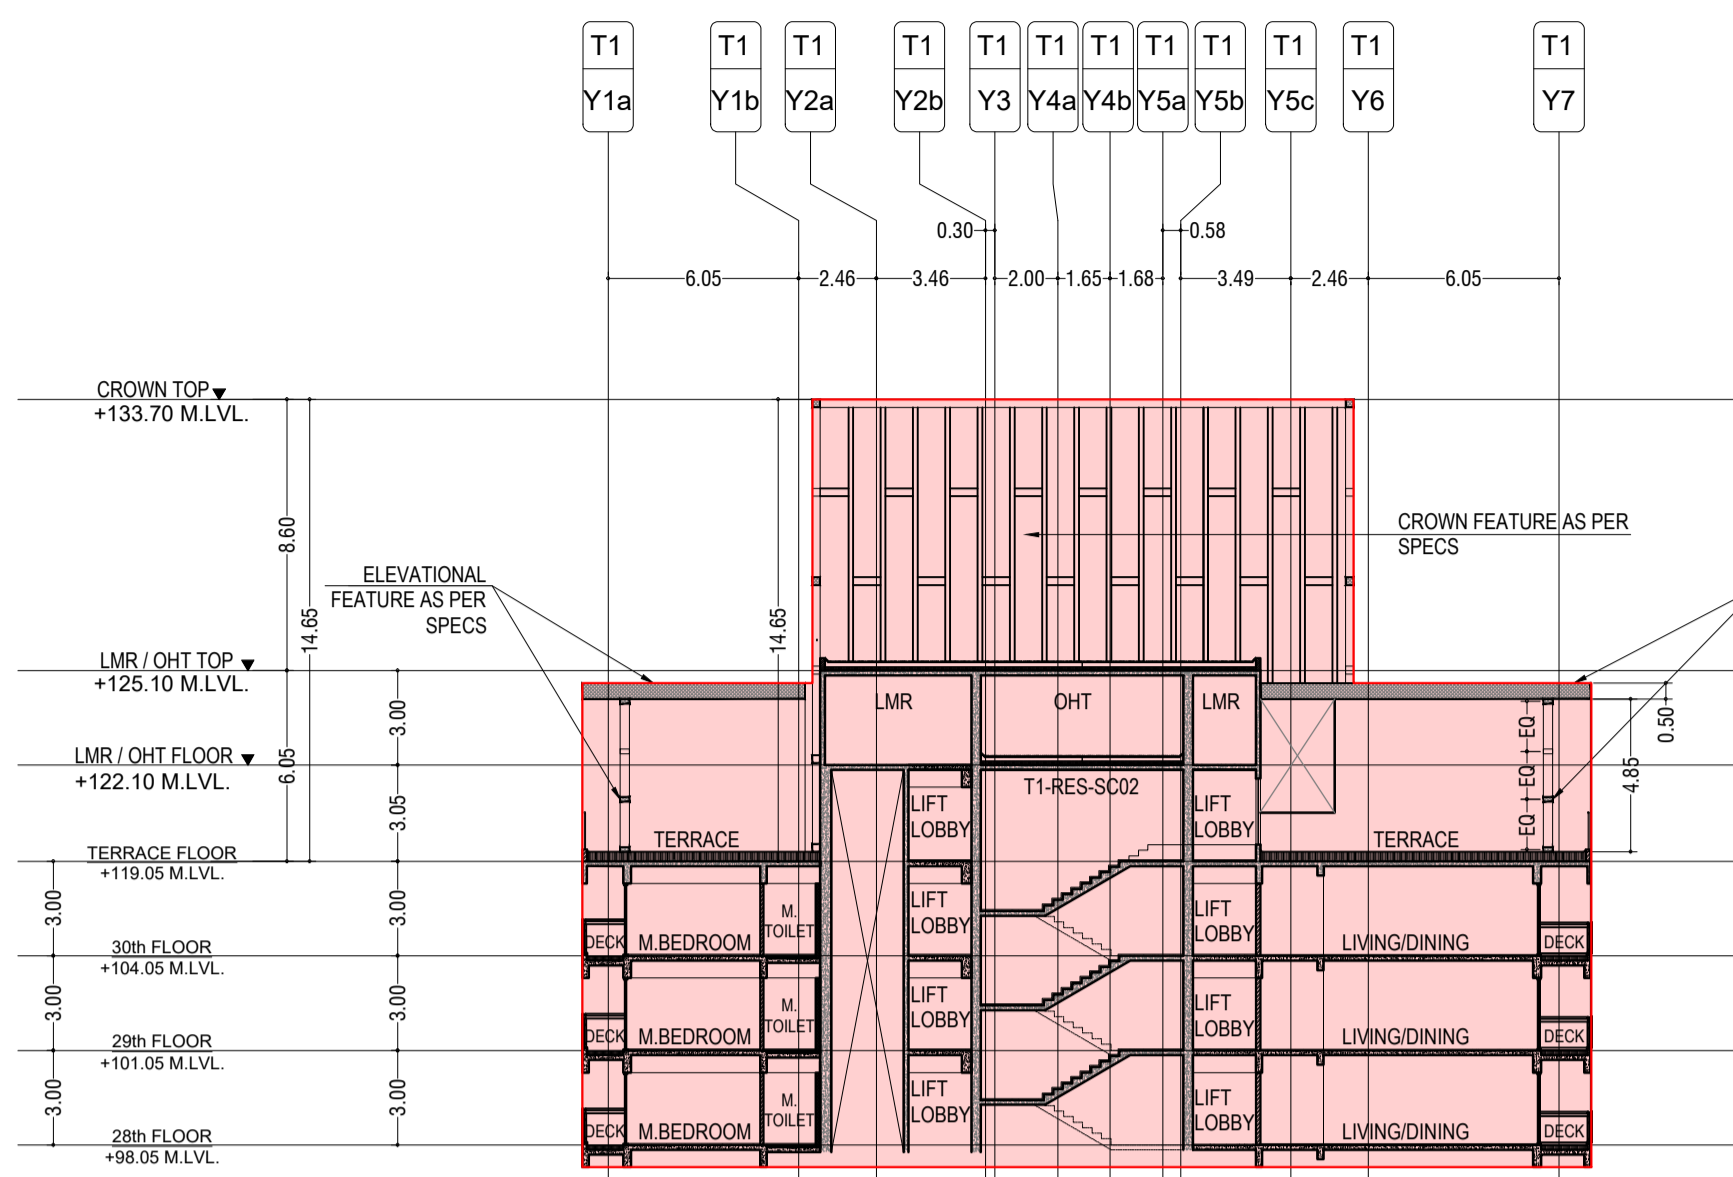

SECTION - 1 (ELEVATIONAL FEATURE - CROWN SCHEMATIC)
 SCALE - 1:200

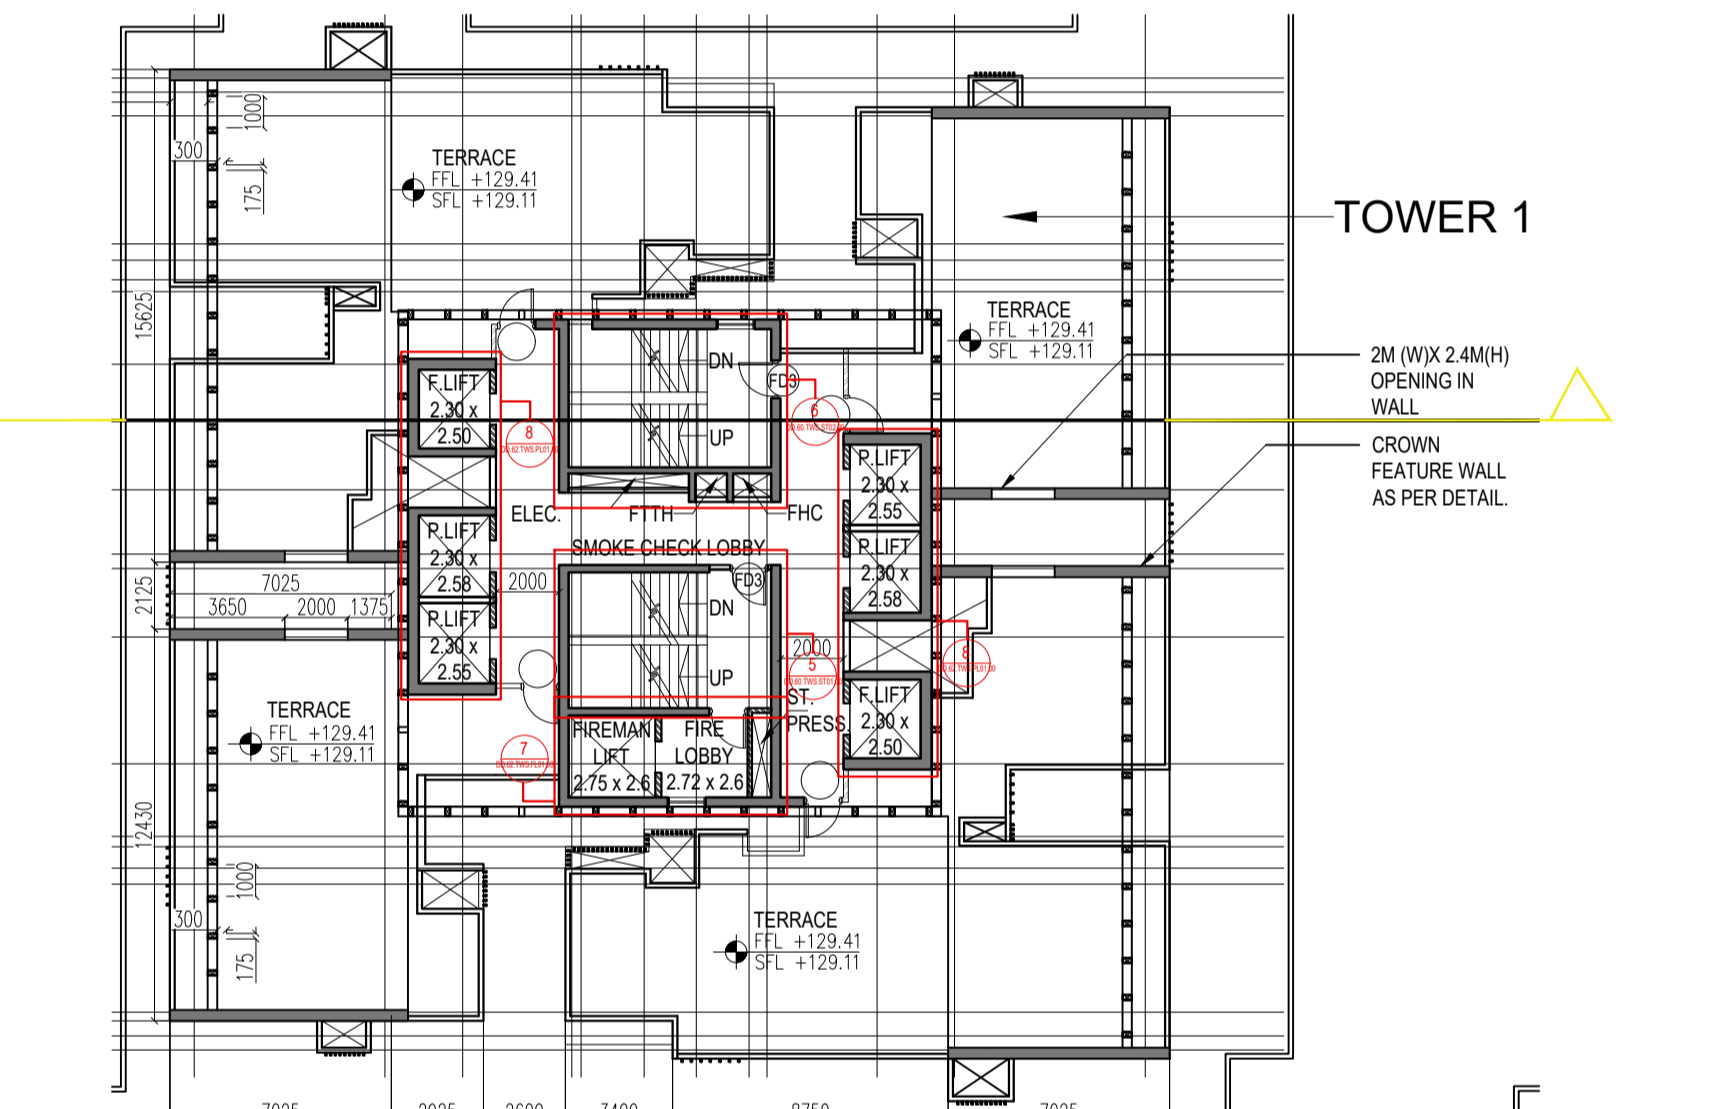


TOWER 1
 2M (Wx 2.4M) OPENING IN WALL
 CROWN FEATURE WALL AS PER DETAIL

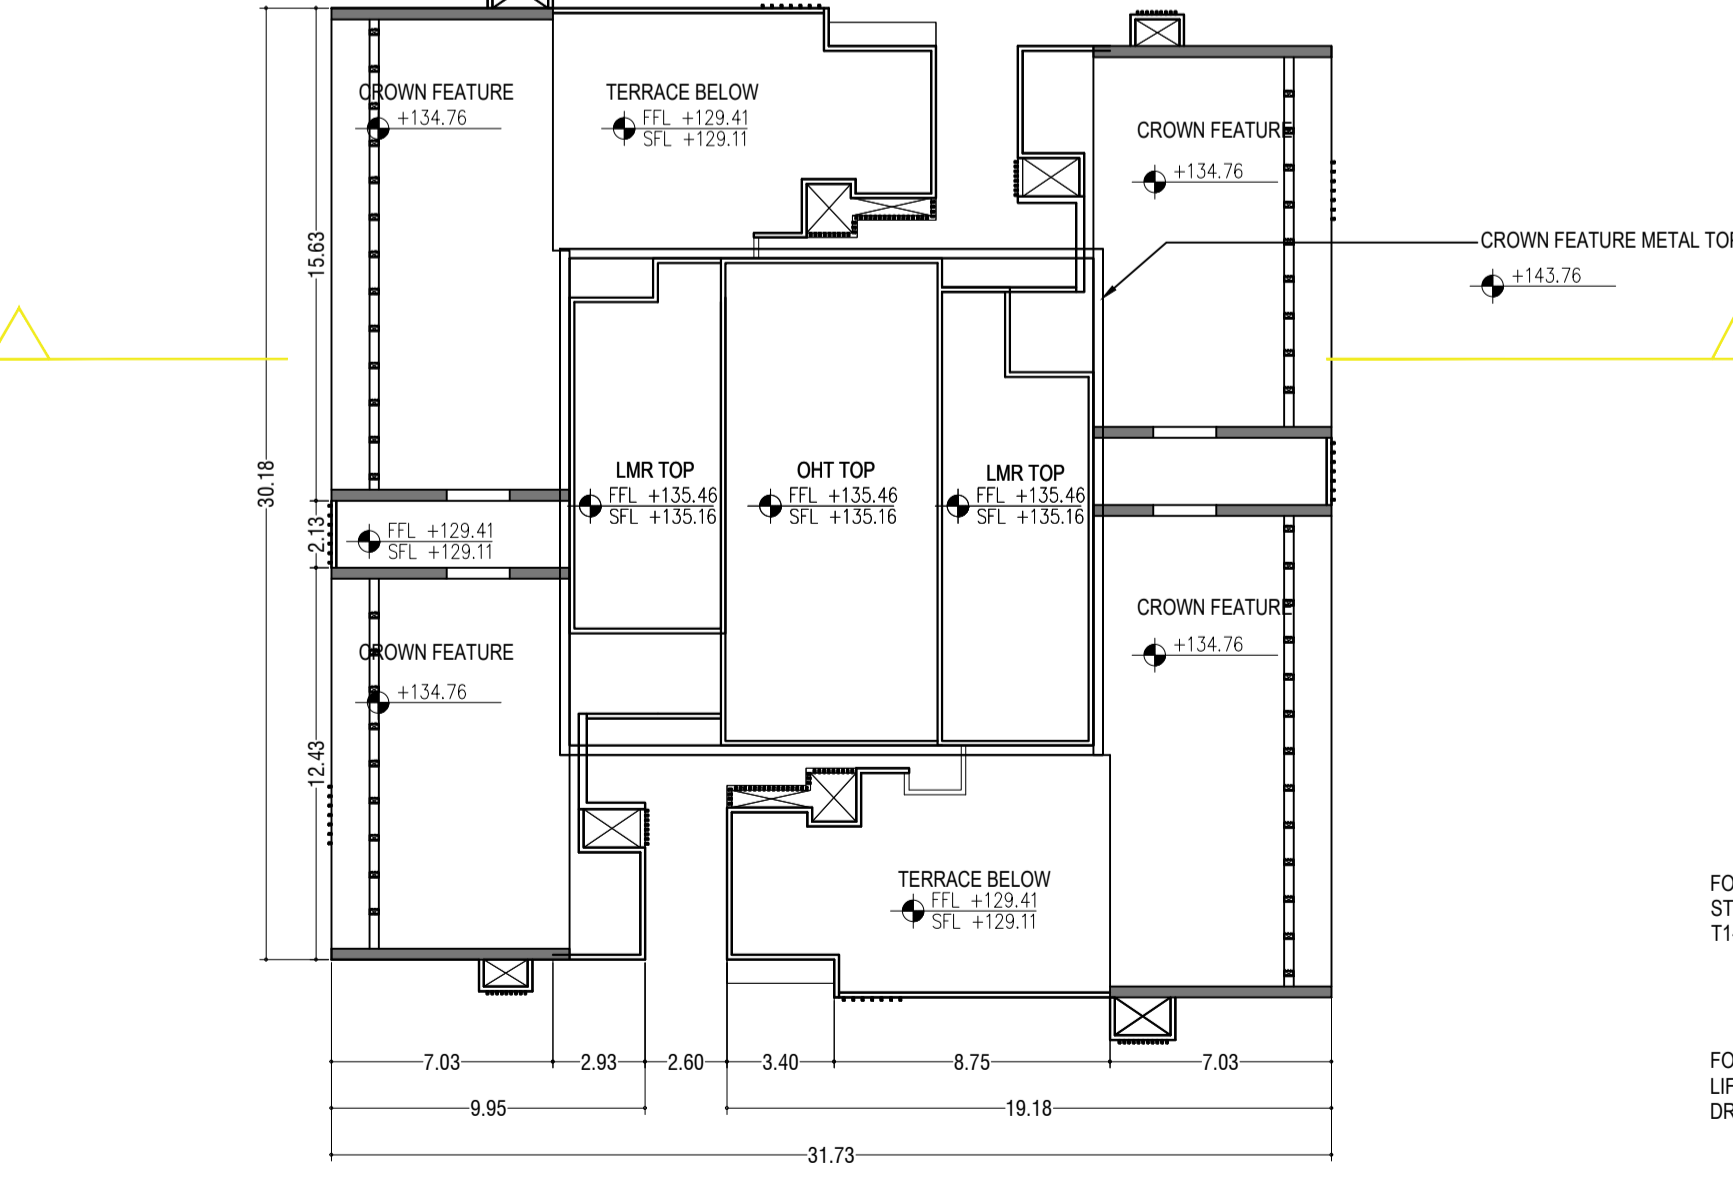


TERRACE FLOOR PLAN
 SCALE - 1:200



ROOF FLOOR PLAN
 SCALE - 1:200

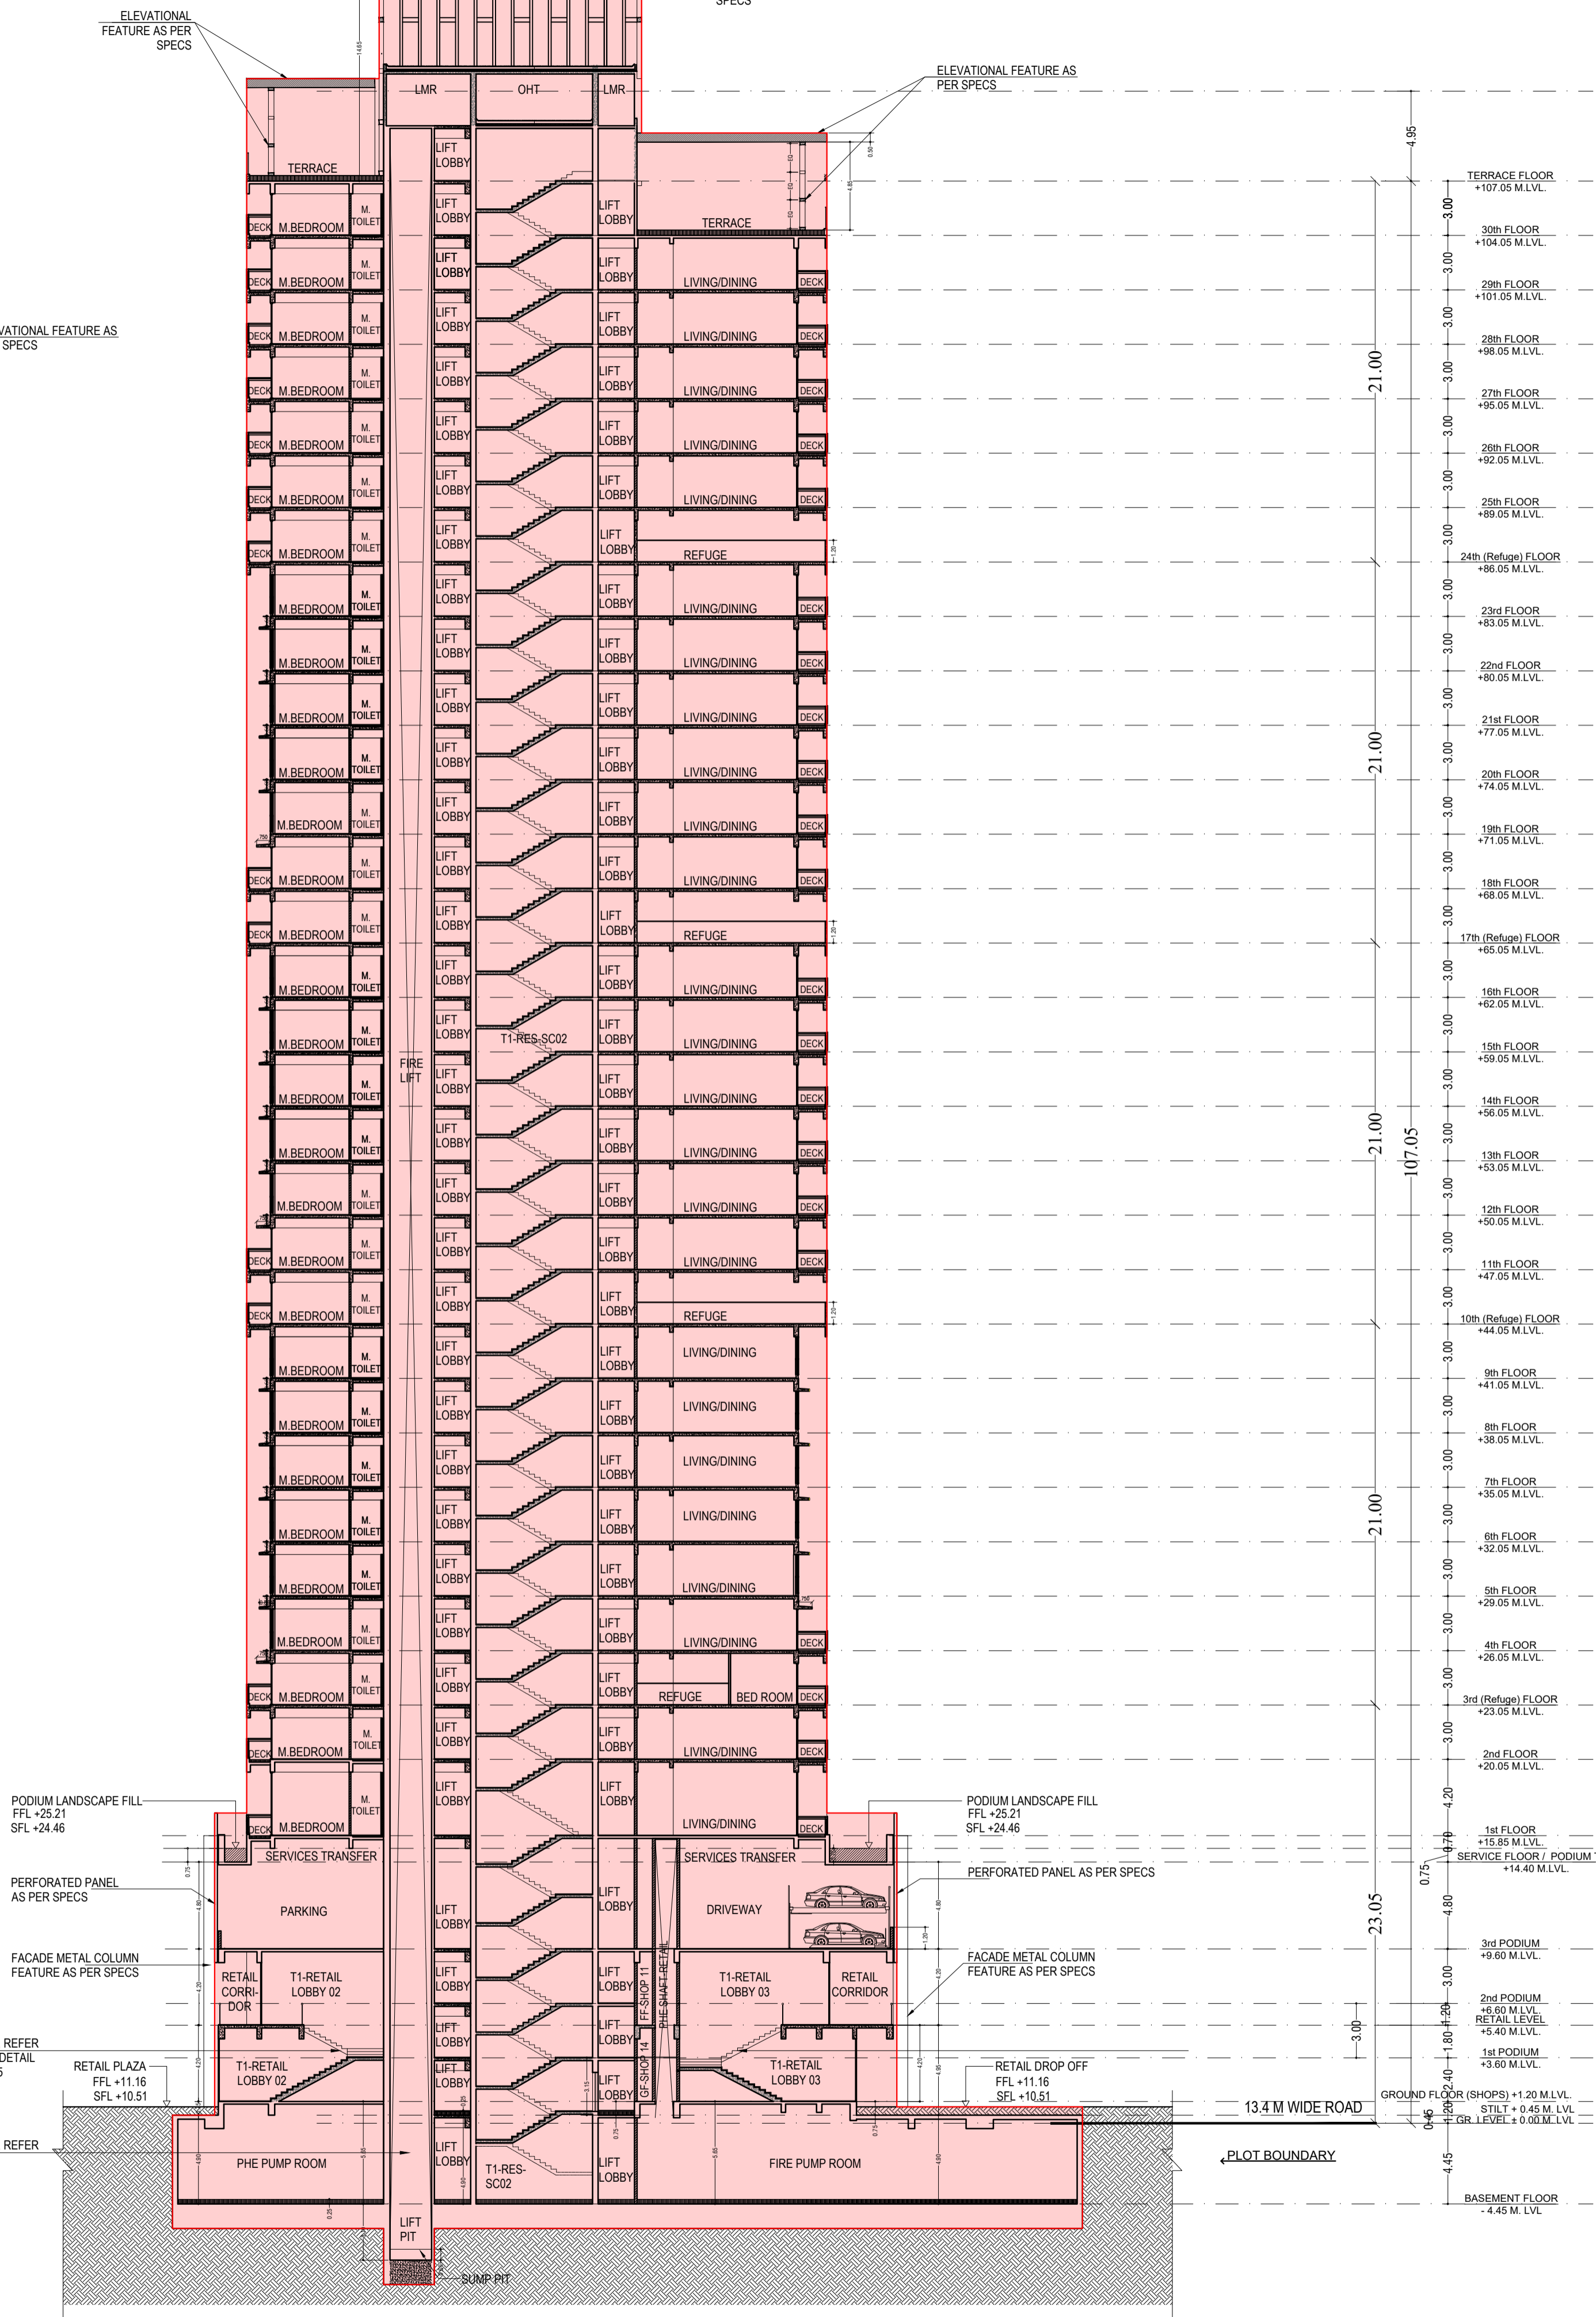

SECTION - 3:3 (TOWER - 1)
 SCALE - 1:200

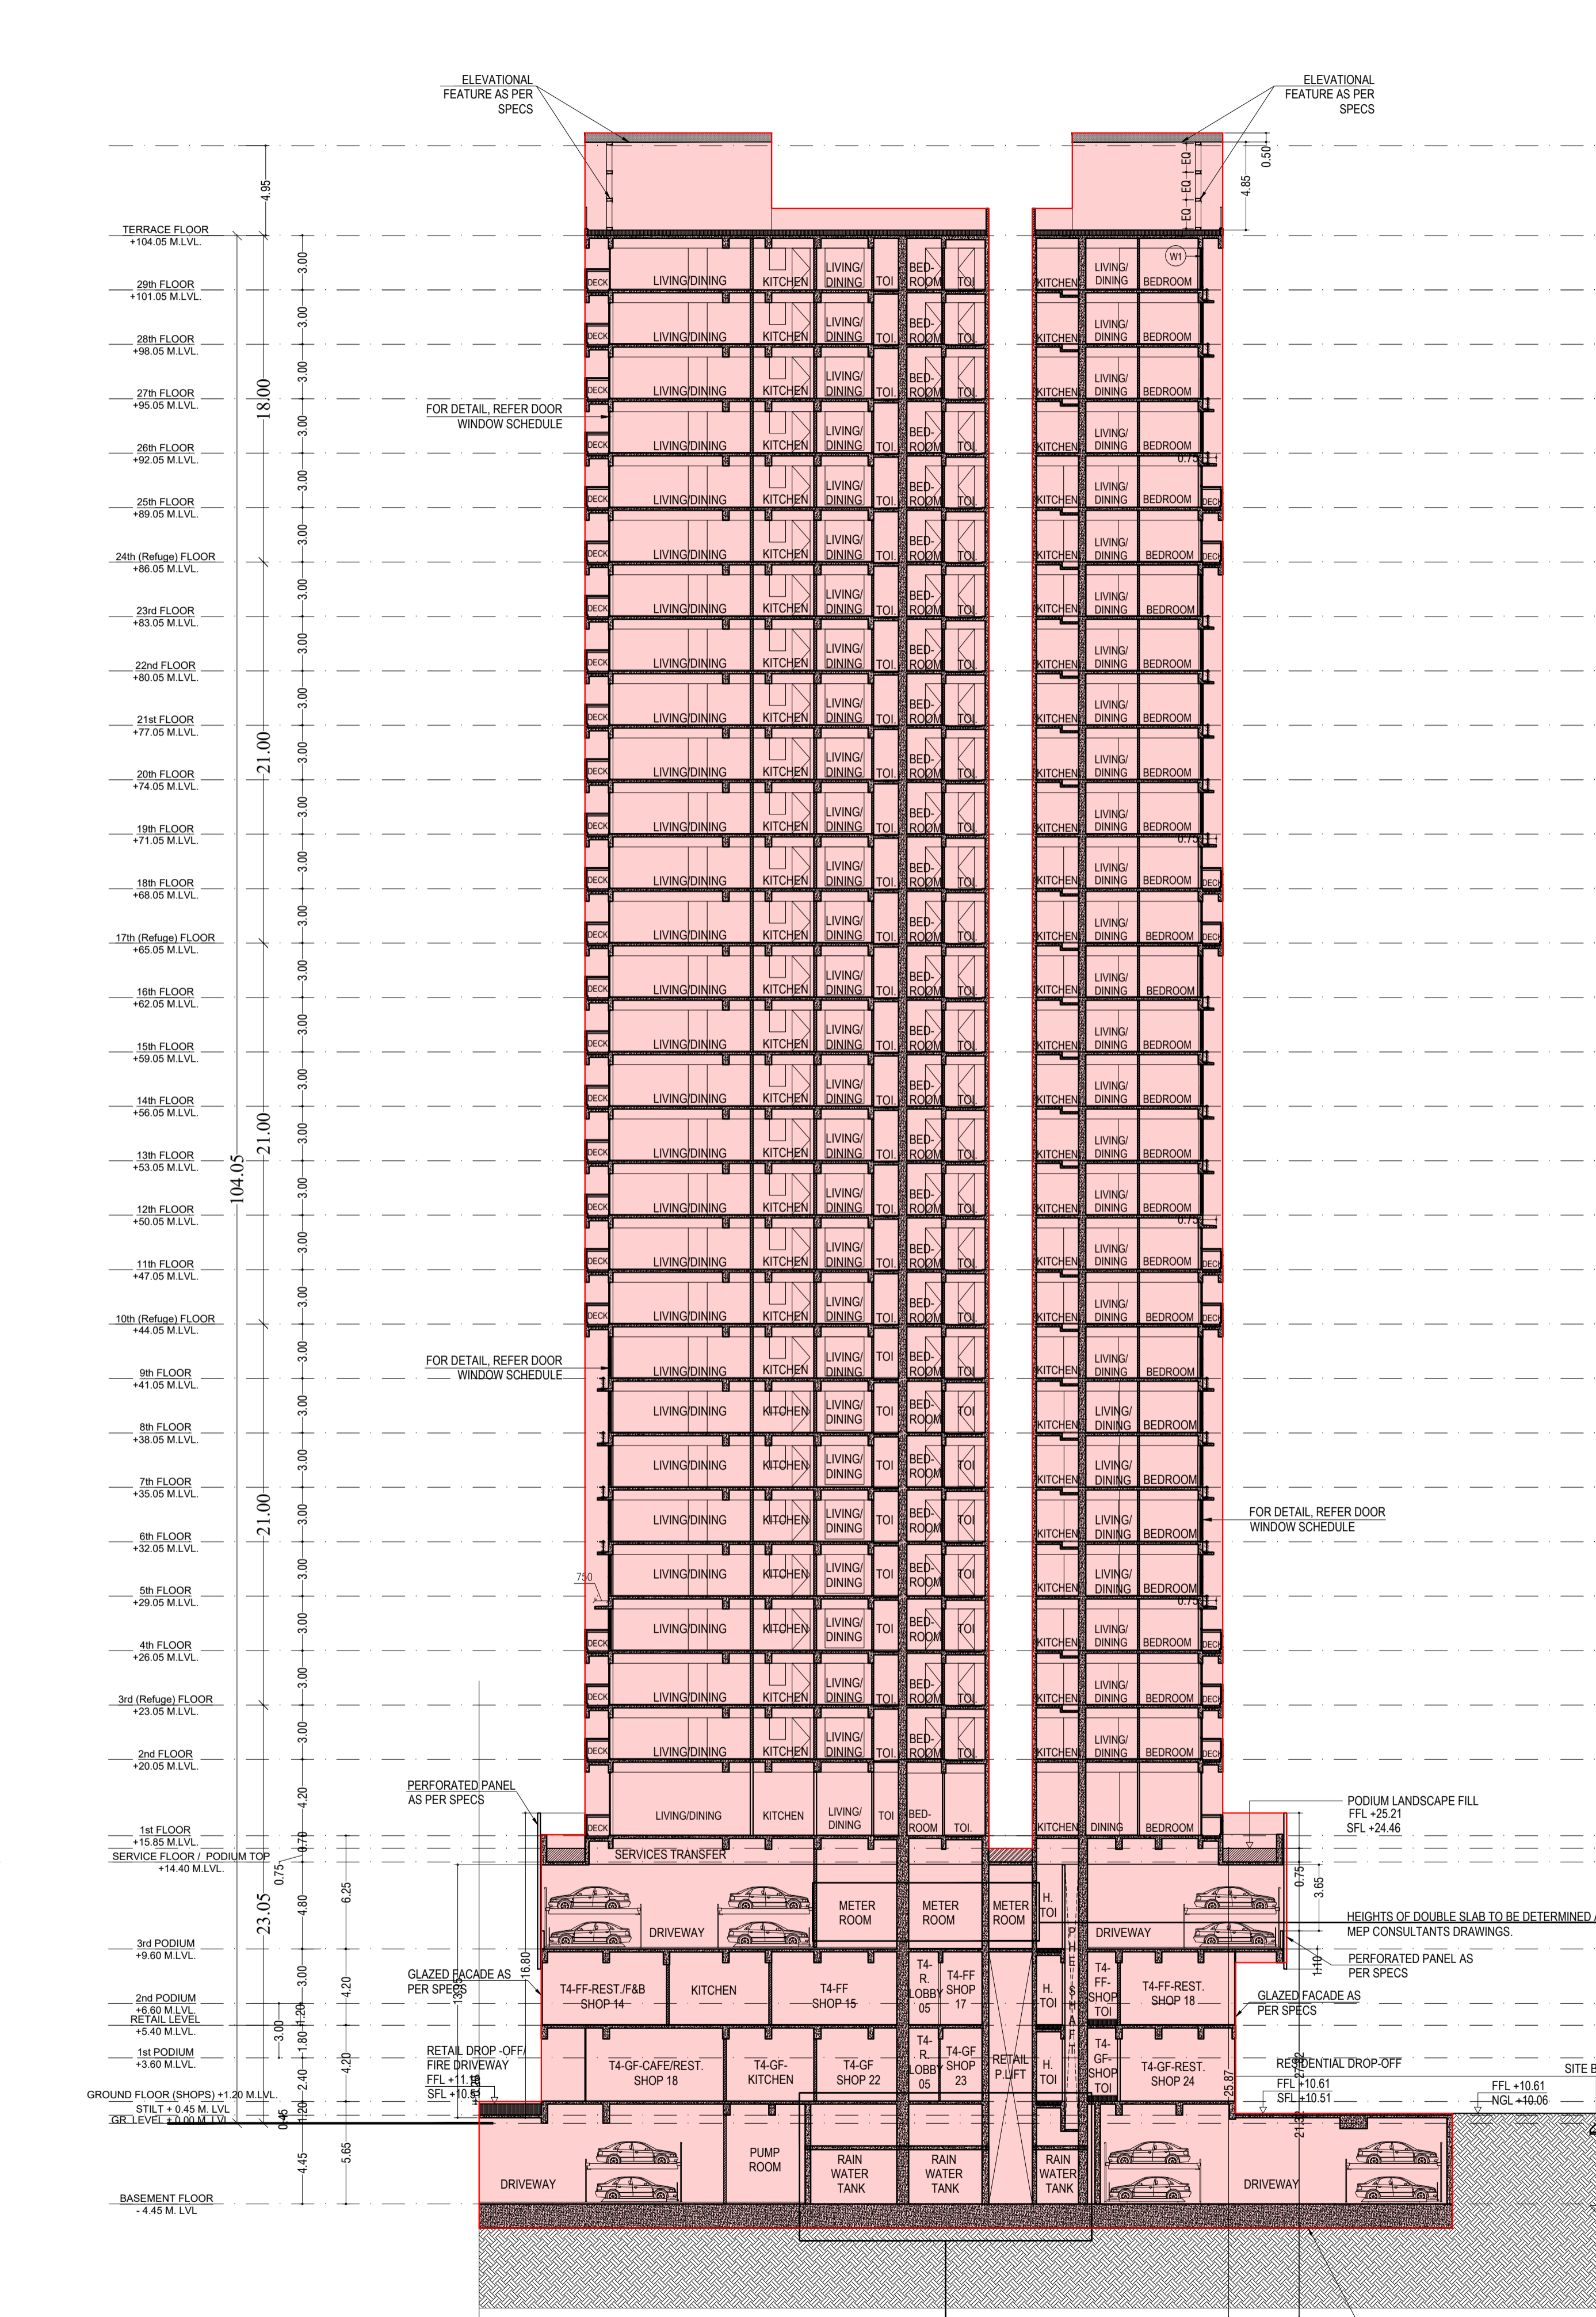

SECTION - 4:4 (TOWER - 4)
 SCALE - 1:200

STAMP AND DATE OF APPROVAL OF PLAN
 APPROVED SUBJECT TO THE CONDITIONS MENTIONED IN THIS OFFICE LETTER NO P-1213/2022(611 And Other) S Ward Kanjur-W

S.E./P./S.W	A.E./P./S.T	E.X. ENG./P./E.S.-II
STAMP AND DATE OF RECEIPT OF PLAN		

DESCRIPTION OF PROPOSAL & PROPERTY			
PROPOSED DEVELOPMENT ON PLOT BEARING CTS NO.611, 6111 TO 61110 OF VILLAGE KANJUR, SITUATED IN S-WARD, MUMBAI.			
NORTH	JOB NO.	DRG. NO.	DRAWN BY
	488	23/25	PRACHI
REVISIONS	SCALE	DATE	CHECKED BY
1/23	1:200		NIKHIL
NAME AND ADDRESS OF DESIGN ARCHITECT			
R.D.			

NAME OF THE OWNER	SIGNATURE
MS. JAIHIND OIL MILL CO.	

NAME AND ADDRESS OF LICENSED SURVEYOR (L.S)	SIGNATURE

STAMP AND DATE OF APPROVAL OF PLAN APPROVED SUBJECT TO THE CONDITIONS MENTIONED IN THIS OFFICE LETTER NO P-12131/2022/0411 And Other's Ward Kanjur-W

SE.(B.P.)/SW A.E.(B.P.)/S & T EX. ENGR./P.O.S-II STAMP AND DATE OF RECEIPT OF PLAN



DESCRIPTION OF PROPOSAL & PROPERTY PROPOSED DEVELOPMENT ON PLOT BEARING CTS NO.611, 611/1 TO 611/10 OF VILLAGE KANJUR, SITUATED IN S-WARD, MUMBAI.

NORTH	JOB NO.	DRG. NO.	DRAWN BY
	098	24/25	FRACH
REVISIONS	DESCRIPTION :	DATE	CHECKED BY
1	1:00		NIKHIL

NAME AND ADDRESS OF DESIGN ARCHITECT


NAME OF THE OWNER MS. JAHIND OIL MILL CO. SIGNATURE

NAME AND ADDRESS OF LICENSED SURVEYOR (L.S.) SIGNATURE

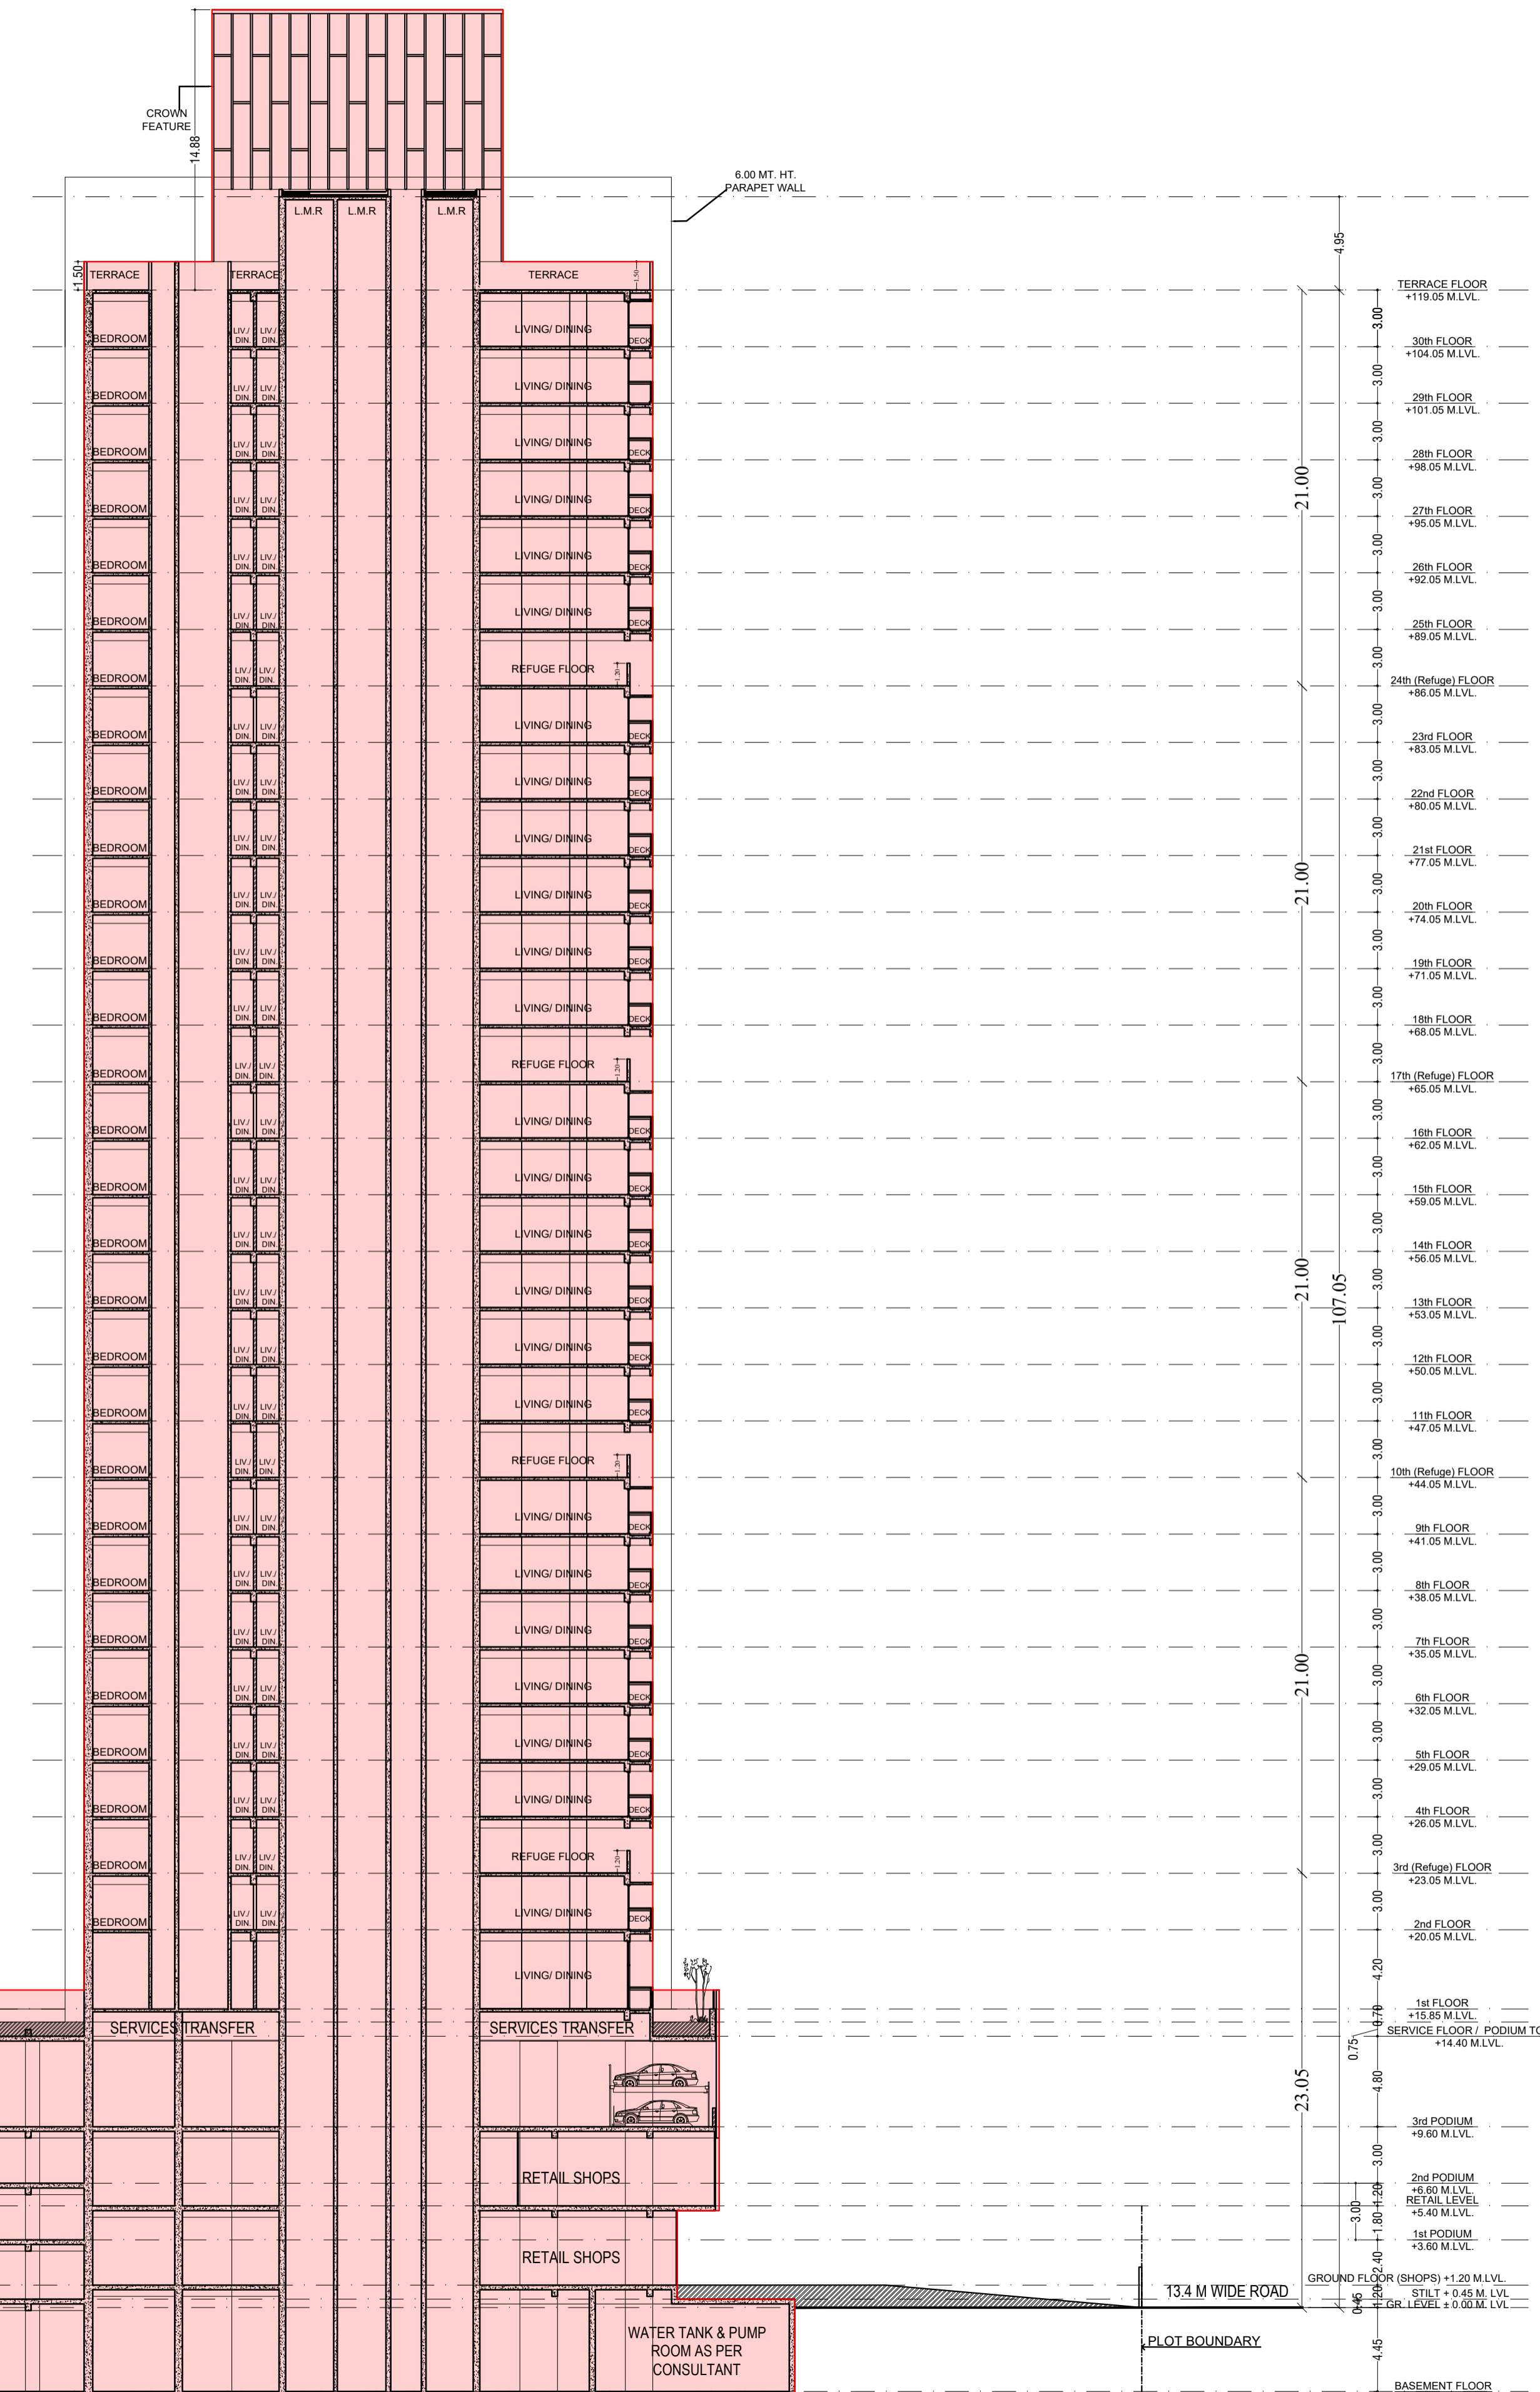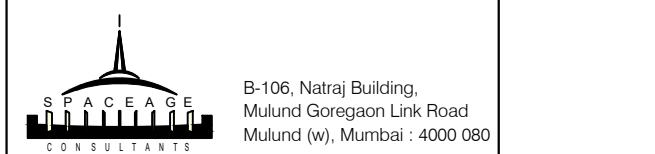

SECTION :- 2-2 (WING-T-1) SCALE: 1:200

T1

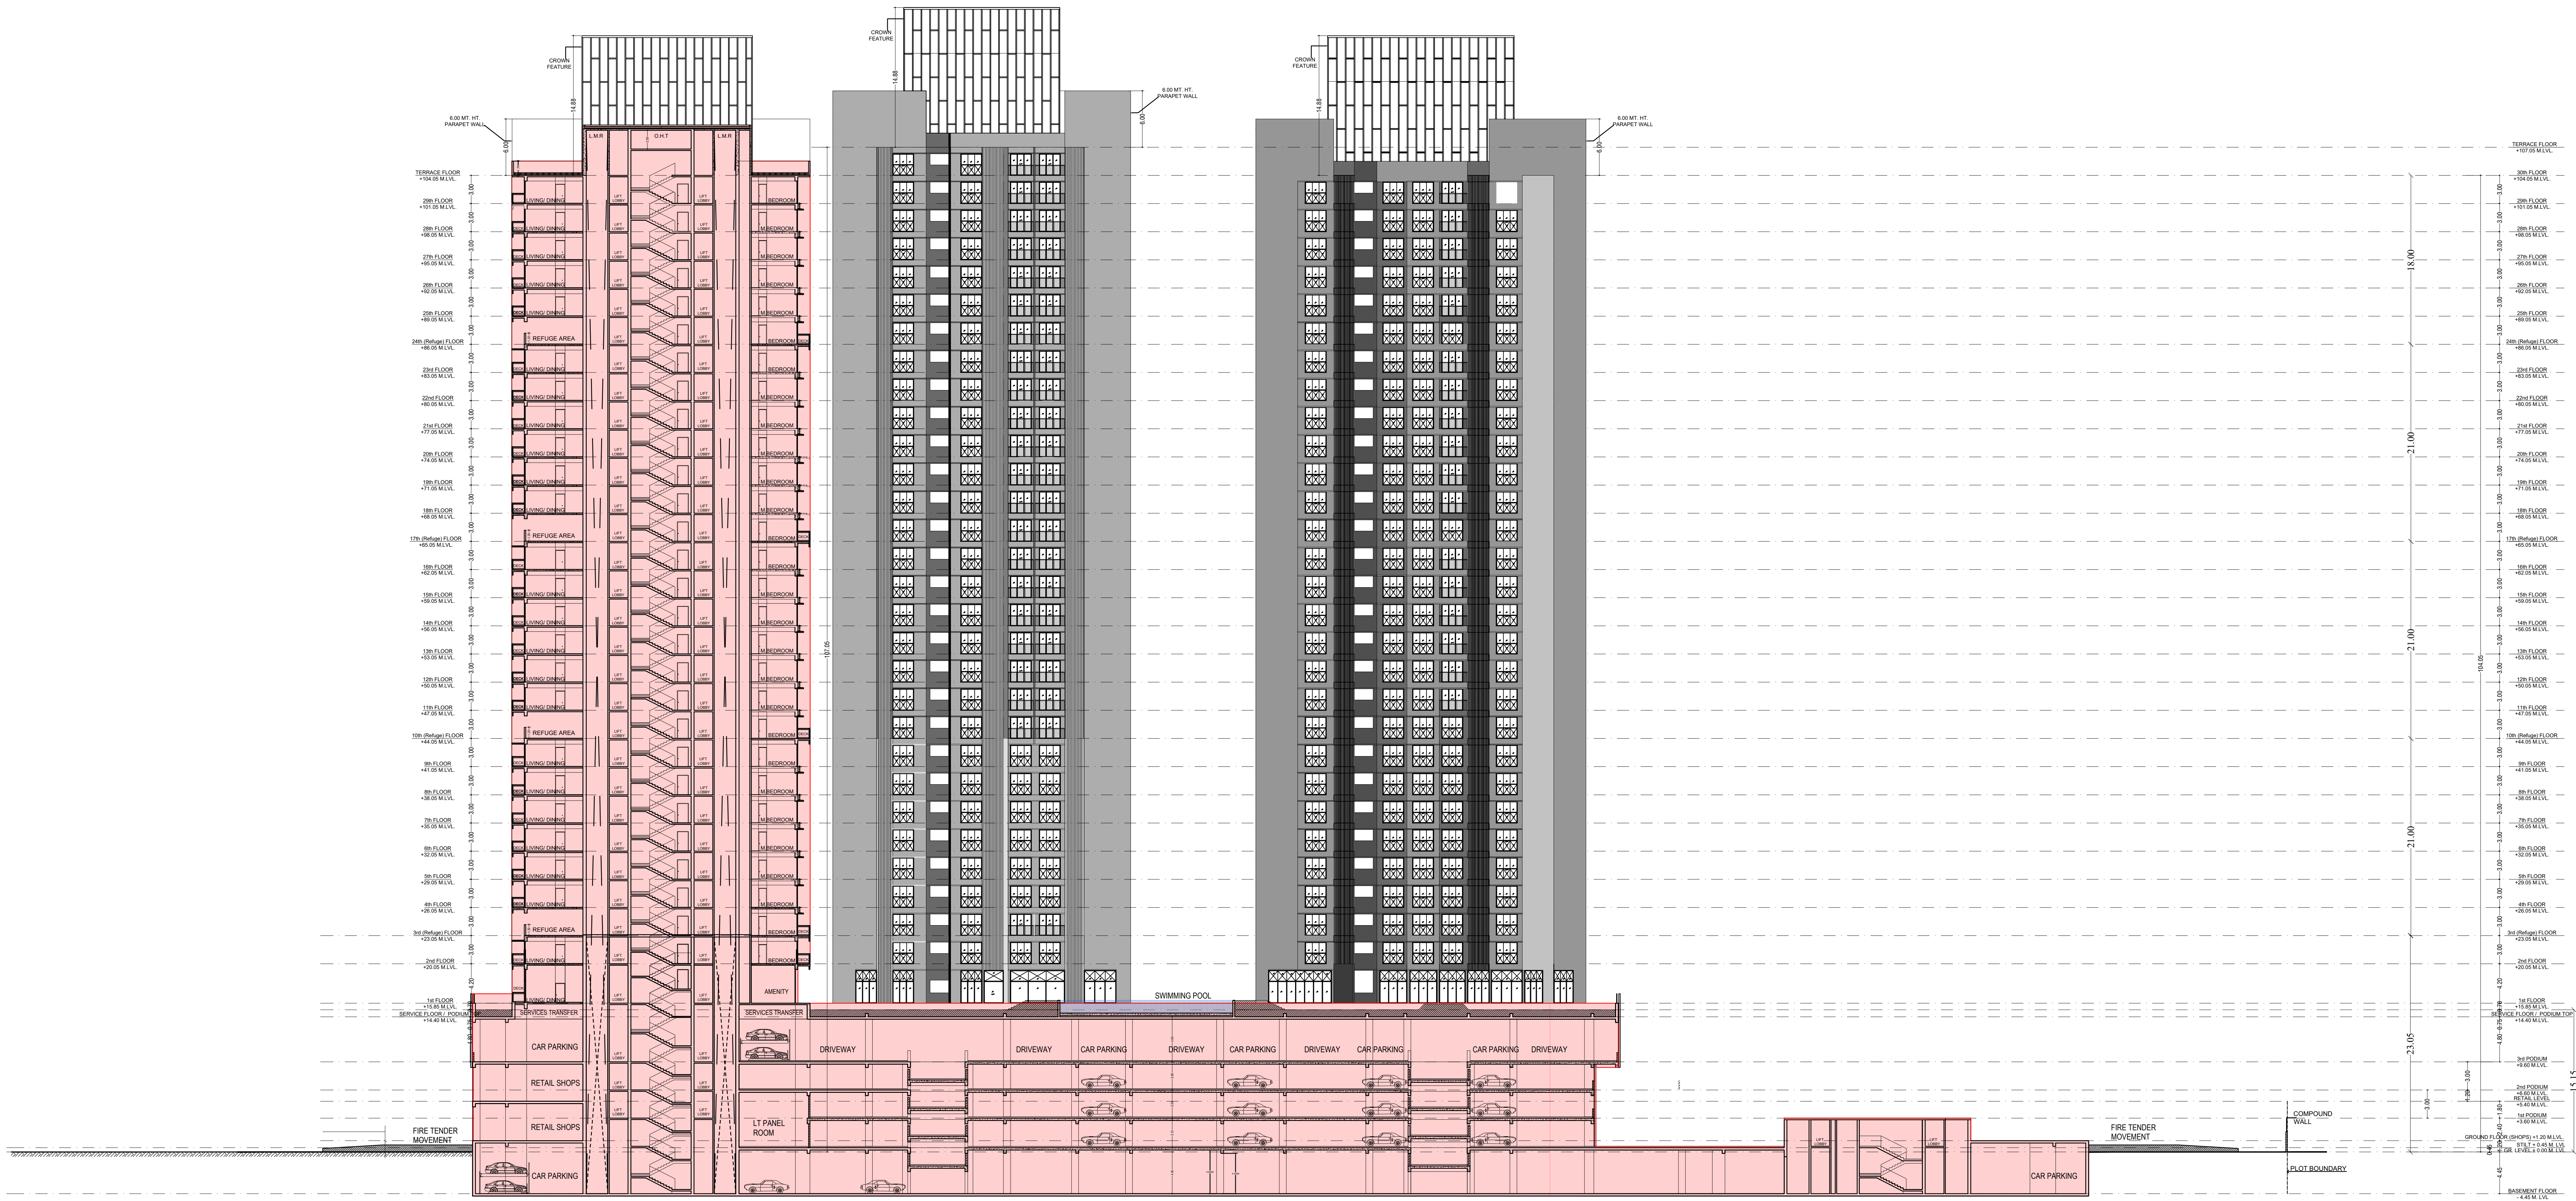

SECTION - 1-1 (TOWER - 2 & 5)
 SCALE - 1:200

STAMP AND DATE OF APPROVAL OF PLAN
 APPROVED SUBJECT TO THE CONDITIONS MENTIONED IN THIS OFFICE LETTER NO P-1213/2022/041 And Other's Ward Kanjur-W

SE:R.P./S.W	AE:R.P./S.&T	EX:ENG./R.P./ES-H
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STAMP AND DATE OF RECEIPT OF PLAN

DESCRIPTION OF PROPOSAL & PROPERTY
 PROPOSED DEVELOPMENT ON PLOT BEARING-CES NO.0411/011 TO 011/10/01 VILLAGE KANJUR, SITUATED IN S-WARD, MUMBAI

NORTH	JOB NO.	DRG. NO.	DRAWN BY
48	1500	5/20	FRANK
SCALE	DATE	CHECKED BY	
1:500		NIKHIL	

REVISIONS DESCRIPTION:

NO.	DESCRIPTION
-----	-------------

NAME AND ADDRESS OF DESIGN ARCHITECT

NAME OF THE OWNER	SIGNATURE
MS. JABIND OIL MILL CO.	

NAME AND ADDRESS OF LICENSED SURVEYOR (I.S.)

	SIGNATURE
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