


2ND TO 6TH TYPICAL FLOOR PLAN
SCALE: 1:100

2ND TO 6TH TYPICAL FLOOR AREA DIAGRAM
SCALE: 1:100

BUILT UP AREA CALCULATION			
2ND TO 6TH TYPICAL FLOOR			
A	12.30	X	47.34 X 1 NO
TOTAL ADDITION		=	582.88 SQ.MT.
DEDUCTIONS			
1	1.45	X	2.40 X 1 NO
2	2.95	X	1.85 X 1 NO
3	4.15	X	1.70 X 1 NO
4	0.35	X	14.65 X 1 NO
5	1.10	X	1.55 X 1 NO
6	1.20	X	0.85 X 1 NO
7	3.45	X	4.15 X 1 NO
8	1.35	X	1.05 X 1 NO
9	1.45	X	1.30 X 1 NO
10	0.70	X	5.80 X 1 NO
11	0.45	X	0.15 X 1 NO
12	0.45	X	4.95 X 1 NO
13	0.85	X	1.07 X 1 NO
14	3.05	X	1.34 X 1 NO
15	1.10	X	8.30 X 1 NO
16	0.90	X	1.20 X 1 NO
17	2.15	X	8.30 X 1 NO
18	0.80	X	4.15 X 1 NO
19	1.85	X	7.54 X 1 NO
20	1.80	X	4.70 X 1 NO
21	0.75	X	1.20 X 1 NO
22	1.30	X	3.30 X 1 NO
23	1.85	X	4.55 X 1 NO
24	0.35	X	1.30 X 1 NO
25	0.80	X	3.20 X 1 NO
26	3.05	X	0.75 X 1 NO
27	2.40	X	4.15 X 1 NO
28	0.25	X	5.30 X 1 NO
TOTAL DEDUCTION		=	130.11 SQ.MT.
EQ. FD AREA CALCULATION			
D1	0.45	X	3.10 X 1 NO
D2	0.85	X	0.28 X 1 NO
D3	1.05	X	0.45 X 1 NO
D4	0.45	X	1.05 X 1 NO
TOTAL DED. AREA		=	2.83 SQ.MT.
TOTAL BUILT UP AREA (A - D1 - D2 - D3 - D4)		=	454.03 SQ.MT.
STAIRCASE & LIFT AREA CALCULATION			
S1	2.85	X	4.15 X 1 NO
S2	2.35	X	3.10 X 1 NO
S3	3.50	X	1.80 X 1 NO
S4	2.15	X	1.20 X 1 NO
S5	3.40	X	4.80 X 1 NO
S6	4.50	X	2.85 X 1 NO
S7	6.15	X	1.34 X 1 NO
S8	1.35	X	2.40 X 1 NO
S9	0.40	X	1.80 X 1 NO
S10	0.25	X	2.10 X 1 NO
S11	3.40	X	2.85 X 1 NO
TOTAL STAIRCASE & LIFT AREA		=	87.00 SQ.MT.
REAR WING AREA			
R1	5.37	X	4.12 X 1 NO
R2	4.87	X	2.33 X 1 NO
R3	3.40	X	2.15 X 1 NO
R4	2.30	X	2.88 X 1 NO
REAR BUILT UP AREA		=	46.02 SQ.MT.
NET BUILT UP AREA (A - D1 - D2 - D3 - D4 - S1 - S2 - S3 - S4 - S5 - S6 - S7 - S8 - S9 - S10 - S11 - R1 - R2 - R3 - R4)			
NET BUILT UP AREA		=	369.01 SQ.MT.

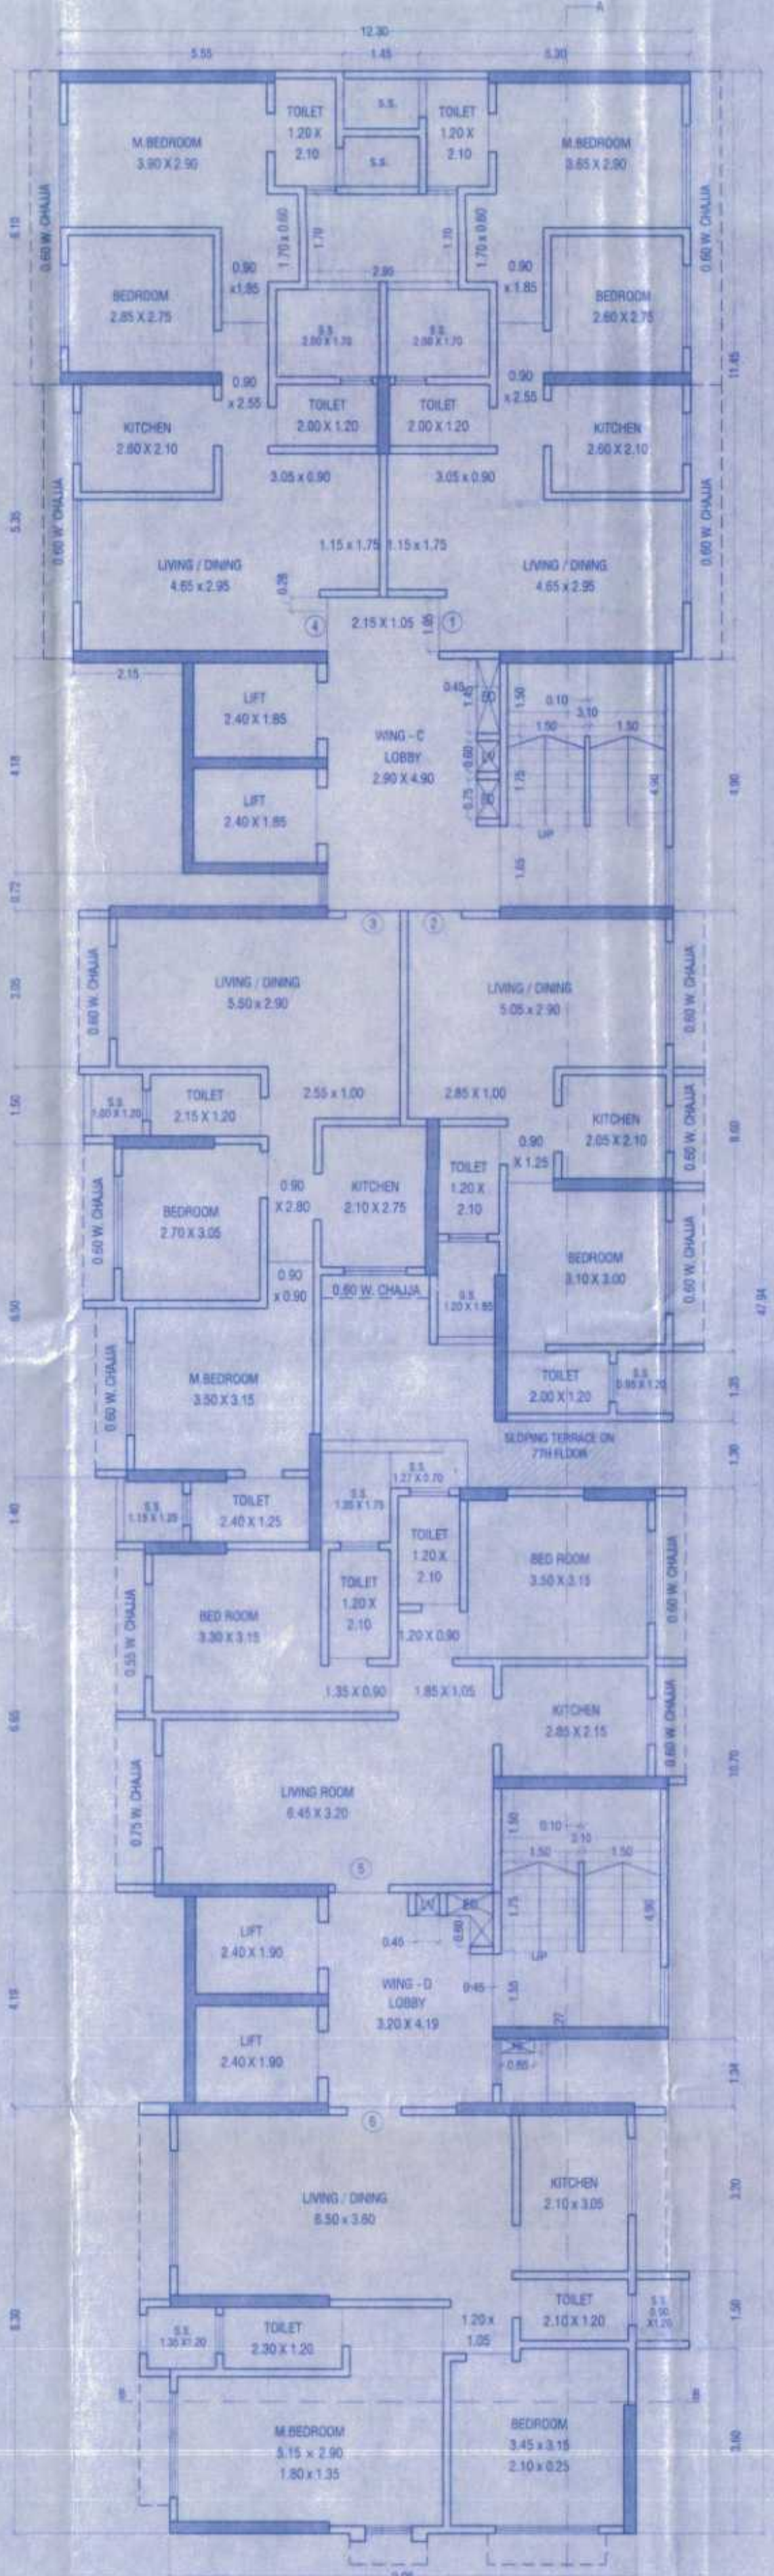

7TH, 9TH TO 14TH, 16TH TO 21ST TYPICAL FLOOR PLAN
SCALE: 1:100

7TH, 9TH TO 14TH, 16TH TO 21ST TYPICAL FLOOR AREA DIAGRAM
SCALE: 1:100

BUILT UP AREA CALCULATION			
7TH, 9TH TO 14TH, 16TH TO 21ST TYPICAL FLOOR			
A	12.30	X	47.34 X 1 NO
TOTAL ADDITION		=	582.88 SQ.MT.
DEDUCTIONS			
1	1.45	X	2.40 X 1 NO
2	2.95	X	1.85 X 1 NO
3	4.15	X	1.70 X 1 NO
4	0.35	X	14.65 X 1 NO
5	1.10	X	1.55 X 1 NO
6	1.20	X	0.85 X 1 NO
7	3.45	X	4.15 X 1 NO
8	1.35	X	1.05 X 1 NO
9	1.45	X	1.30 X 1 NO
10	0.70	X	5.80 X 1 NO
11	0.45	X	0.15 X 1 NO
12	0.45	X	4.95 X 1 NO
13	0.85	X	1.07 X 1 NO
14	3.05	X	1.34 X 1 NO
15	1.10	X	8.30 X 1 NO
16	0.90	X	1.20 X 1 NO
17	2.15	X	8.30 X 1 NO
18	0.80	X	4.15 X 1 NO
19	1.85	X	7.54 X 1 NO
20	1.80	X	4.70 X 1 NO
21	0.75	X	1.20 X 1 NO
22	1.30	X	3.30 X 1 NO
23	1.85	X	4.55 X 1 NO
24	0.35	X	1.30 X 1 NO
25	0.80	X	3.20 X 1 NO
26	3.05	X	0.75 X 1 NO
27	2.40	X	4.15 X 1 NO
28	0.25	X	5.30 X 1 NO
TOTAL DEDUCTION		=	130.11 SQ.MT.
EQ. FD AREA CALCULATION			
D1	0.45	X	3.10 X 1 NO
D2	0.85	X	0.28 X 1 NO
D3	1.05	X	0.45 X 1 NO
D4	0.45	X	1.05 X 1 NO
TOTAL DED. AREA		=	2.83 SQ.MT.
TOTAL BUILT UP AREA (A - D1 - D2 - D3 - D4)		=	454.03 SQ.MT.
STAIRCASE & LIFT AREA CALCULATION			
S1	2.85	X	4.15 X 1 NO
S2	2.35	X	3.10 X 1 NO
S3	3.50	X	1.80 X 1 NO
S4	2.15	X	1.20 X 1 NO
S5	3.40	X	4.80 X 1 NO
S6	4.50	X	2.85 X 1 NO
S7	6.15	X	1.34 X 1 NO
S8	1.35	X	2.40 X 1 NO
S9	0.40	X	1.80 X 1 NO
S10	0.25	X	2.10 X 1 NO
S11	3.40	X	2.85 X 1 NO
TOTAL STAIRCASE & LIFT AREA		=	87.00 SQ.MT.
REAR WING AREA			
R1	5.37	X	4.12 X 1 NO
R2	4.87	X	2.33 X 1 NO
R3	3.40	X	2.15 X 1 NO
R4	2.30	X	2.88 X 1 NO
REAR BUILT UP AREA		=	46.02 SQ.MT.
TOTAL BUILT UP AREA (A - D1 - D2 - D3 - D4 - S1 - S2 - S3 - S4 - S5 - S6 - S7 - S8 - S9 - S10 - S11 - R1 - R2 - R3 - R4)		=	369.01 SQ.MT.

Approved Subject to the condition
Mentioned in this office permission
Letter no. SRA/ENG/
Dt. 24 DEC 2021
Executive Engineer
Slum Rehabilitation Authority

FORM 'II'
CONTENTS OF SHEET

DESCRIPTION OF PROPOSAL & PROPERTY
Proposed Slum Rehabilitation Scheme as Joint Development of slum area & municipal tenanted buildings / chawls under the provisions of Regulation 33(10) and 33(7) of the property bearing Final Plot No.13(part) of T.P.S-III, Mathur Division, known as Rauwadi & Jansewadai, situated on J.K. Sawant Marg, Dadar(West), Mumbai-28 for Namada Sahaniwas CHS (Prop)

STAMP OF DATE OF RECEIPT OF PLANS STAMP OF DATE OF APPROVAL OF PLANS

NAME OF OWNER
M/S RENAISSANCE CONSTRUCTION (RAUWADI)

Job No. _____ Drawn by _____
Drawing No. _____ Checked by _____
Revision _____ Scale _____ As stated

NORTH
N
W E
S

NAME OF LICENSED SURVEYOR
CATAPULT
The art of transformation

Catapult Realty Consultants
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Email: info@catapultrealty.in, Web: www.catapultrealty.in