


LINE AREA DIAGRAM FOR 40TH(pt) FLOOR  
Scale 1:100

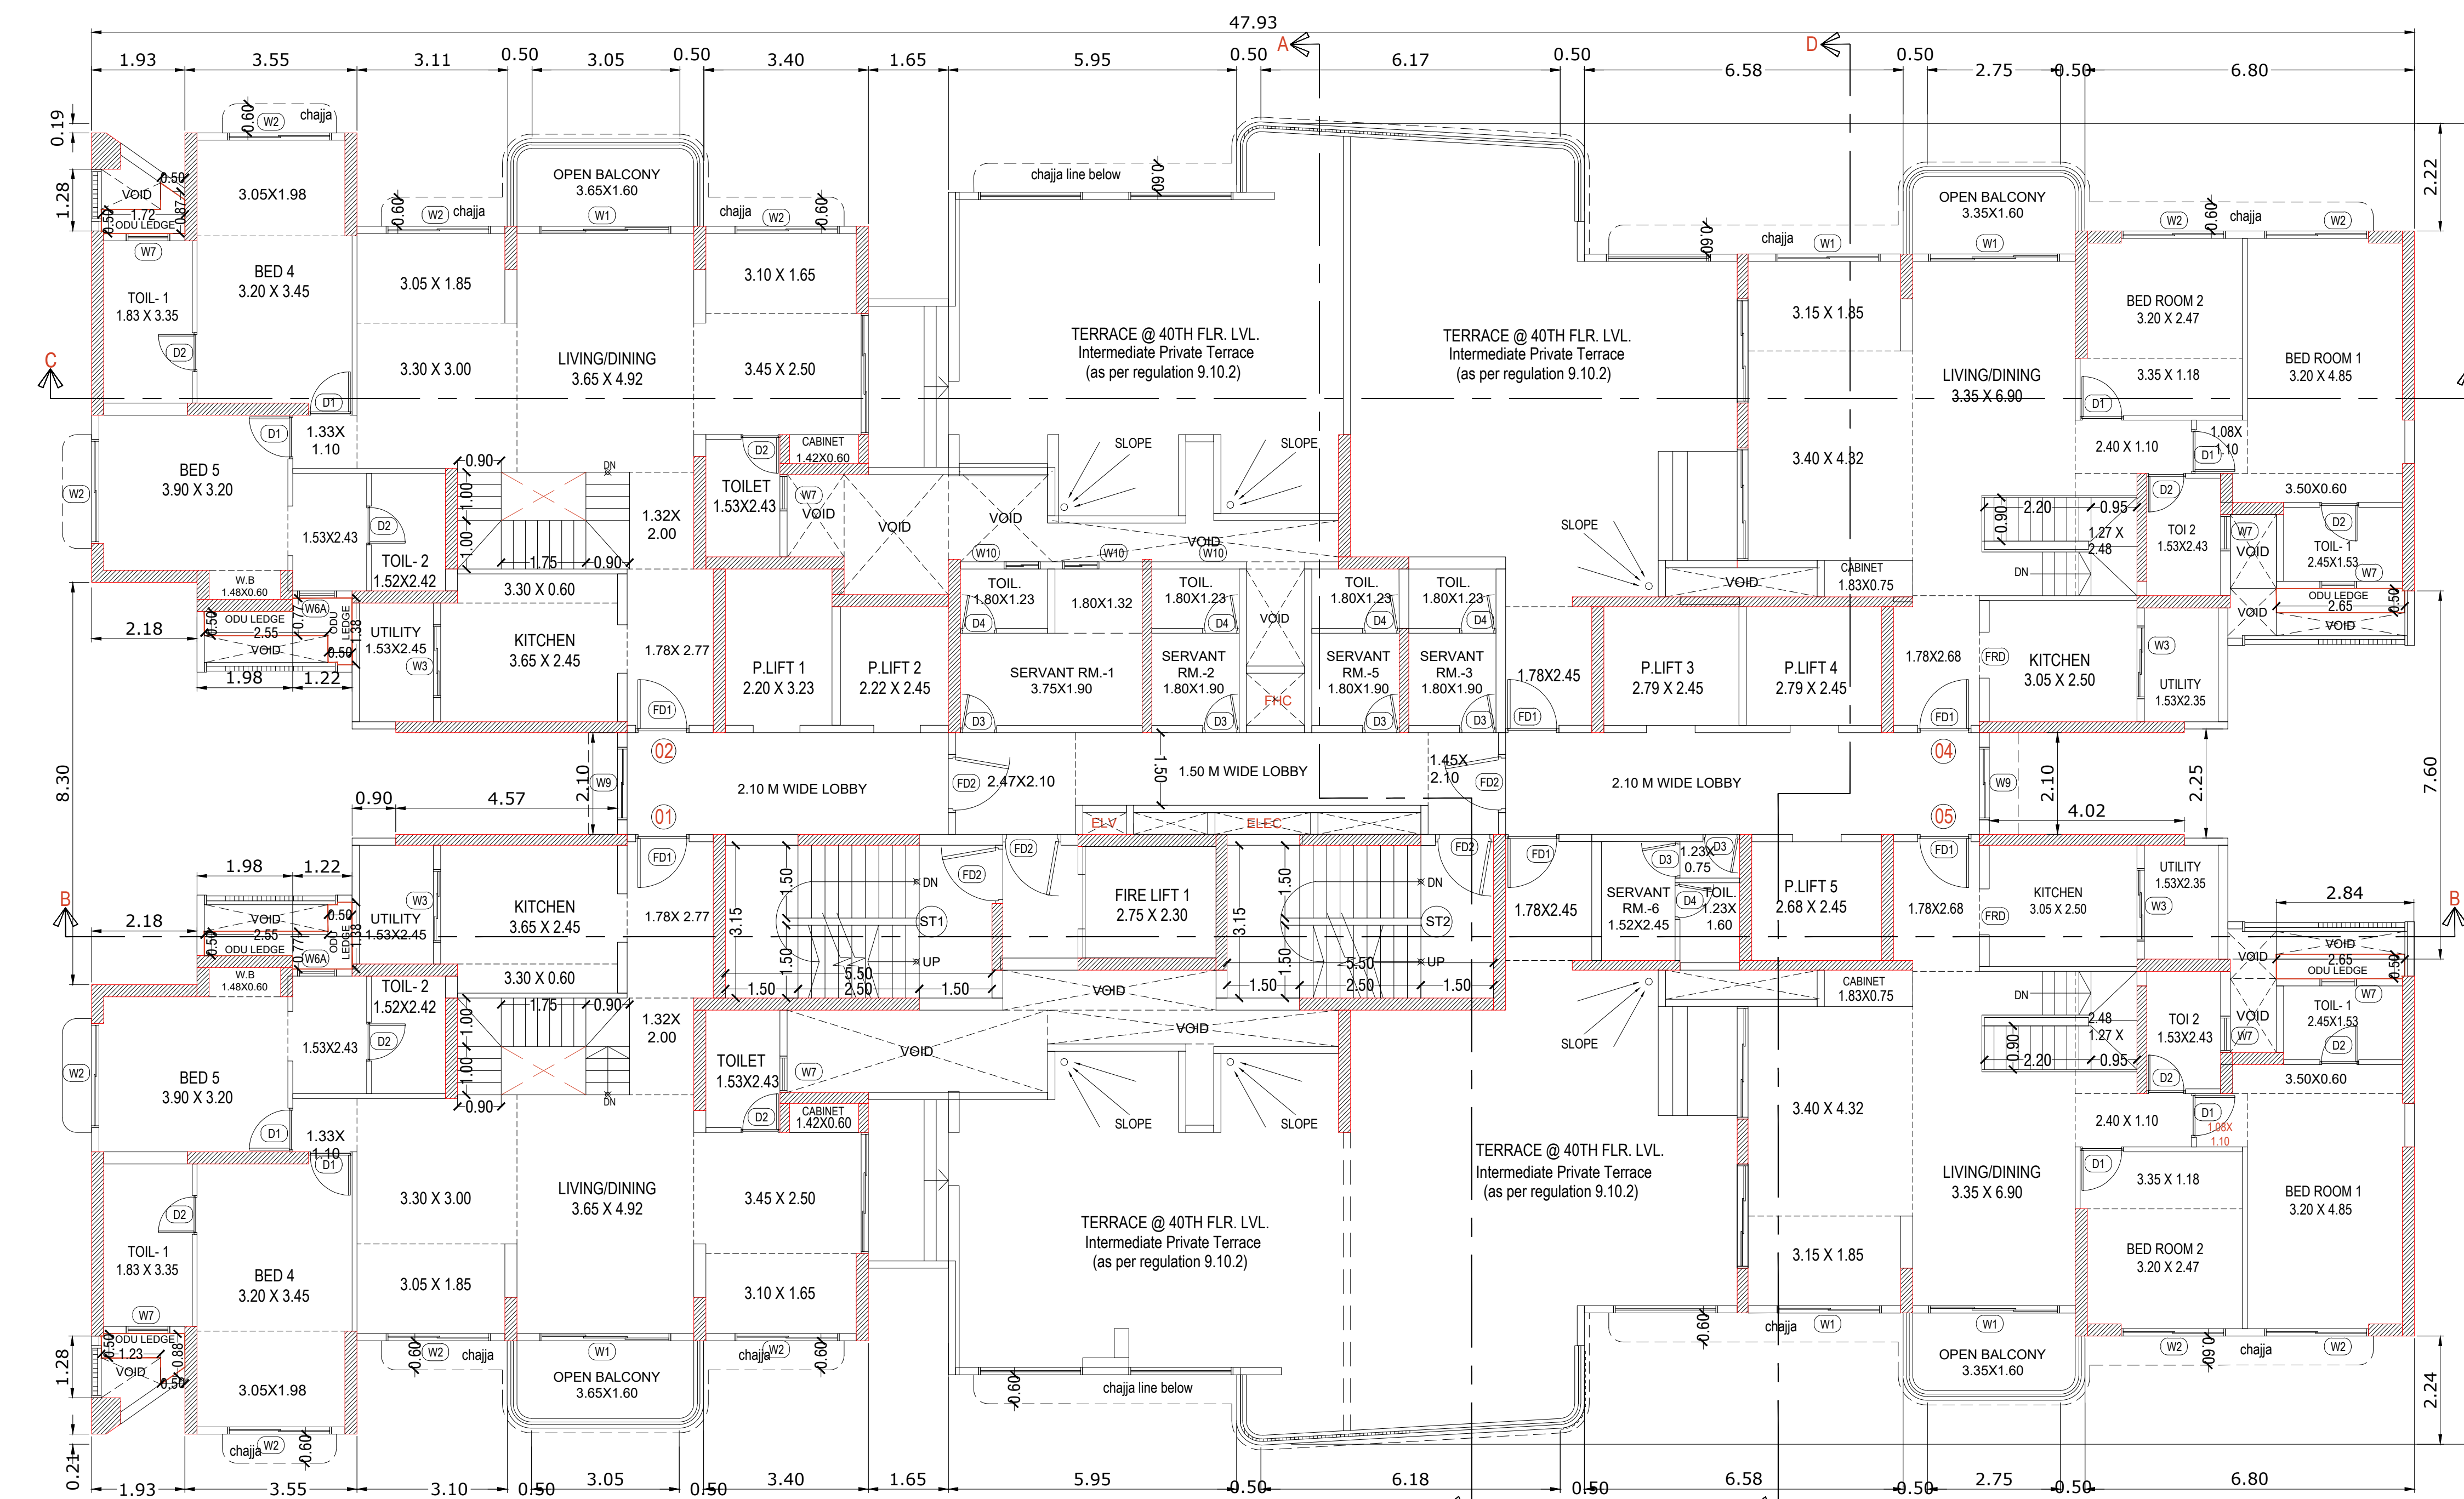

40TH(pt) FLOOR PLAN (WING-A)  
Scale - 1:100

BUILT UP AREA CALCULATION FOR 40TH(pt) FLOOR PLAN											
A	47.93	X	27.25	X	1	X	1	=	1306.09	sq.mt.	
B	0.71	X	0.35	X	0.67	X	2	=	0.37	sq.mt.	
C	0.69	X	0.34	X	0.67	X	2	=	0.33	sq.mt.	
TOTAL ADDITION (A)									=	1306.79	sq.mt.

Deduction											
1	0.25	X	1.38	X	1	X	2	=	0.64	sq.mt.	
2	1.35	X	1.38	X	1	X	2	=	3.76	sq.mt.	
3	1.33	X	0.70	X	1	X	2	=	1.86	sq.mt.	
4	1.62	X	0.76	X	0.55	X	2	=	1.23	sq.mt.	
5	1.99	X	0.94	X	1	X	2	=	3.77	sq.mt.	
6	1.93	X	0.39	X	1	X	1	=	0.37	sq.mt.	
7	3.55	X	0.39	X	1	X	1	=	0.67	sq.mt.	
8	3.10	X	2.12	X	1	X	1	=	6.57	sq.mt.	
9	0.50	X	0.57	X	1	X	2	=	0.57	sq.mt.	
10	2.05	X	0.32	X	1	X	1	=	0.66	sq.mt.	
11	3.40	X	2.12	X	1	X	1	=	7.21	sq.mt.	
12	1.45	X	2.34	X	1	X	1	=	3.40	sq.mt.	
13	3.32	X	1.70	X	1	X	1	=	5.64	sq.mt.	
14	2.15	X	0.78	X	1	X	1	=	1.68	sq.mt.	
15	0.25	X	1.75	X	1	X	1	=	0.44	sq.mt.	
16	1.80	X	0.58	X	1	X	1	=	1.06	sq.mt.	
17	2.02	X	0.80	X	1	X	1	=	1.62	sq.mt.	
18	2.43	X	0.85	X	1	X	1	=	2.07	sq.mt.	
18a	0.77	X	0.80	X	1	X	1	=	0.62	sq.mt.	
19	0.97	X	1.68	X	1	X	1	=	1.64	sq.mt.	
20	2.57	X	0.85	X	1	X	1	=	2.18	sq.mt.	
21	1.20	X	2.35	X	1	X	1	=	2.88	sq.mt.	
22	0.73	X	1.45	X	1	X	1	=	1.06	sq.mt.	
23	0.30	X	1.32	X	1	X	1	=	0.40	sq.mt.	
24	5.84	X	0.20	X	0.55	X	2	=	0.60	sq.mt.	
25	0.47	X	0.57	X	1	X	1	=	0.27	sq.mt.	
26	6.58	X	2.89	X	1	X	1	=	19.70	sq.mt.	
27	0.50	X	1.14	X	1	X	2	=	1.14	sq.mt.	
28	2.75	X	0.80	X	1	X	1	=	2.45	sq.mt.	
29	0.80	X	2.22	X	1	X	1	=	1.78	sq.mt.	
30	0.95	X	1.99	X	1	X	2	=	3.87	sq.mt.	
31	2.40	X	0.40	X	1	X	1	=	1.04	sq.mt.	
32	0.25	X	1.76	X	1	X	1	=	0.44	sq.mt.	
33	3.60	X	2.75	X	1	X	1	=	26.10	sq.mt.	
33a	0.90	X	2.25	X	1	X	1	=	2.03	sq.mt.	
34	4.02	X	2.30	X	1	X	1	=	9.44	sq.mt.	
35	2.60	X	0.40	X	1	X	1	=	1.04	sq.mt.	
36	6.80	X	2.34	X	1	X	1	=	15.73	sq.mt.	
37	0.50	X	1.16	X	1	X	2	=	1.16	sq.mt.	
38	2.75	X	0.95	X	1	X	1	=	2.60	sq.mt.	
39	6.58	X	2.71	X	1	X	1	=	17.93	sq.mt.	
40	0.47	X	0.59	X	1	X	1	=	0.28	sq.mt.	
41	5.64	X	0.85	X	0.55	X	2	=	0.93	sq.mt.	
42	0.30	X	1.34	X	1	X	1	=	0.40	sq.mt.	
43	6.71	X	1.44	X	1	X	1	=	9.69	sq.mt.	
44	1.45	X	2.26	X	1	X	1	=	3.27	sq.mt.	
45	3.32	X	1.70	X	1	X	1	=	5.64	sq.mt.	
46	2.85	X	0.75	X	1	X	1	=	2.14	sq.mt.	
47	4.40	X	0.85	X	1	X	1	=	3.65	sq.mt.	
48	2.85	X	0.75	X	1	X	1	=	2.14	sq.mt.	
49	2.42	X	0.95	X	1	X	1	=	2.30	sq.mt.	
50	0.57	X	2.38	X	1	X	1	=	1.36	sq.mt.	
51	2.38	X	0.75	X	1	X	1	=	1.79	sq.mt.	
52	3.40	X	2.15	X	1	X	1	=	2.28	sq.mt.	
53	0.50	X	0.59	X	1	X	2	=	0.59	sq.mt.	
54	3.05	X	1.94	X	1	X	1	=	5.94	sq.mt.	
55	3.10	X	2.14	X	1	X	1	=	6.63	sq.mt.	
56	3.55	X	0.21	X	1	X	1	=	0.75	sq.mt.	
57	1.93	X	0.21	X	1	X	1	=	0.41	sq.mt.	
58	2.18	X	0.30	X	1	X	1	=	0.66	sq.mt.	
59	1.98	X	1.70	X	1	X	1	=	3.37	sq.mt.	
60	1.23	X	2.70	X	1	X	1	=	3.32	sq.mt.	
61	2.13	X	2.25	X	1	X	1	=	4.79	sq.mt.	
62	1.93	X	2.70	X	1	X	1	=	5.21	sq.mt.	
63	4.57	X	2.30	X	1	X	1	=	10.50	sq.mt.	
64	1.20	X	1.07	X	1	X	1	=	1.28	sq.mt.	
65	0.90	X	0.45	X	1	X	1	=	0.41	sq.mt.	
66	5.78	X	0.45	X	1	X	1	=	2.60	sq.mt.	
67	3.18	X	0.60	X	1	X	1	=	1.91	sq.mt.	
68	3.17	X	0.40	X	1	X	1	=	1.27	sq.mt.	
69	2.20	X	2.33	X	1	X	1	=	5.13	sq.mt.	
70	2.22	X	2.45	X	1	X	1	=	5.44	sq.mt.	
71	2.79	X	2.45	X	1	X	2	=	13.67	sq.mt.	
72	2.68	X	2.45	X	1	X	1	=	6.57	sq.mt.	
73	2.75	X	2.30	X	1	X	1	=	6.33	sq.mt.	
74	3.55	X	2.00	X	1	X	2	=	14.10	sq.mt.	
75	1.25	X	1.17	X	1	X	2	=	2.93	sq.mt.	
76	1.95	X	2.08	X	1	X	2	=	8.11	sq.mt.	
Deduction area - Y									=	366.65	sq.mt.
TERRACE OPEN TO SKY @ 40TH LVL.											
77	0.25	X	0.85	X	1	X	1	=	0.21	sq.mt.	
78	0.25	X	1.38	X	1	X	1	=	0.35	sq.mt.	
79	2.42	X	0.78	X	1	X	1	=	1.89	sq.mt.	
80	0.20	X	0.63	X	1	X	1	=	0.13	sq.mt.	
81	0.57	X	1.15	X	1	X	1	=	0.66	sq.mt.	
82	1.25	X	0.78	X	1	X	1	=	0.98	sq.mt.	
83	3.45	X	0.75	X	1	X	1	=	2.59	sq.mt.	
84	1.92	X	1.57	X	1	X	1	=	3.01	sq.mt.	
85	1.38	X	1.77	X	1	X	1	=	2.44	sq.mt.	
86	1.78	X	2.45	X	1	X	1	=	4.36	sq.mt.	
87	1.47	X	0.47	X	1	X	1	=	0.69	sq.mt.	
88	8.07	X	5.50	X	1	X	1	=	44.39	sq.mt.	
89	6.40	X	1.38	X	1	X	1	=	8.83	sq.mt.	
90	0.47	X	0.75	X	1	X	1	=	0.35	sq.mt.	
91	0.69	X	0.34	X	0.67	X	1	=	0.06	sq.mt.	
92	5.63	X	1.00	X	1	X	1	=	5.63	sq.mt.	
93	5.64	X	0.35	X	0.55	X	2	=	0.90	sq.mt.	
94	3.45	X	0.75	X	1	X	1	=	2.59	sq.mt.	
95	1.93	X	1.57	X	1	X	1	=	3.03	sq.mt.	
96	1.77	X	2.45	X	1	X	1	=	4.34	sq.mt.	
97	1.37	X	1.77	X	1	X	1	=	2.42	sq.mt.	
98	1.48	X	1.47	X	1	X	1	=	2.18	sq.mt.	
99	1.68	X	1.50	X	1	X	1	=	2.52	sq.mt.	
100	6.40	X	0.97	X	1	X	1	=	6.21	sq.mt.	
101	1.25	X	0.78	X	1	X	1	=	0.98	sq.mt.	
102	0.57	X	1.15	X	1	X	1	=	0.66	sq.mt.	
103	0.20	X	0.63	X	1	X	1	=	0.13	sq.mt.	
104	2.42	X	0.78	X	1	X	1	=	1.89	sq.mt.	
105	0.23	X	0.68	X	1	X	1	=	0.16	sq.mt.	
106	2.05	X	0.85	X	1	X	1	=	1.75	sq.mt.	
107	0.69	X	0.34	X	0.67	X	1	=	0.06	sq.mt.	
108	0.47	X	0.76	X	1	X	1	=	0.36	sq.mt.	
109	5.63	X	1.00	X	1	X	1	=	5.63	sq.mt.	
110	5.64	X	0.35	X	0.55	X	2	=	0.90	sq.mt.	
Total Terrace area - Y1									=	248.71	sq.mt.
Total Terrace area - (Y + Y1)									=	616.36	sq.mt.
NET B/UP AREA (X - Y)									=	690.43	sq.mt.

Window & Door Schedule			
NO.	SIZE	NO.	SIZE
d1	1.05X2.25	w1	2.45X2.12
d2	0.90X2.25	w2a	1.21X2.12
d3	0.80X2.25	w2b	1.11X2.12
dd1	1.20X2.25	w3	0.70X1.00
dd2	0.70X2.25	w4	1.00X1.00
d4	1.80X2.25	LW1	1.50X1.25
FD1	1.20X2.25	LW2	0.60X1.25
FD2	1.21X2.25	LW3	1.00X1.25
		LW4	1.15X1.25
		LW5	2.47X1.25

**Proforma - I**

PROPOSED RESIDENTIAL/COMMERCIAL COMPLEX BEARING S.NO. - 1411/2,3, 144,145/1,2,4, 146/2,3,4, 148/1, 148/2/1, 148/3/1, 41/2, 41/4/2 AT VILLAGE - MAJWADE, THANE. Drawing Sheet no. 18/48

**CONTENTS OF SHEET**

40TH(pt) FLOOR PLAN, AREA LINE DIAGRAM, AREA CALCULATION, CARPET AREA DIAGRAM & AREA CALCULATION, DOOR & WINDOW SCHEDULE, ETC.

**BLDG. NO.-1, WING-A (AIR CONDITIONAL BUILDING)**  
**(Bs+GR.+1ST/P.1, 2ND/P.2 & 3RD/P.3 FLR.COMMERCIAL**  
**+4th/SERVICE FLR.+5TH TO 39TH & 40TH(pt) FLR. )**

**STAMPS OF APPROVAL OF PLANS**

**CERTIFICATE OF AREA**

Certified that the plot under reference was surveyed by me on \_\_\_\_\_ and the dimensions of sides etc. of plot stated on plan are as measured on site and the area so worked out tallies with the area stated in document of Ownership/ T.P. Scheme Records/ Land Records Department/City Survey records.

Signature \_\_\_\_\_  
(Name of Architect/ Licensed Engineer/ Supervisor.)

**Owner's Declaration**

I/We undersigned hereby confirm that I/We would abide by plans approved by Authority / Collector. I/We would execute the structure as per approved plans. Also I/We would execute the work under supervision of proper technical person so as to ensure the quality and safety at the work site.

M/S KOTHARI AUTO PARTS.  
Owner (s) name and signature \_\_\_\_\_

**Architect name and signature**

**PRADEEP KAMBLE & ASSOCIATES**  
B/101, 1st fl. Jakh Bautera Complex,  
Pandit Malviya Path, Ramnagar,  
Dombivli ( E ) 421 201. Tel.-2862642

Job No.	Drawing No.	Scale	Drawn by	Checked by	Registration no. of Architect
S04/0095/16		1:100			CA / 87/10471