## **PMMAHANA FSI AREA BALCONY TERRACE VENT** TOTAL Other BUILDING **FLOORS** LIFT LIFTWELL DUCT COMM. RESI. IND. **SPECIAL** MEZZ. PROP. SHAFT **Deduction FSIAREA** PROP. P M MAHANA FIRST FLOOR 0.00 56.01 0.00 0.00 0.00 8.06 0.00 0.00 0.00 0.00 0.00 0.00 56.01 P M MAHANA **GROUND FLOOR** 0.00 47.95 0.00 0.00 0.00 0.00 0.00 0.00 0.00 0.00 0.00 0.00 47.95 P M MAHANA 0.00 103.96 0.00 0.00 0.00 8.06 0.00 0.00 0.00 0.00 0.00 0.00 103.96

FSI DETAILS									
9 Index	Basic FSI (on serial no 1)	Premium FSI (on serial no 1)	TDR (on serial no 1)	Incentive FSI for green building If Applicable ( on basic FSI)	Ancillary Area 60% of (2+3+4+5)	Ancillary Area 80% of (2+3+4+5)	Total	Inclusive Housing (20%) If Applicable	Drawing Value
9.1 Permissible Index	1.10	0.50	0.40	0.00	0.00	0.00	2.00	0.00	0.00
9.2 Existing Comsumed Index	0.00	0.00	0.00	0.00	0.00	0.00	0.00	0.00	0.00
9.3 Balance Index to be Consume	1.10	0.50	0.40	0.00	0.00	0.00	0.00	0.00	0.00
9.4 Total Permissible PLine Area()	105.72	52.20	41.76	0.00	72.58	0.00	272.26	0.00	0.00
9.5 Proposed P Line Area (Should not exceed 9.4 )	104.40	0.00	16.58	0.00	0.00	0.00	120.98	0.00	103.96
9.6 Index Consumed	1.08	0.00	0.15	0.00	0.00	0.00	1.24	0.00	0.00

Carpet Area Table								
<b>Building Name</b>	Floor Name	Carpet name	Tenement No	Carpet Area	Enclosed Balcony Area	Normal Balcony Area	<b>Total Carpet Area</b>	
P M MAHANA	GROUND FLOOR	1	1	42.73	0.00	0.00	42.73	
P M MAHANA	FIRST FLOOR	2	1	42.67	0.00	0.00	42.67	

Area utilisation of Roads and Reservations								
Description of area utilisation			Area surrendered in SqM	Quatam of DR/TDR generation	Incentive, if any	Total Quatam of DR/TDR generation	Area considered for DR utilisation	Remaining area for DRC generation
Reservation type	reseravation no	Name						
-	-	9.00.m MMC PRESCRIBED ROAD	8.29	16.58	0.00	16.58	16.58	0.00


Parking Check (Table 8B)								
Building Name	шог	REQ. RATIO		NO OF TarrellArres	PRP. RATIO			
Building Name	USE	car	Scooter	NO.OF Tena/Area	car	Scooter		
P M MAHANA	Residential	0	0	2	0.00	0.00		
Total	-	-	-	-	0.00	0.00		
Visitors parking(5%)	-	-	-	-	0.00	0.00		
Total	-	-	-	-	0.00	0.00		

Parking Check As Per Multiplying Factor : 0.90								
Building Name	Requ	uired	Prop	Status				
Building Name	Car/Mini Bus	Scooter	Car/Mini Bus	Scooter	Status			
Total	0	0	0	0	OK			


SCHEDULE OF OPENING:								
BLD NAME	NAME	LENGTH	HEIGHT	NOS.				
P M MAHANA	W	1.50	1.20	9				
P M MAHANA	V	0.60	0.90	3				

SCHEDULE OF OPENING:								
BLD NAME	NAME	LENGTH	HEIGHT	NOS.				
P M MAHANA	D	1.20	2.10	1				
P M MAHANA	D2	0.75	2.10	3				
P M MAHANA	D1	0.90	2.10	5				


## BUILT-UP AREA CALCULATION GROUND FLOOR P M MAHANA

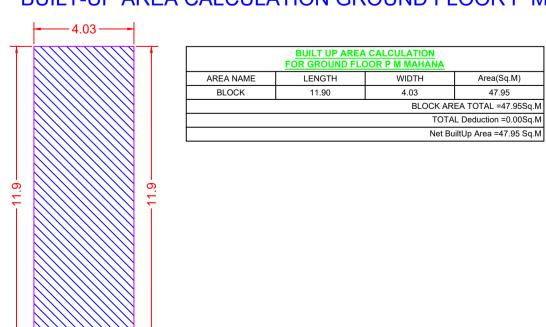


## BUILT-UP AREA CALCULATION FIRST FLOOR P M MAHANA

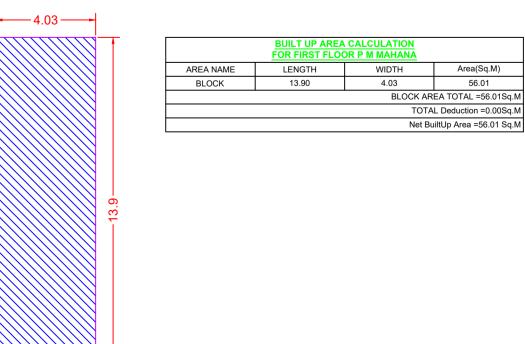


4.03

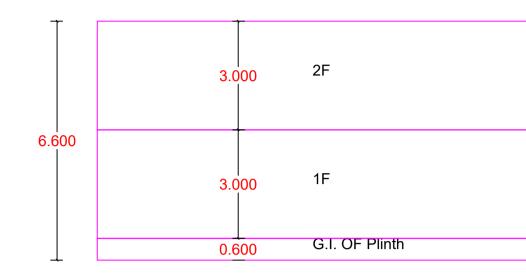


## SECTION VIEW - P M MAHANA

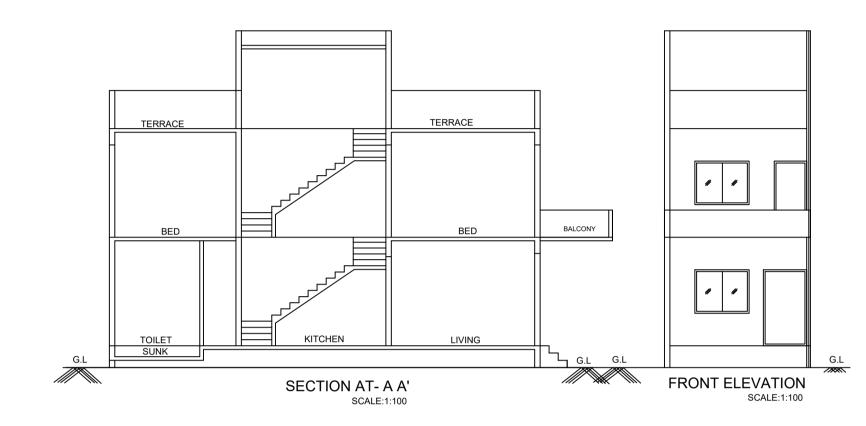

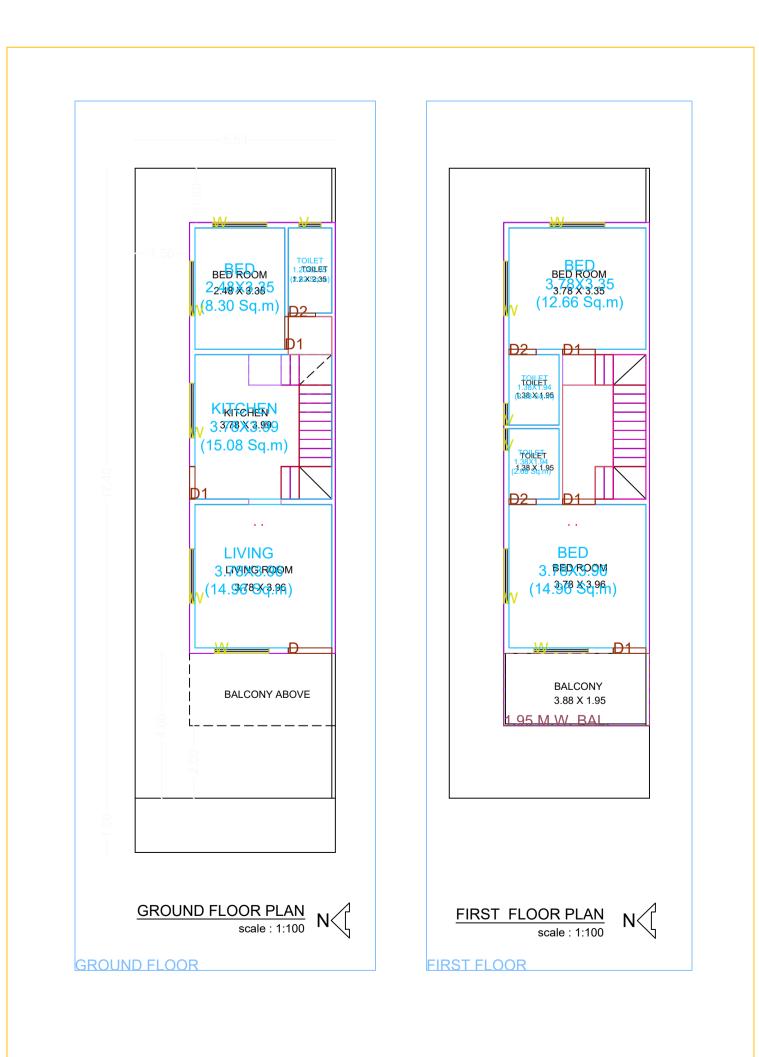

P M MAHANA

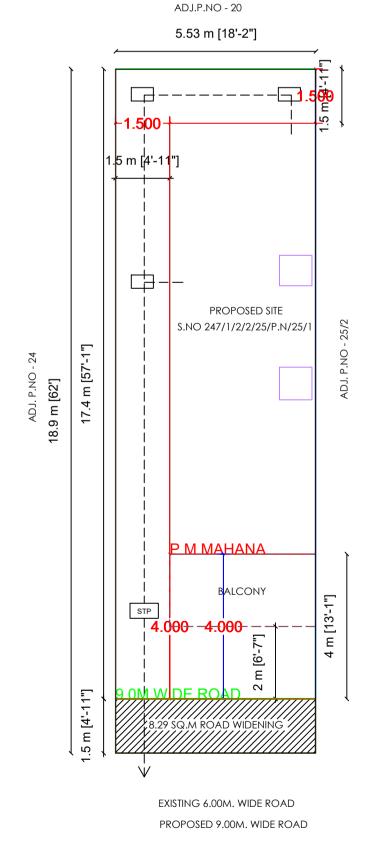

Proforma I : Area Statement 1. Area of plot (Minimum area of a, b, c to be considered) or area of subplot with sanctioned layout No. 104.40 and subplot No. (a) As per ownership document (7/12, CTS extract) (b) as per TILR or City Survey measurement sheet 104.40 (c) as per Demarcated drawing area 2.Area not in possession 3. Entire area (1-2) 4.Deductions for (a) Proposed D.P./ D.P. Road widening Area /Service Road / Highway widening
(b) Any D.P. Reservation area (Total a+b) 5.Balance area of plot (3-4) 6. Amenity Space (Applicable if (1) > 20000 sqmt (Required -(a) Upto 20000 sqmt - Nil (b) Above 20000 sqmt - (a) + 5 % of Total area . Net Plot Area (5-6) 8. Recreational Open Space (a) If area (6) is more than 4000 sqmt - 10 % of (6) is required. Proposed\_ (b) If area is less than 4000 sqmt -Check i) If it is full number like 1,2,125,419,etc. As per 7.12 abstract or City Survey Number - No Recreational open space is required recreational open space is required. (A) 10 % Subject to minimum 200 sqmt (B) Exemption to leave open space subject to availing basic F.S.I of 75 %
(C) Exemption to leave open space subject to payment of 10 % land value of land at (7) as per annual statement of rate. Certificate of Area: Certified that the plot under reference was surveyed by me on

(Name of Architect/ Licensed Engineer/ Supervisor.)

I/We undersigned hereby confirm that I/We would abide by plans approved by Authority / Collector. I/We would execute the structure as per approved plans. Also I/We would execute the work under supervision of proper technical person so as to ensure the quality and safety at the work site.

Name Of : Owner Puneet Motilal Mahana

Postal Address : SAI

Phone No.:7507144610

BUILDING ON CTS. NO./SURVEY NO.- 247

ADDRESS OF OFFICE 49B swaminarayan nager, Panchavati, Nashik 422003 /NERS SIGN -

Verified by applicant SCALE - 1:100

JOB NO - NMCB-22-83700 CHECK BY - -SUBMISSION DRAWING

Project Details

0.00

Building Type - Building Development

Zone Type - Residential Zone - (R1)

**LEGENDS:** PLOT BOUNDRY SHOWN WHITE

PROPOSED WORK SHOWN RED DRAINAGE LINE SHOWN YELLOW LIGHT

ENCLOSED BAL SHOWN BROWN TERRACE SHOWN DARK YELLOW OPEN BAL SHOWN BRAWN EXSTING SHOWN BLUE HATCHED

WATER LINE SHOWN BLUE DOTTED

Location - Non-Congested

Cts No./Servey No. - 247

Zone Number: Mhasrul

Ward No -

Plot No. - 25/1

Sheet No. - 1

Ward Name : Prorata Value :

ii) If it is subdivision like 1/2 ,2/5 , 125/1 419/1 etc.then

2022-11-09 and the dimensions of sides etc. of plot stated onplan

are as measured on site and the area so worked out tallies with the area stated in document of Ownership/ T.P. Scheme Records/Land Records Department/City Survey records.

Owner's Declaration -

Owner (s) name and signature
Architect/ Licensed Engineer/ Supervisor name and signature

TECHNICAL PERSON SIGN

Date: 11/11/22

KRUPA,,,Kokangaon,OZER(MIG),Nashik-422206,Maharashtra

**DESCRIPTION OF PROJECT:** Type of Proposal : Residential

SITE ADDRESS :

SITE PLAN
SCALE 1:100 lame Of Engineer : Mehul Ramniklal Chauhan

COMPOUND WALL

SECTION THROUGH WATER STORAGE REQUIREMENT ER HEAD WATER TANK REQUIRED 1350.00Ltr PLAN OF UNDERGROUN 1350.00 Ltr. X 1.50=2025.00 Ltr WATER STORAGE TANK
SCALE: 100 OSED-O.H.W.T = 0.00 .Ltr UGR Prop:0.00 SEPTIC TANK DETAIL