

STAMP OF AUTHORITY

APPROVED

The Plans amended in - - - .
As Per the conditions Mentioned in
the accompanying commencement
certification dated


A 3 | 172 | 2 544 | 13

17 | 09 | 2015

TRUE COPY

~~NITIN KUTE
ARCHITECT
CA/91/13816~~

Executive Engineer
TOWN PLANNING
Nashik Municipal Corporation
Nashik.

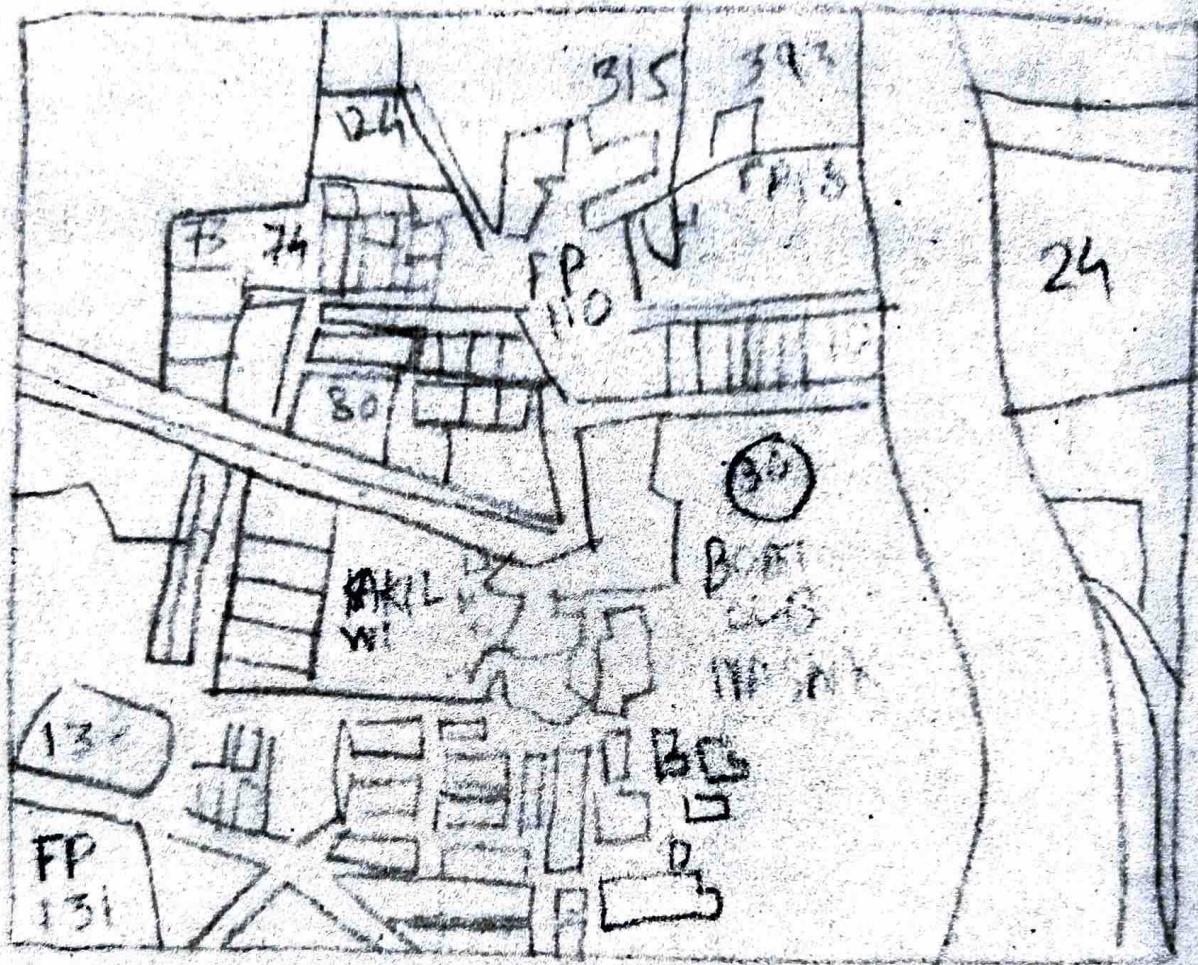

LOCATION PLAN

Scale : - 1:10000

0.12

2.75

0.12

3.65

0.15

3.65

0.12

2

[d] Total parking provided


OWNERS CONFIRMATION :

I CONFIRM THE ABOVE STATEMENT AND SHALL BE RESPONSIBLE FOR THE EXECUTION OF THE WORK AS PER SANCTIONED PLAN IN ALL RESPECTS.


SIGNATURE OF OWNER

OWNER


M/S SREE BHAI ENTERPRISES
PARTNERSHIP FIRM, NASHIK

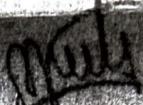ARCHITECT
Nitin Kute
Reg. No.  CA/01/13810

STRUCTURAL ENGINEER:
MR. BHORE
Reg. No.  B/1001/60

TITLE : MUNICIPAL DRAWING

PROPOSED REVISED BUILDING AND AMALGAMATION
PLAN ON PLOT NO.1&2, F.P.NO.119, S.NO.669, H.
NO.3, TPSI AT NASHIK

NOTE :
UNLESS OTHERWISE SPECIFIED, DIMENSIONS ARE IN METRES
WRITTEN DIMENSIONS TO BE FOLLOWED RATHER THAN SCALING THE DRAWING

DRAWN BY HARSHAD DWG. NO. 01

CHKD. BY AR NITIN KUTE SHT. NO. 01/02

DATE 28 - 02 - 13 SCALE : 1:100.

FILE PATH:-

ORIGIN ARCHITECTS

55, ADIMAI, SECTOR B,
NEAR NAVASHYA GANPATI,
OFF GANGAPUR RD., NASHIK.
PH.NO. 0253 2340828

PROFORMA I**A. AREA STATEMENT**

1. AREA OF PLOT (1+2) (AS PER 7/12 EXTRACT)	3977.99 SQ.M.
2. DEDUCTION FOR :	
[a] Road acquisition area	248 SQ.M.
[b] Proposed road	-
[c] MSEB	NIL
Total (a+b+c)	248 SQ.M.
3. Net gross area of plot (1-2) (as on site)	3729.99 SQ.M.
4. Deduction for :	
[a] Recreation ground as per rule no. 11.3.1	NIL
[b] Internal roads total (a+b)	NIL
5. Net area of plot (3-4)	3729.99 SQ.M.
6. Addition for F.S.I. (40 % T.D.R.)	NIL
6. Addition for F.S.I. (ROAD WIDENING)	248 SQ.M.
7. Total area (5+6)	3977.99 SQ.M.
8. Total F.S.I permissible	2
9. Permissible Total floor area (7x8)	7955.98 SQ.M.
10. Existing floor area	4475.71 SQ.M.
11. Proposed area	3192.97 SQ.M.
12. Excess balcony area taken in total floor area : calculation (as per B(c) below)	205.34 SQ.M.
13. Total built-up area proposed (10+11+12)	7874.02 SQ.M.
14. Total built-up area consumed(13/9)	0.98

B. BALCONY AREA STATEMENT (SHOWN IN BAL. STATEMENT)

[a] Permissible balcony area per floor	AS SHOWN
[b] Proposed balcony area per floor	AS SHOWN
[c] Excess balcony area (total)	AS SHOWN

C. TENEMENT STATEMENT

[a] Net area of plot item (7) above	-
[b] Less : deduction of non-residential area (shops etc.)	-
[c] Area of tenements (a-b)	-
[d] Tenements permissible (as per 60/ 80/100 per acre) 150/220/330 per Ha.	-
[e] Tenements proposed	-

D. PARKING STATEMENT

[a] Parking required by rule	REFER TABLE
[b] Garages permissible	-
[c] Garages proposed	-
[d] Total parking provided	-





Nashik

SCHEDULE FOR DOORS/WINDOWS

TYPE	SIZE	DESCRIPTION
FD	2450X2400	T.W FRAME FOLDING DOOR
FD1	2000X2400	T.W FRAME FOLDING DOOR
D	900X2400	T.W FRAME DOOR
D1	750X2400	T.W FRAME DOOR
W	2000X1500	M.S FRAME WINDOW
W1	1800X1500	M.S FRAME WINDOW
W2	1400X1300	M.S FRAME WINDOW
W3	900X1500	M.S FRAME WINDOW
W4	1200X1500	M.S FRAME WINDOW
W5	1900X1500	M.S FRAME WINDOW
W6	1500X1500	M.S FRAME WINDOW
W7	1050X1300	M.S FRAME WINDOW
V	600X600	M.S LOUVRED VENTILATOR

PROFORMA I

A AREA STATEMENT

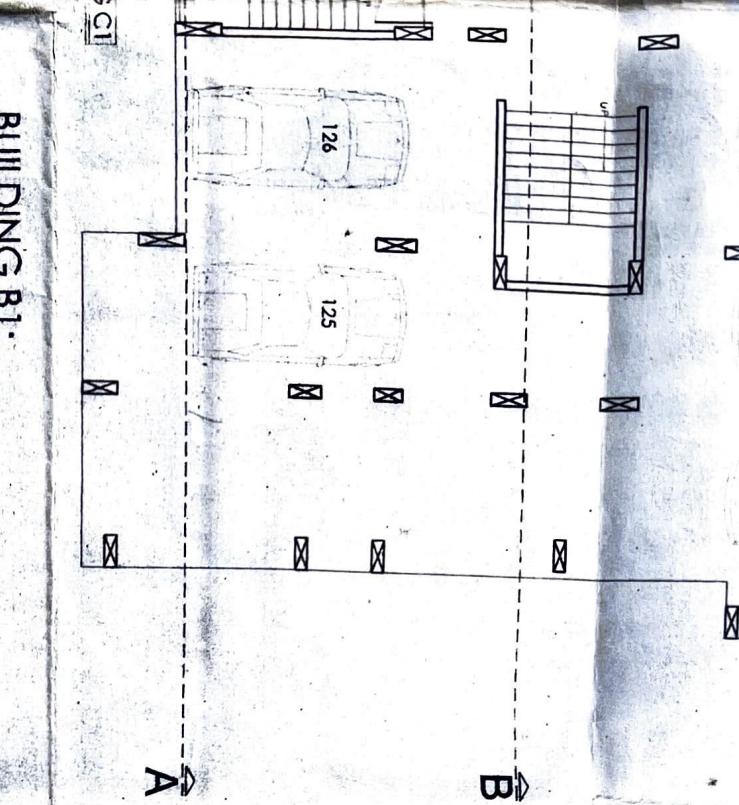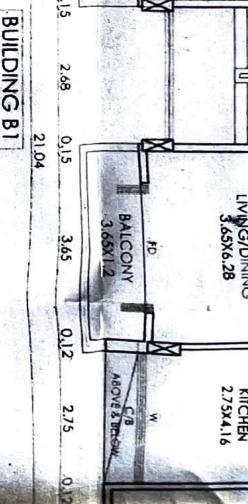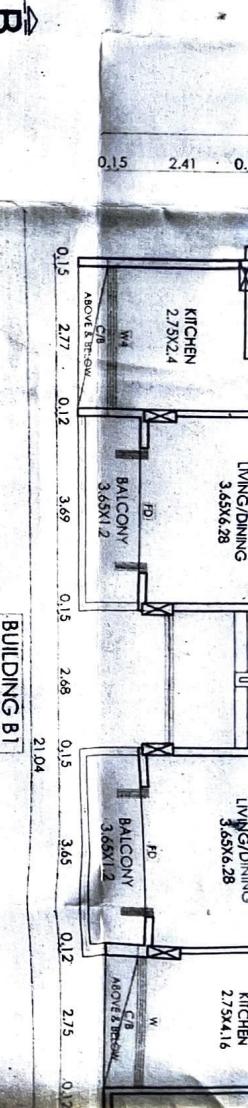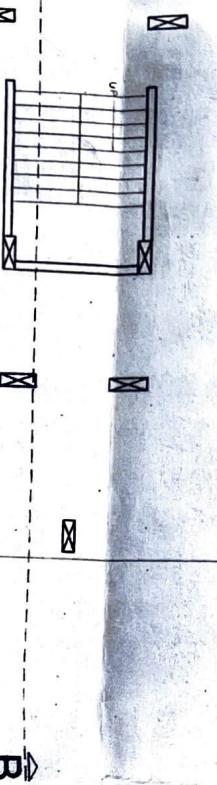

0.12
2.75
0.12
2.25
0.15

BUILDING B1

= 68.20 SQ.M.

BUILDING C1

$$\text{AREA OF BLOCK} = 20.84 \times 16.47 \\ = 343.23 \text{ SQ.M.}$$

AREA DEDUCTIONS:-

$$\begin{aligned} A &= 14.11 \times 2.51 = 35.42 \\ B &= 2.68 \times 6.58 = 17.63 \\ C &= 10.10 \times 0.70 = 7.07 \\ D &= 2.77 \times 0.60 = 1.72 \\ E &= 3.66 \times 0.10 = 0.37 \\ F &= 0.92 \times 3.20 = 2.94 \\ G &= 2.90 \times 0.60 = 1.74 \\ H &= 2.87 \times 0.60 = 1.72 \\ I &= 0.92 \times 3.20 = 2.94 \\ J &= 1.07 \times 1.31 = 1.40 \\ K &= 0.39 \times 3.95 = 1.54 \\ L &= 0.92 \times 3.45 = 3.17 \\ M &= 0.75 \times 6.40 = 4.80 \\ N &= 0.75 \times 6.51 = 4.88 \\ O &= 0.1 \times 1.70 = 0.17 \end{aligned}$$

TOTAL DEDUCTIONS :-

$$= A + B + C + D + E + F + G + H + I + J + K + L$$



$$+ M + N + O = 87.45 \text{ SQ.M.}$$


NET AREA OF BLOCK A -

$$= 343.23 - 87.45$$

$$= 255.78 \text{ SQ.M.}$$

BUILDING C1

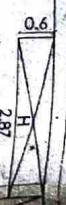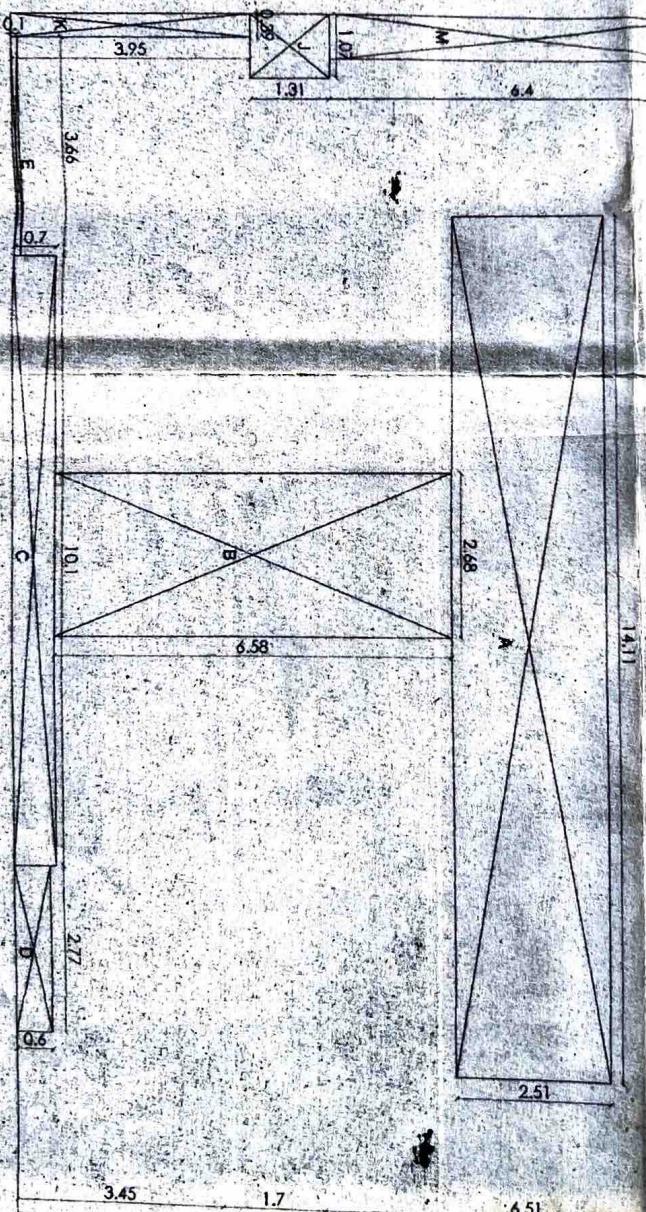


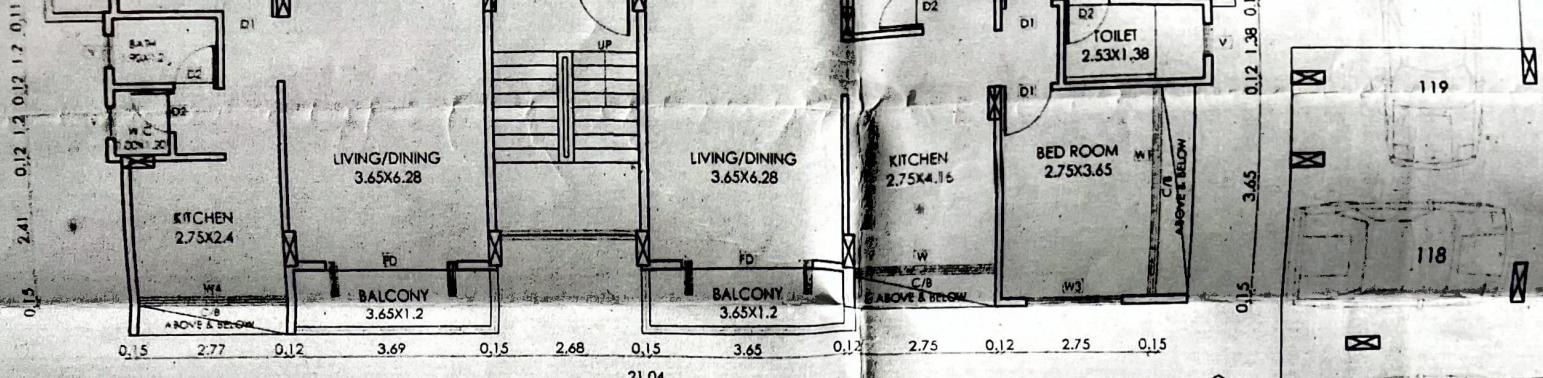

BUILDING B1


1ST, 3RD, 4TH, 5TH & 6TH FLOOR PLAN

PREVIOUS COMMENCEMENT CERTIFICATE NO.
A2/57/11 DATED 20/05/11

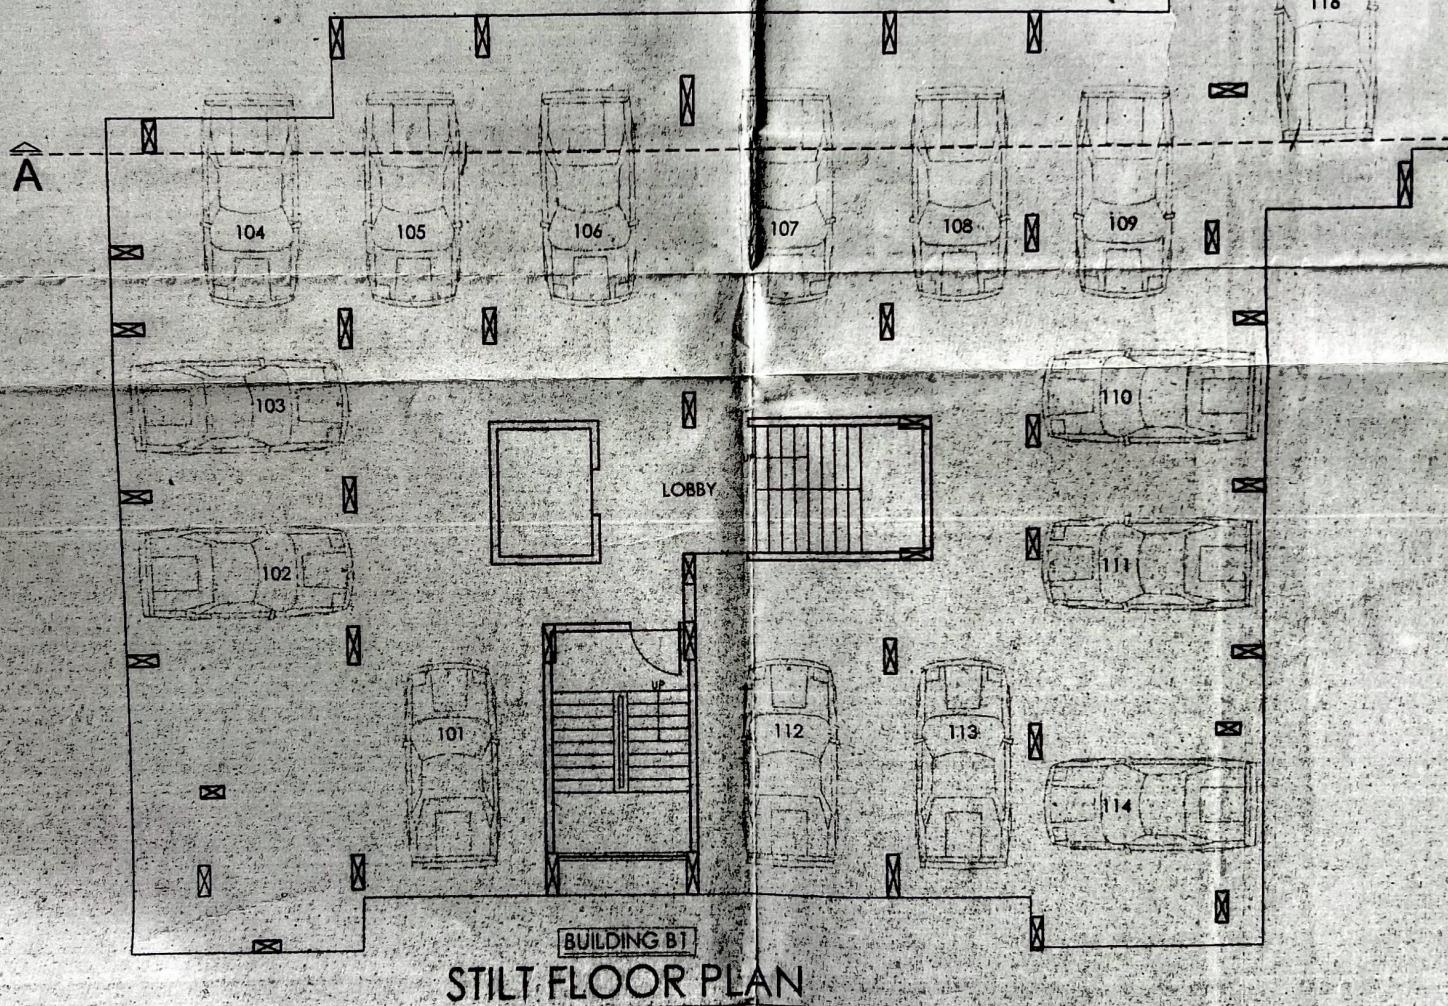


BUILDING B1

STILT FLOOR PLAN

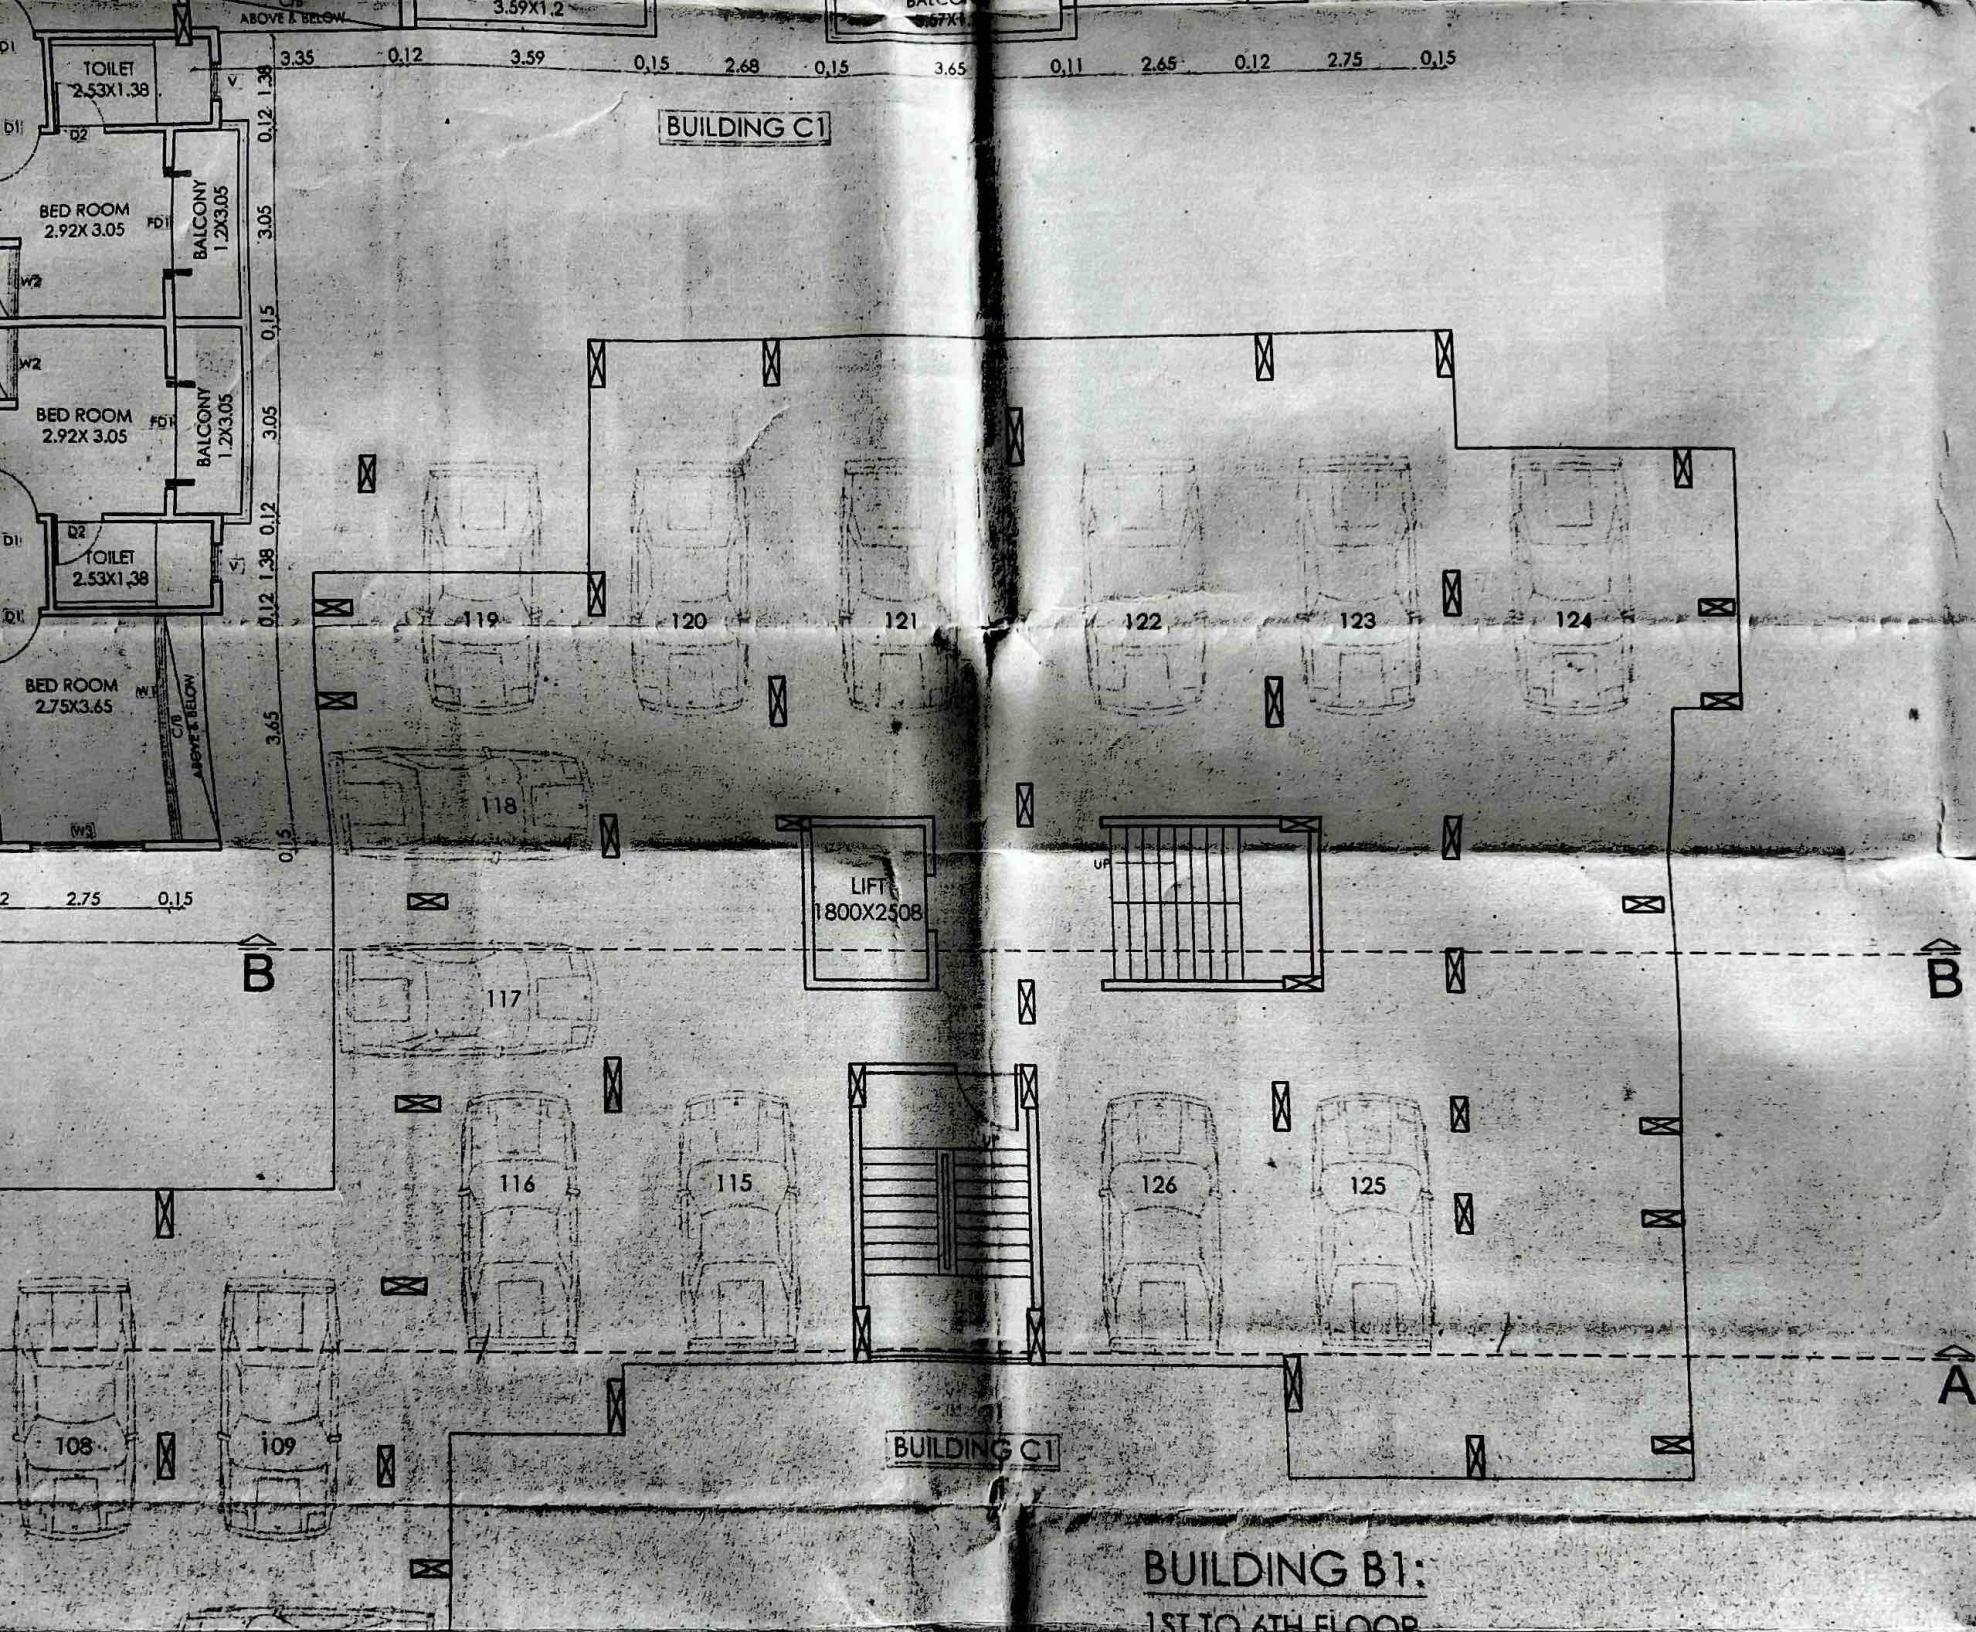





BUILDING B1
1ST TO 6TH FLOOR

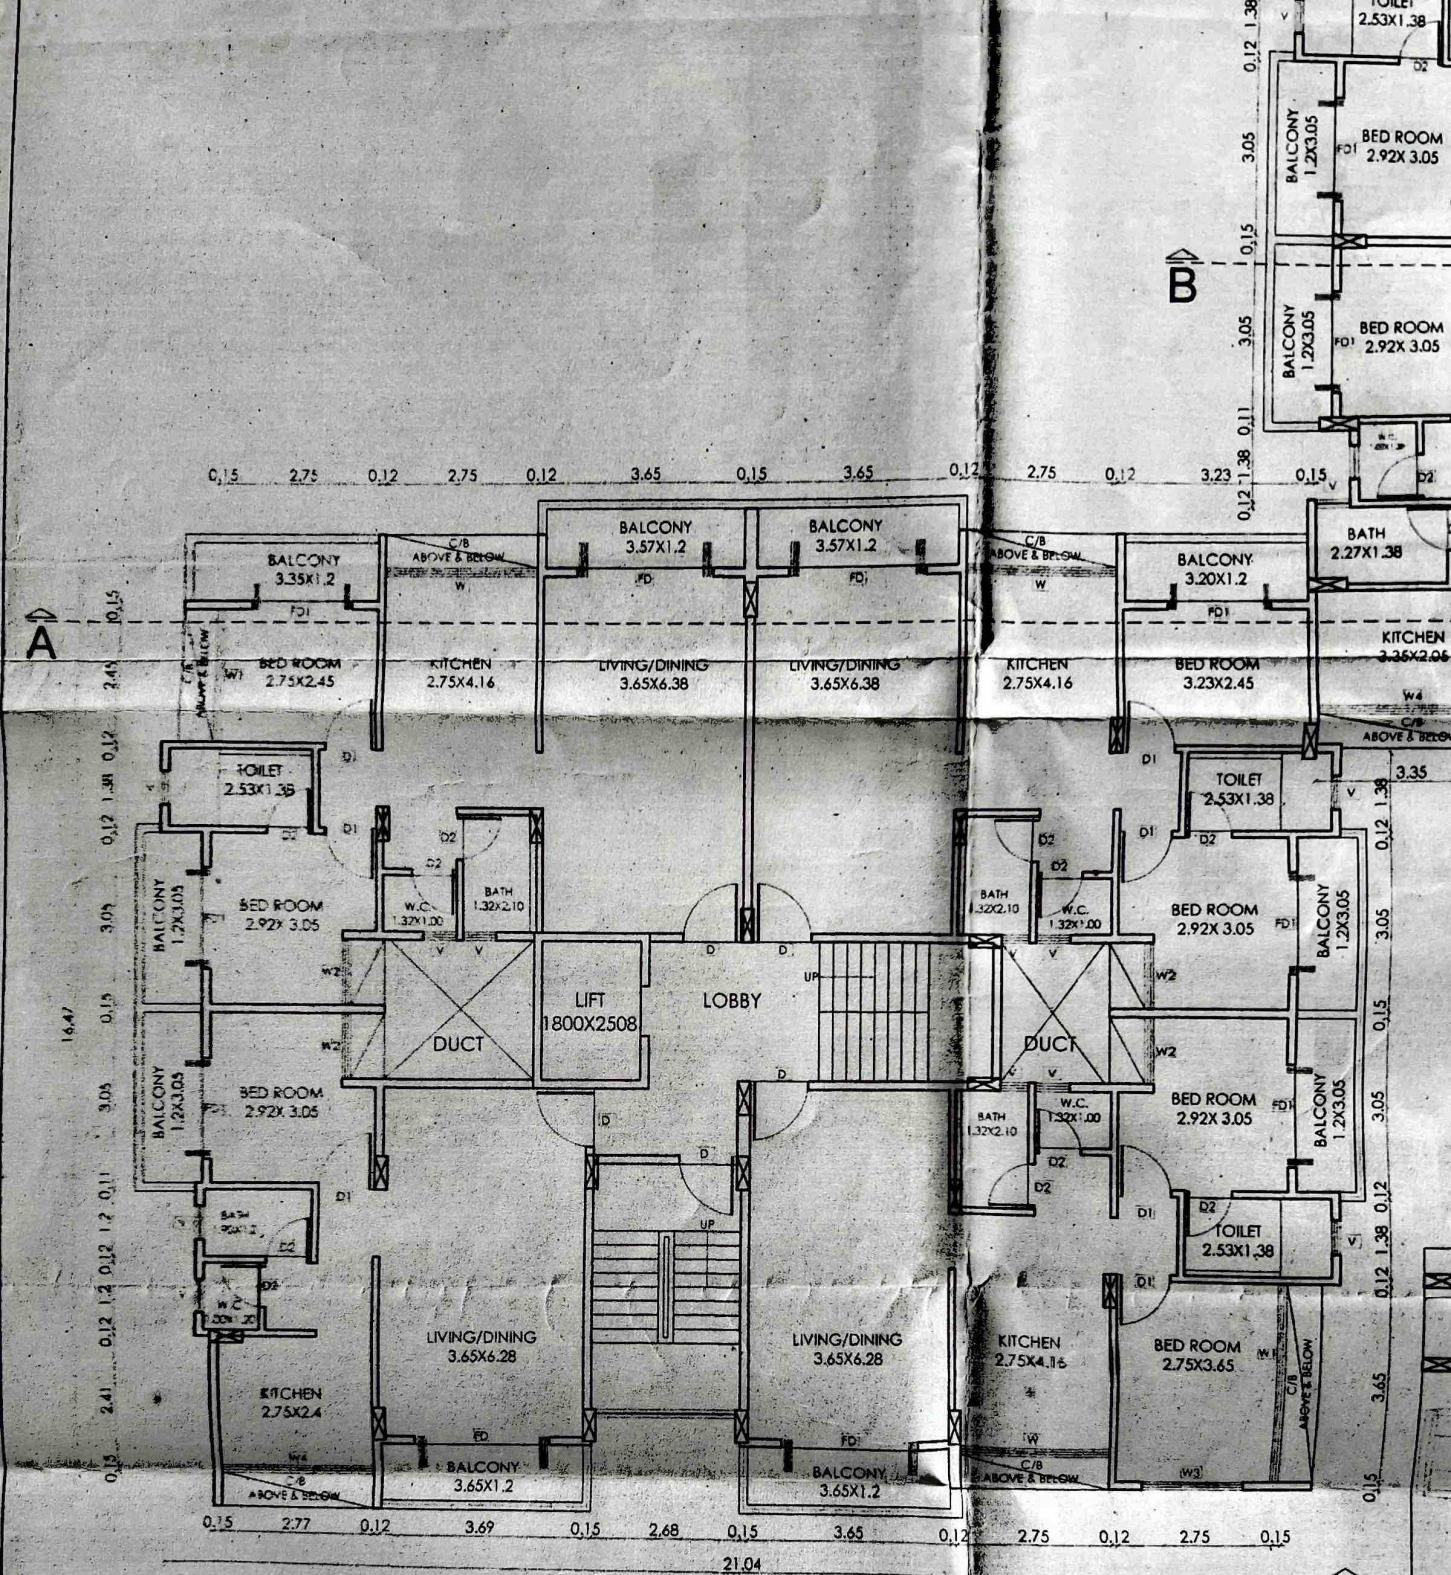


1ST, 3RD, 4TH, 5TH & 6TH FLOOR PLAN


PREVIOUS COMMENCEMENT CERTIFICATE NO.
A2/57/11 DATED 20/05/11

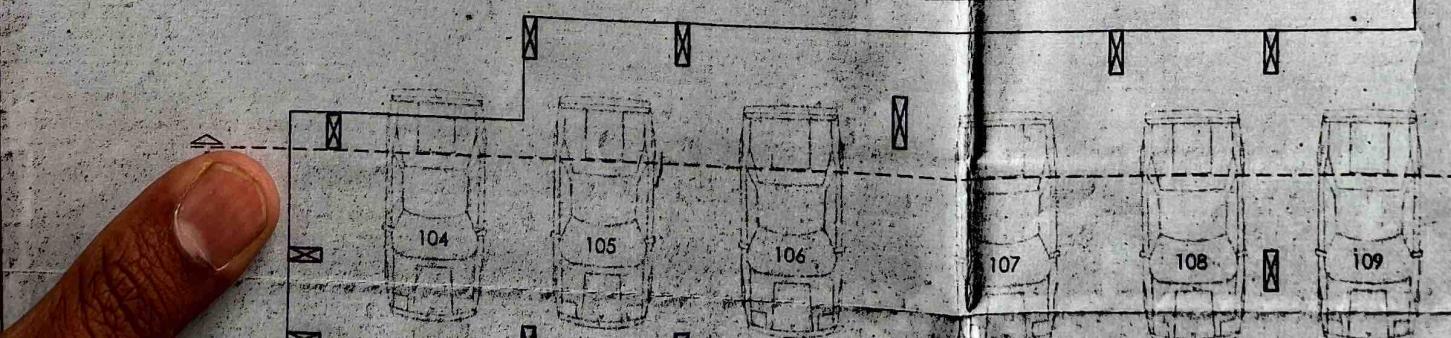

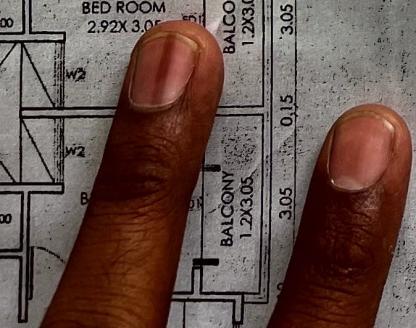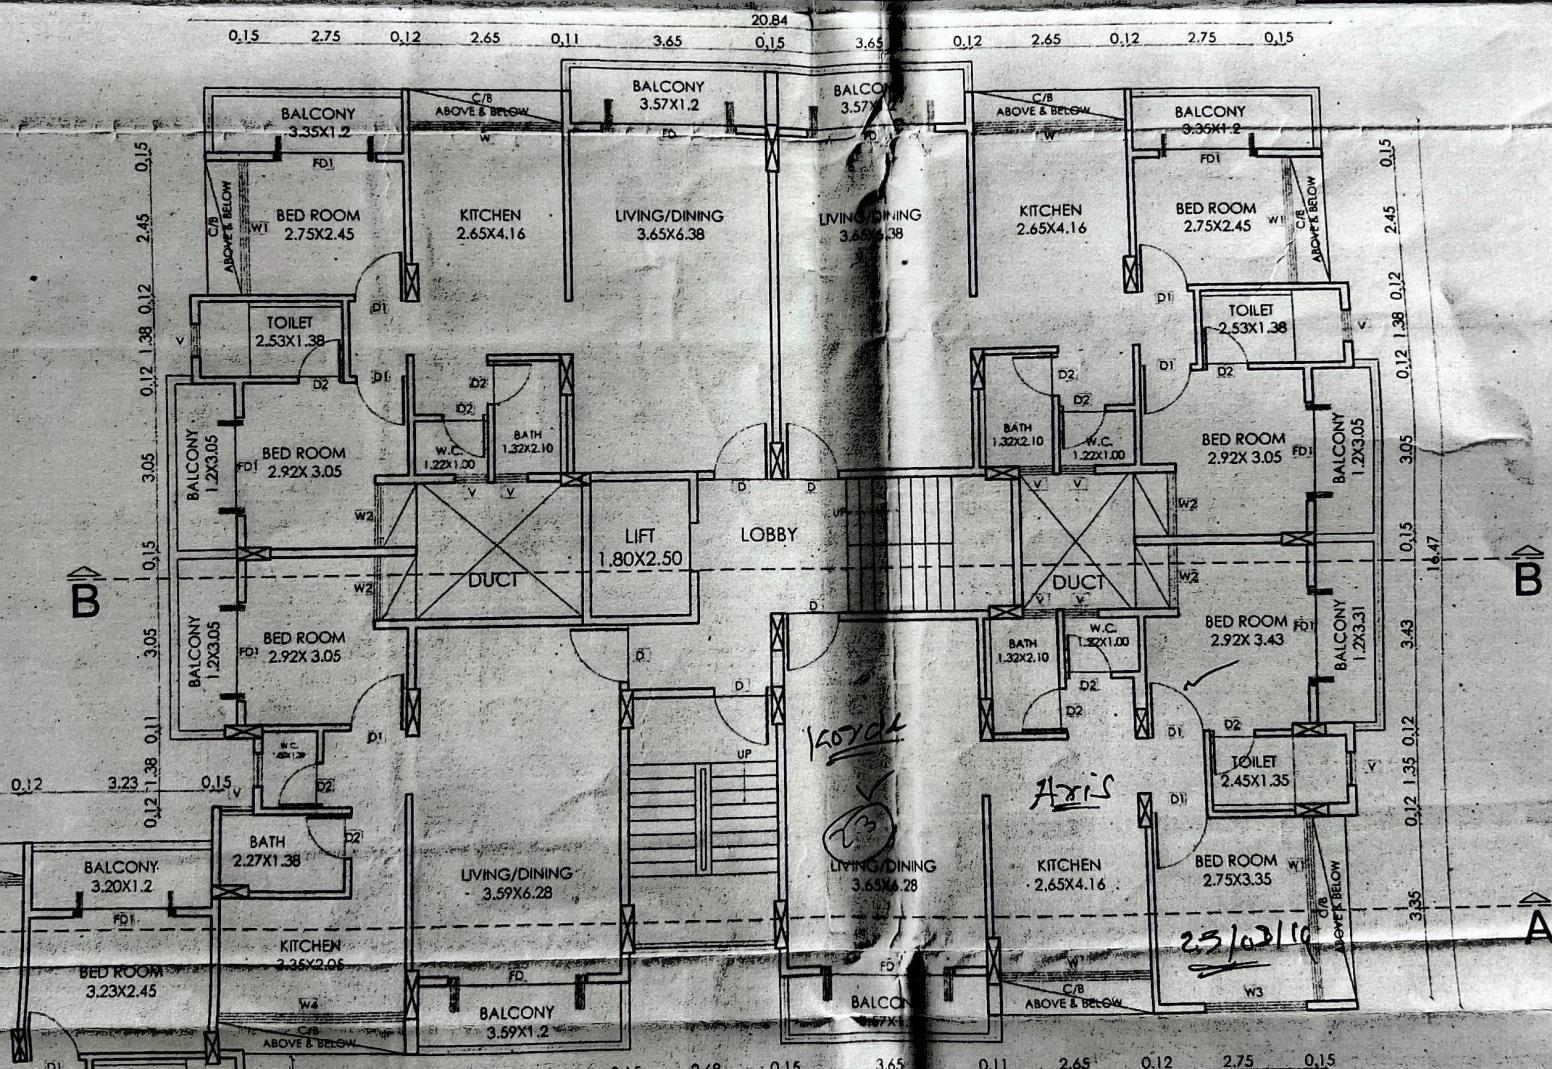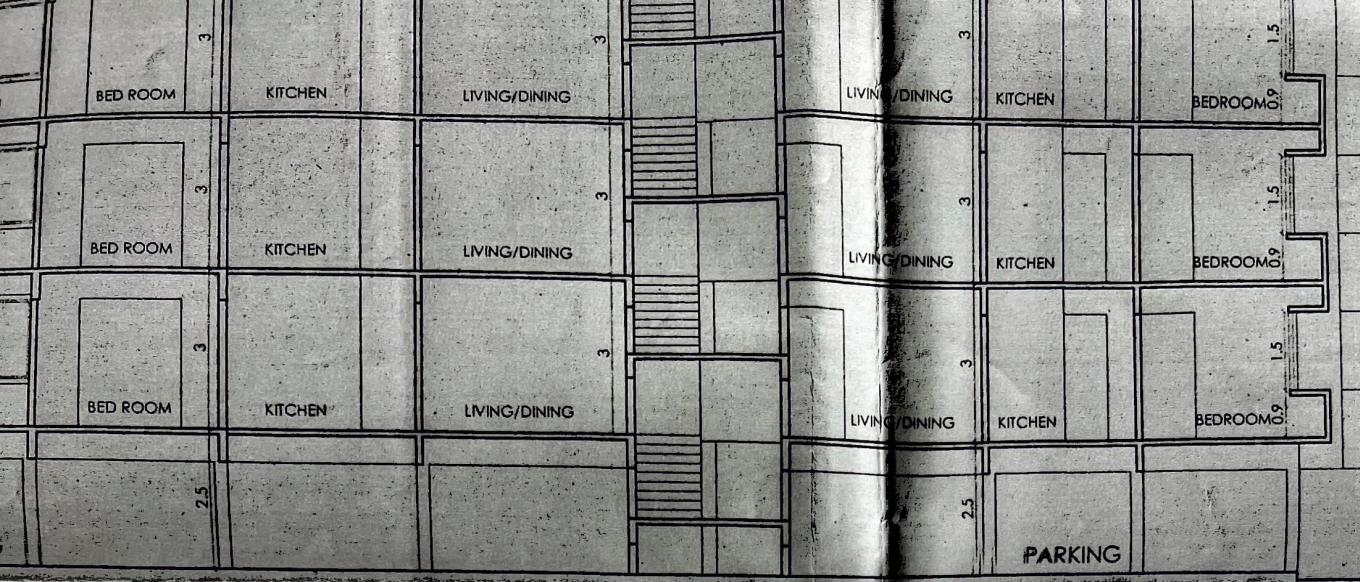


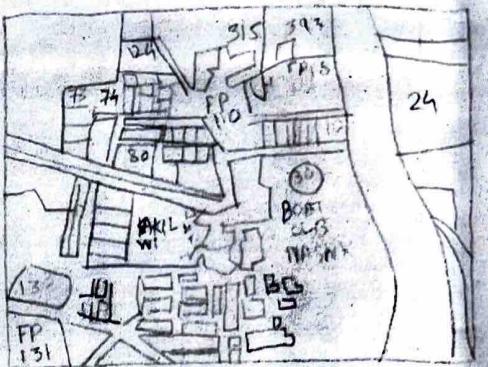

LOCATION PLAN
Scale :- 1:10000

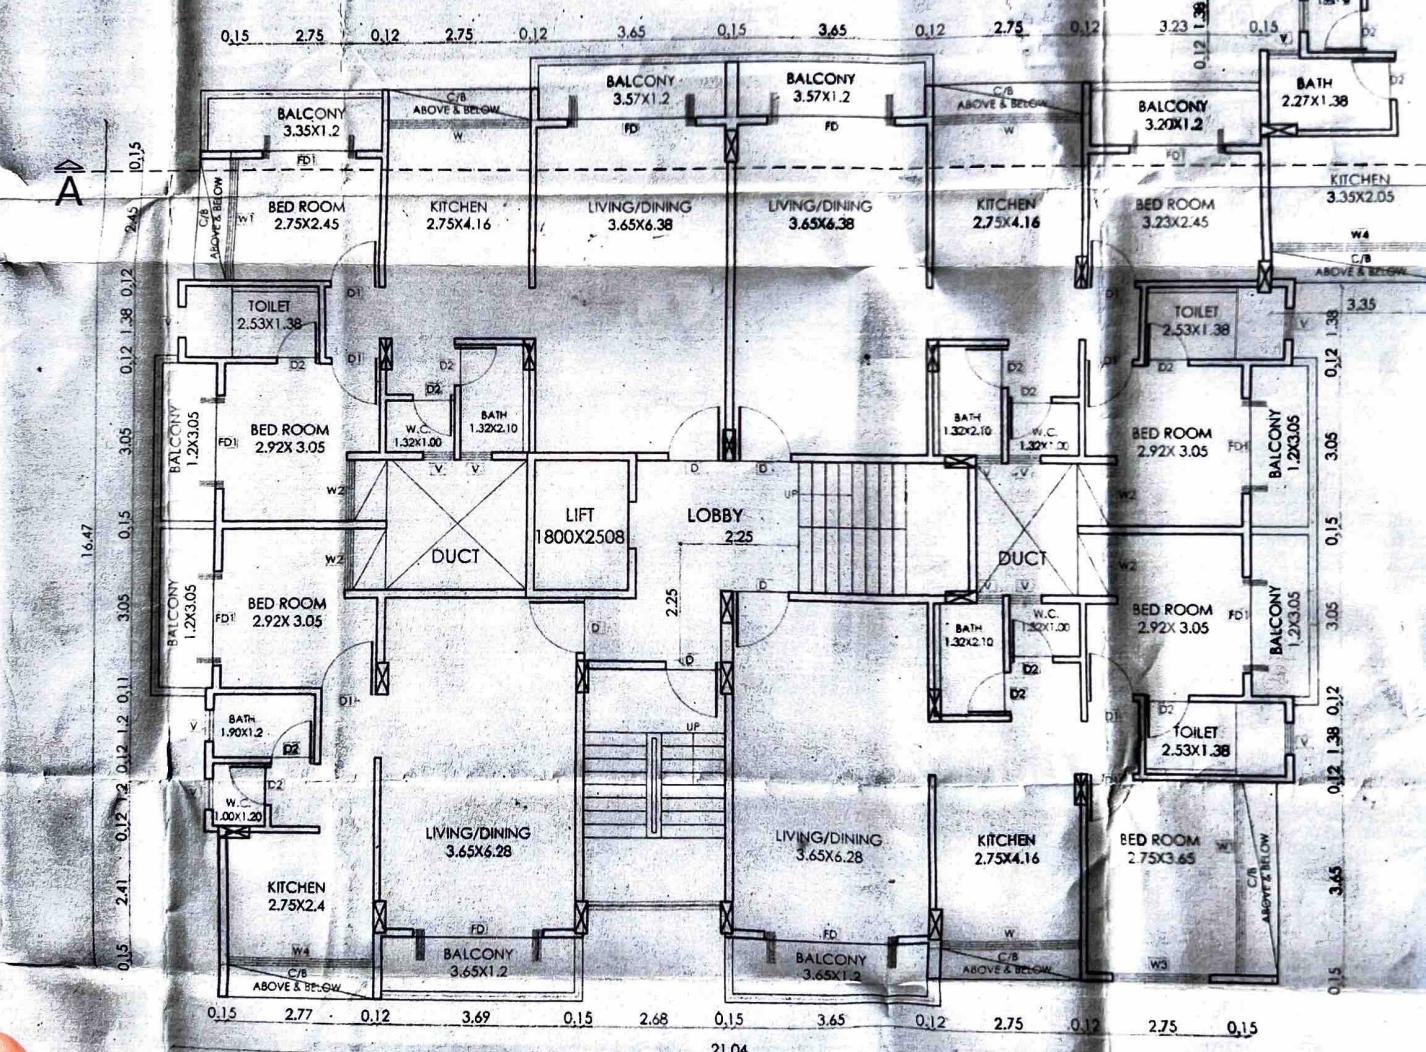


2ND FLOOR PLAN

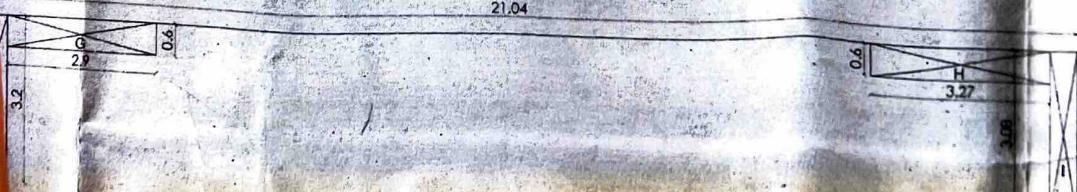

BUILDING C1


AREA OF BLOCK =

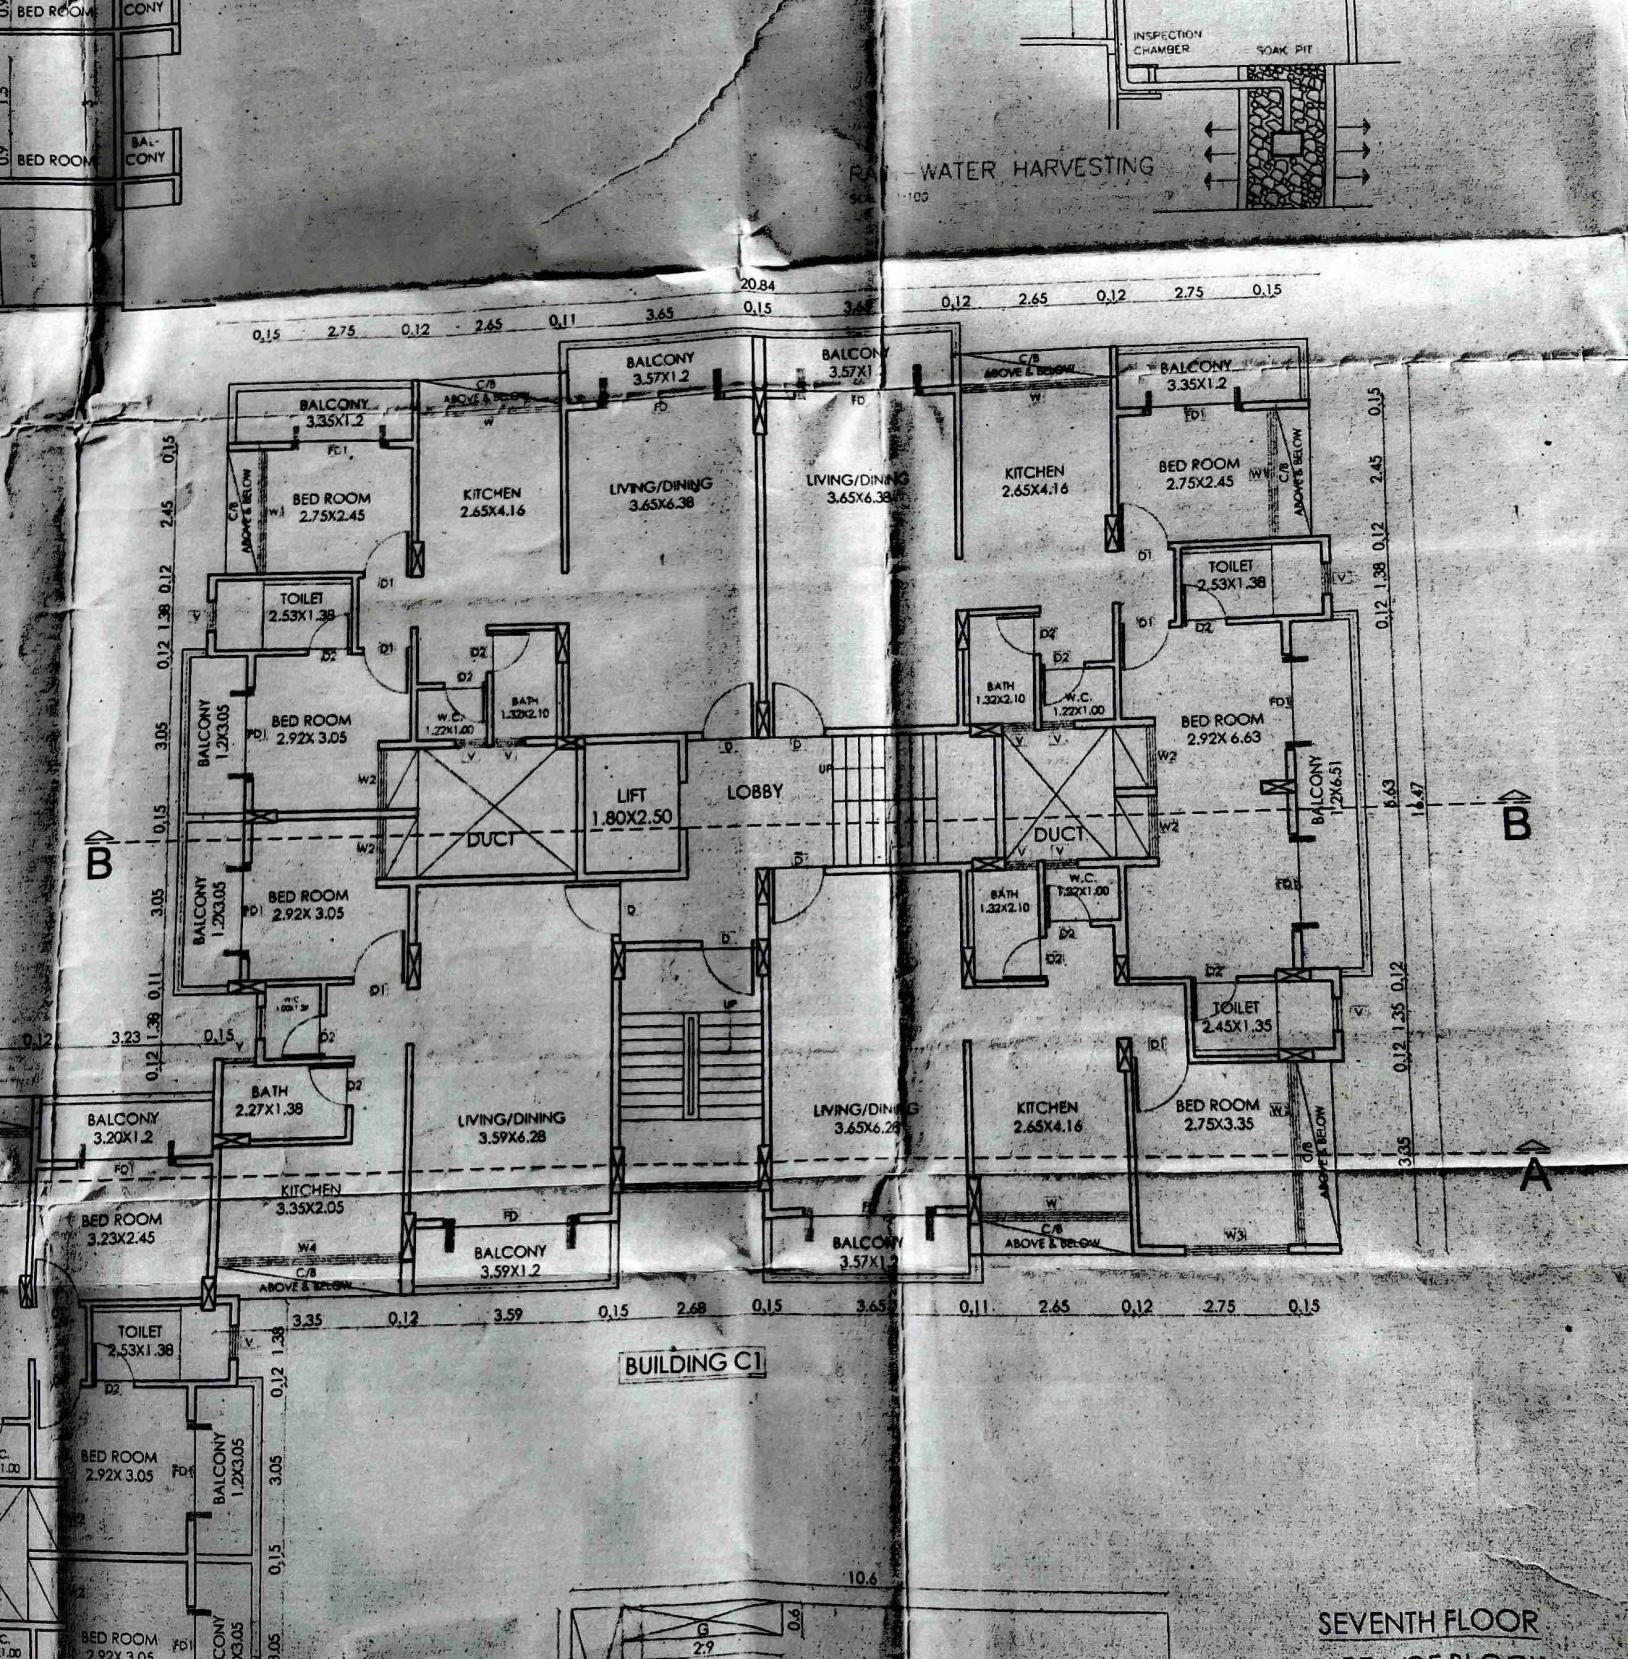

23.65

21



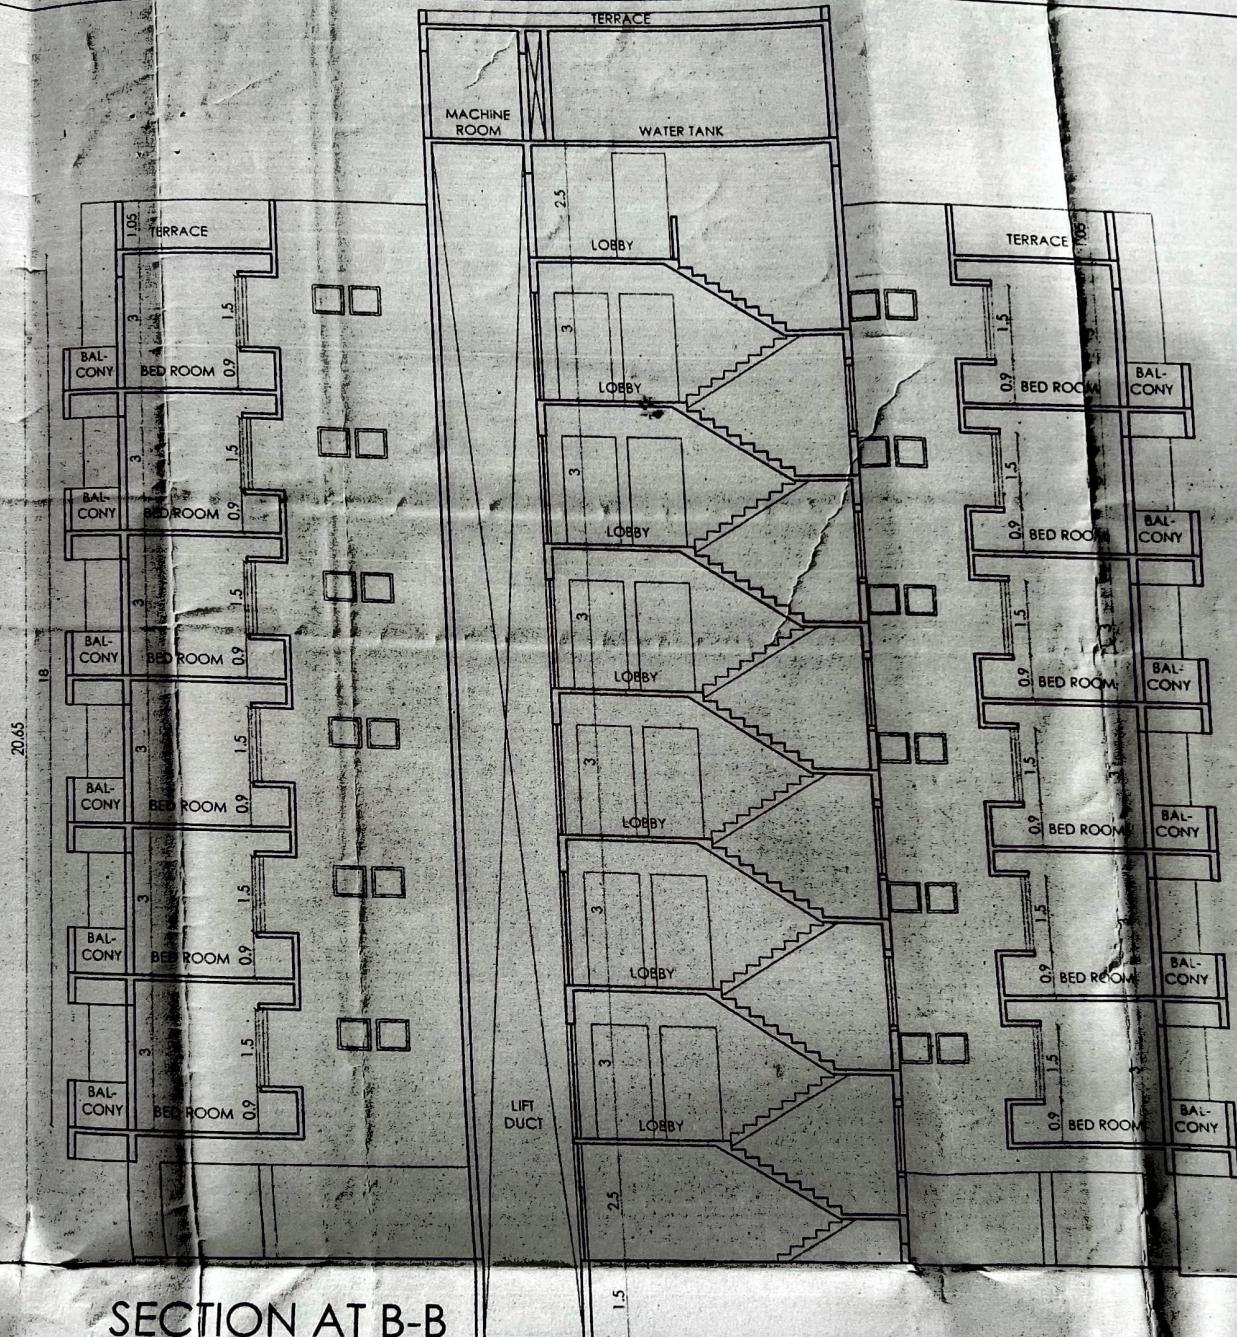

0.15

0.15
BELOW

0.15