

AREA OF BLOCKS

AREA OF BLOCK A 4.85 X 9.74 = 44.12 SQM
 AREA OF BLOCK B 4.03 X 7.05 = 28.44 SQM
 TOTAL 72.56 SQM


NET BUILT UP AREA
 A 320.74 + 320.76 + 44.32 = 685.82 SQM
 B 320.74 + 320.76 + 44.32 = 685.82 SQM
 TOTAL 1371.64 SQM

AREA OF BLOCK A 4.85 X 9.74 = 44.12 SQM
 AREA OF BLOCK B 4.03 X 7.05 = 28.44 SQM
 TOTAL 72.56 SQM


HOLEY COMB
 BRICK MASONRY

APPROVING AUTHORITY

Approved Authority
 Municipal Engineer
 Municipal Engineer
 Municipal Engineer

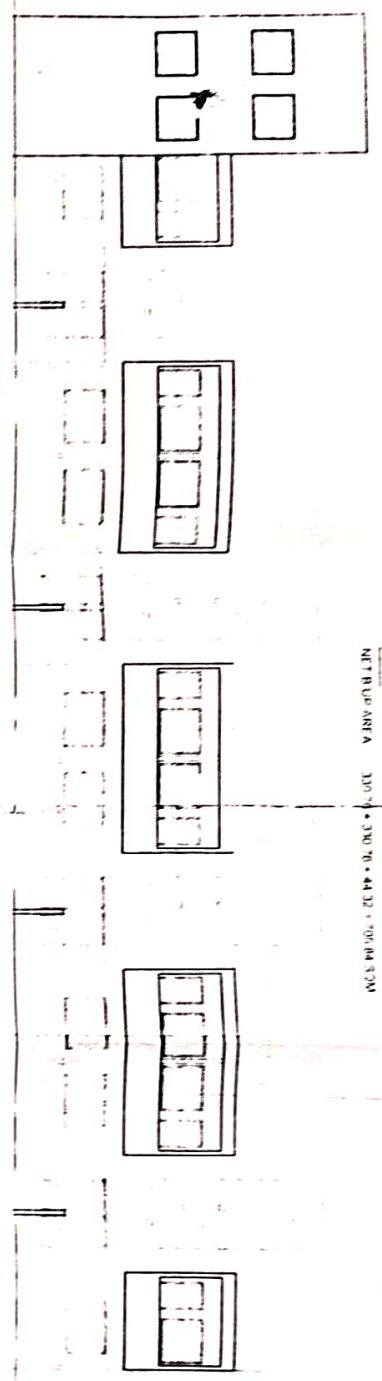

FRONT ELEVATION

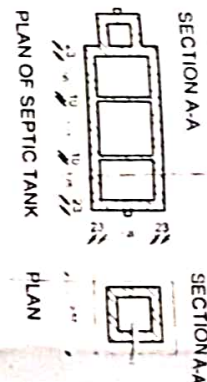


SECTION AA


SECTION AA

PLAN OF SEPTIC TANK


PLAN

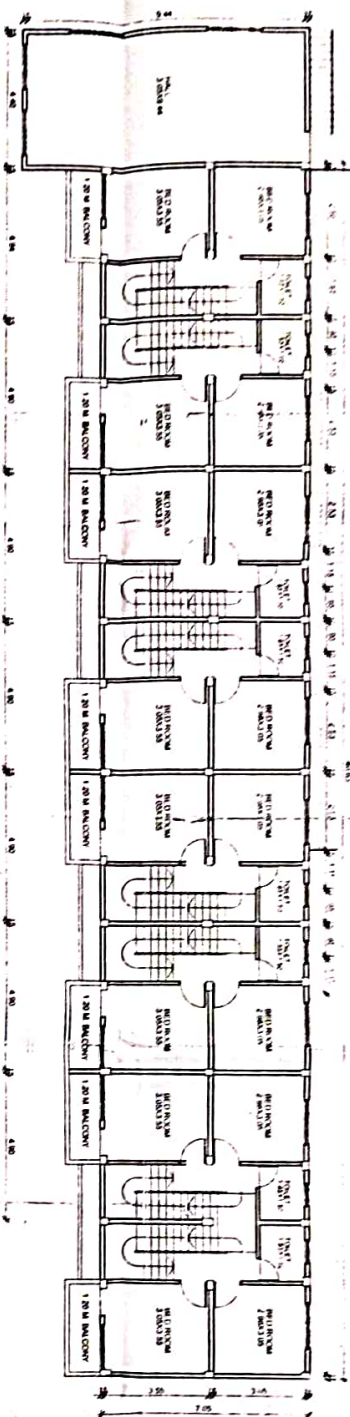


FIRST FLOOR PLAN

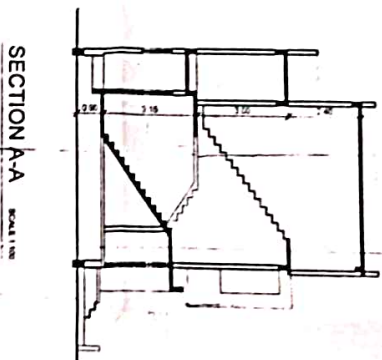

SECTION AA

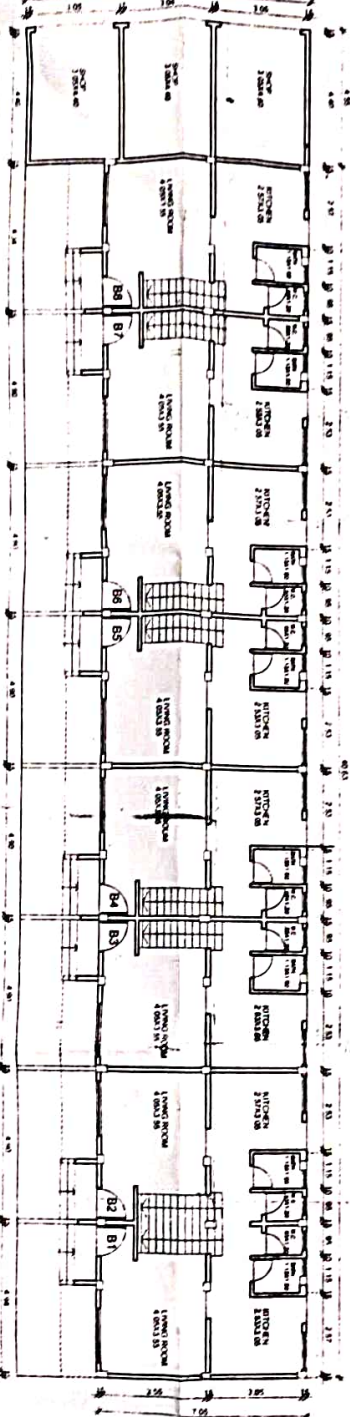

GROUND FLOOR PLAN

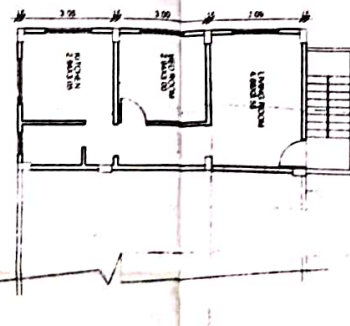

SECOND FLOOR PLAN

DOOR WINDOW SCHEDULE

Q	80 X 210	FLUSH DOOR
DR	75 X 210	FLUSH DOOR
W	120 X 140	ALUMI WINDOW
V	120 X 120	ALUMI WINDOW
Y	120 X 120	ALUMI WINDOW

AREA STATEMENT (BLOCK B)

AREA OF PLOT	72.56	SQM
PROPOSED BUILT UP AREA	1371.64	SQM
FIRST FLOOR	685.82	SQM
SECOND FLOOR	685.82	SQM
TOTAL BUILT UP AREA	1371.64	SQM

NOTE: FLOOR BOARDING SHOWN IN THESE BLOCKS

PROPOSED RESIDENTIAL BUILDING

CON P. NO. 472/2010 G.O. DT. 25.03.2010

AT DINDORI, TAL. DINDORI, NASHIK

FOR: MR. ANHET M. RAMDASI

THRO. G.P.A. MR. ANHET M. RAMDASI

MUNICIPAL DRAWING

SHAILESH RAKIBE

ARCHITECT AND INTERIOR DESIGNER


Scale: 1/20
 Date: 25/03/2010
 M-01

AREA CALCULATIONS
GROUND FLOOR

AREA OF BLOCK A $4.55 \times 9.74 = 44.32 \text{ SQM}$
 AREA OF BLOCK B $40.63 \times 7.05 = 286.44 \text{ SQM}$
 TOTAL 330.76 SQM


FIRST FLOOR

A
 NET B'UP AREA 330.76

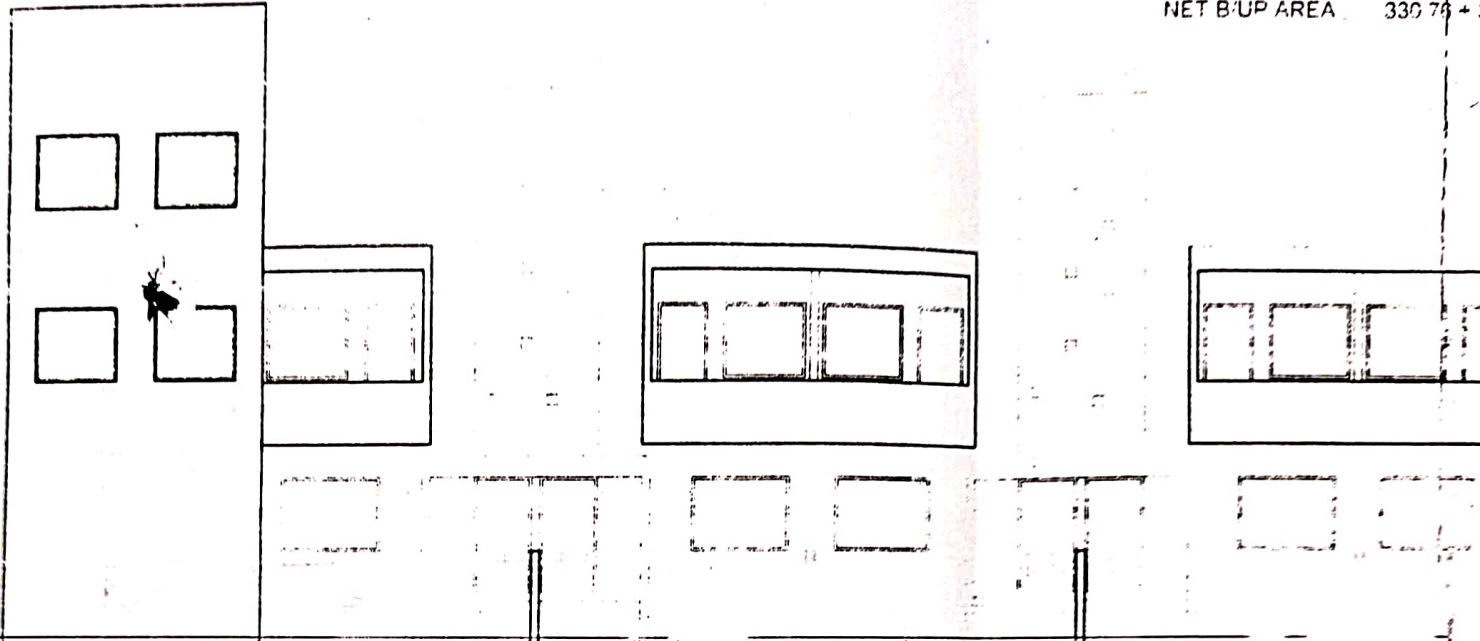


FRONT ELEVATION

SCALE 1:100

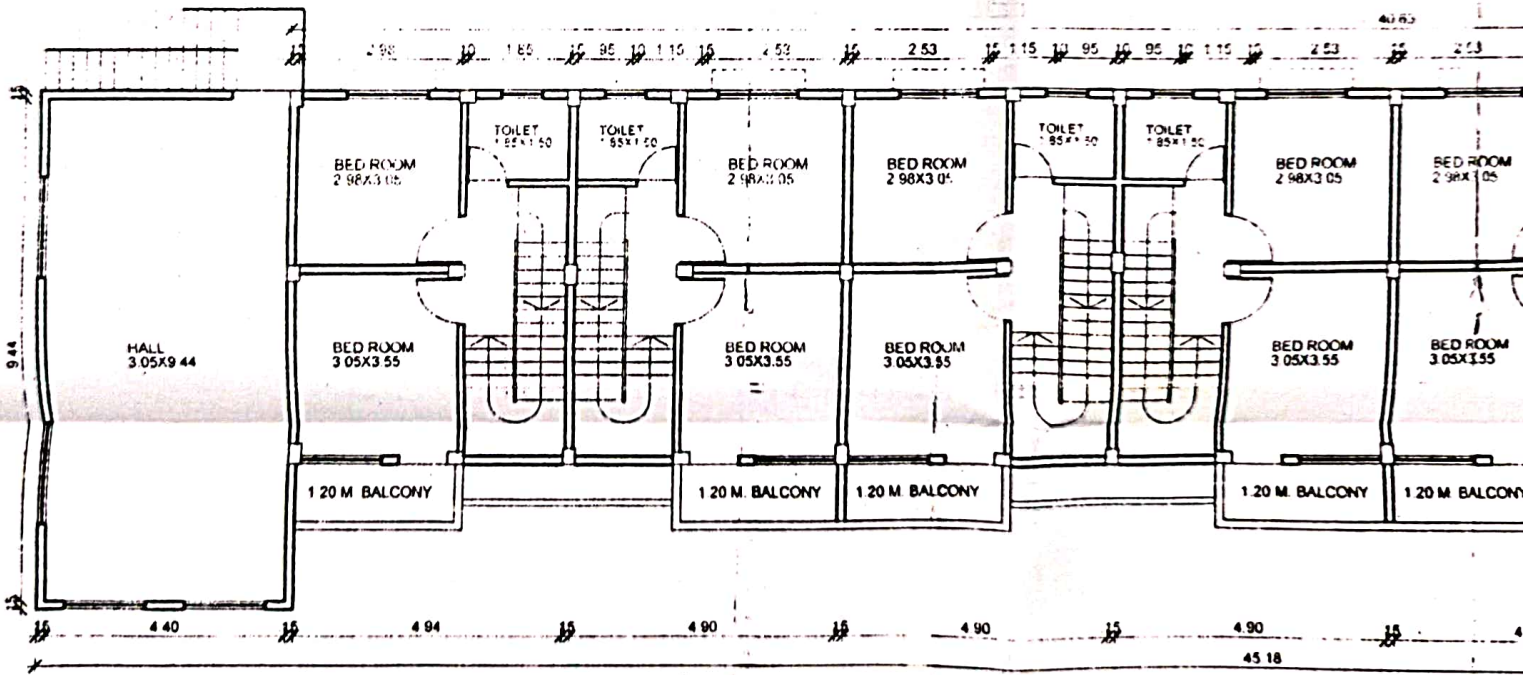

FIRST FLOOR PLAN


SCALE 1:100

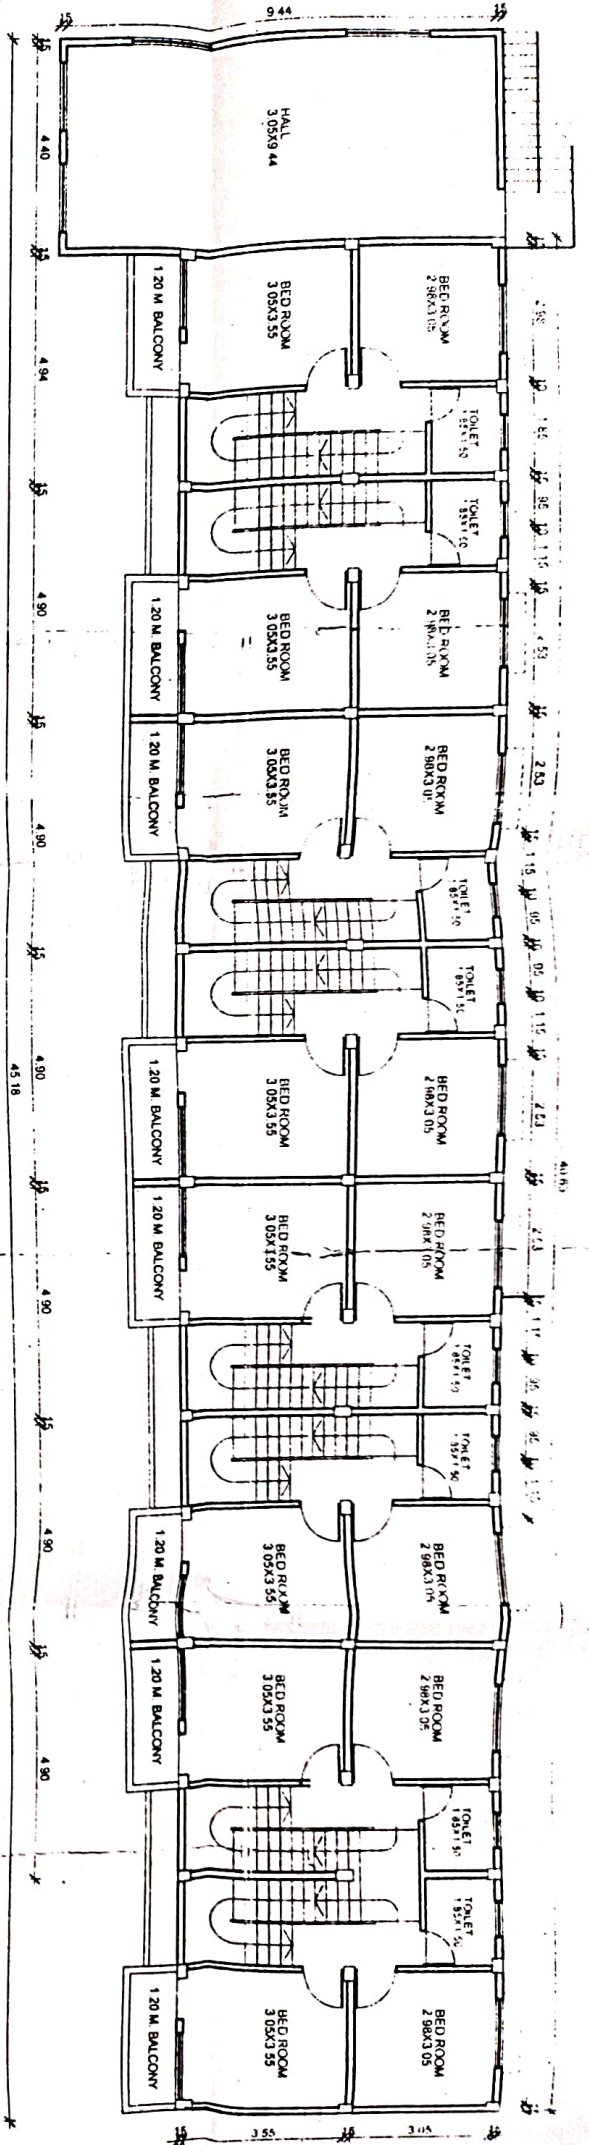

GROUND FLOOR PLAN

SCALE 1:100


B BLOCK

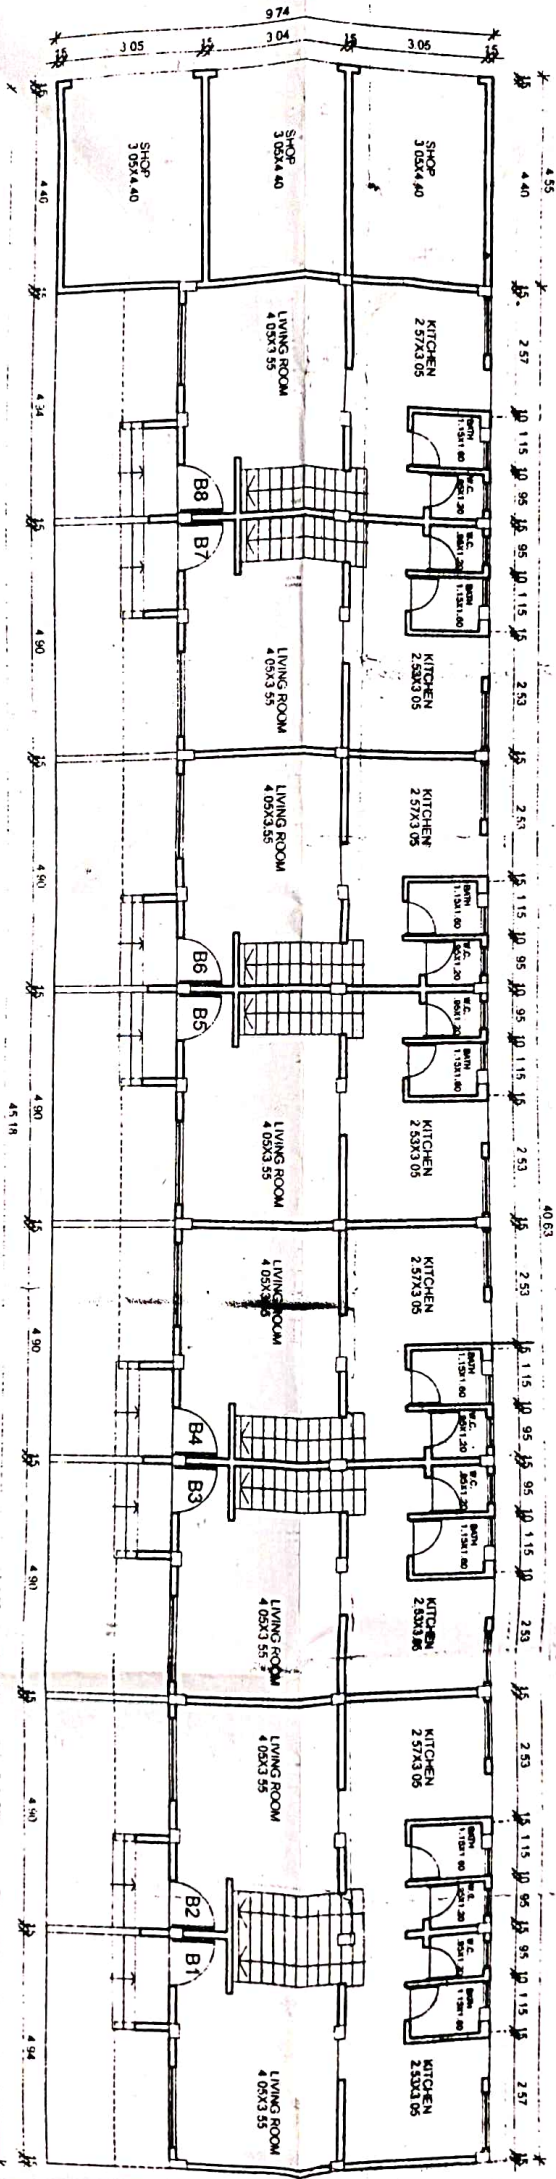

AREA OF BLOCK A 4.55 X 9.74 = 44.32 SQM
 AREA OF BLOCK B 40.63 X 7.05 = 286.44 SQM
 TOTAL 330.76 SQM


FIRST FLOOR
 A
 B
 NET B.U.P AREA 330.76 + 330.76 + 44.32 = 705.84 SQM

AREA OF BLOCK A 4.55 X 9.74 = 44.32 SQM
 AREA OF BLOCK B 40.63 X 7.05 = 286.44 SQM
 TOTAL 330.76 SQM

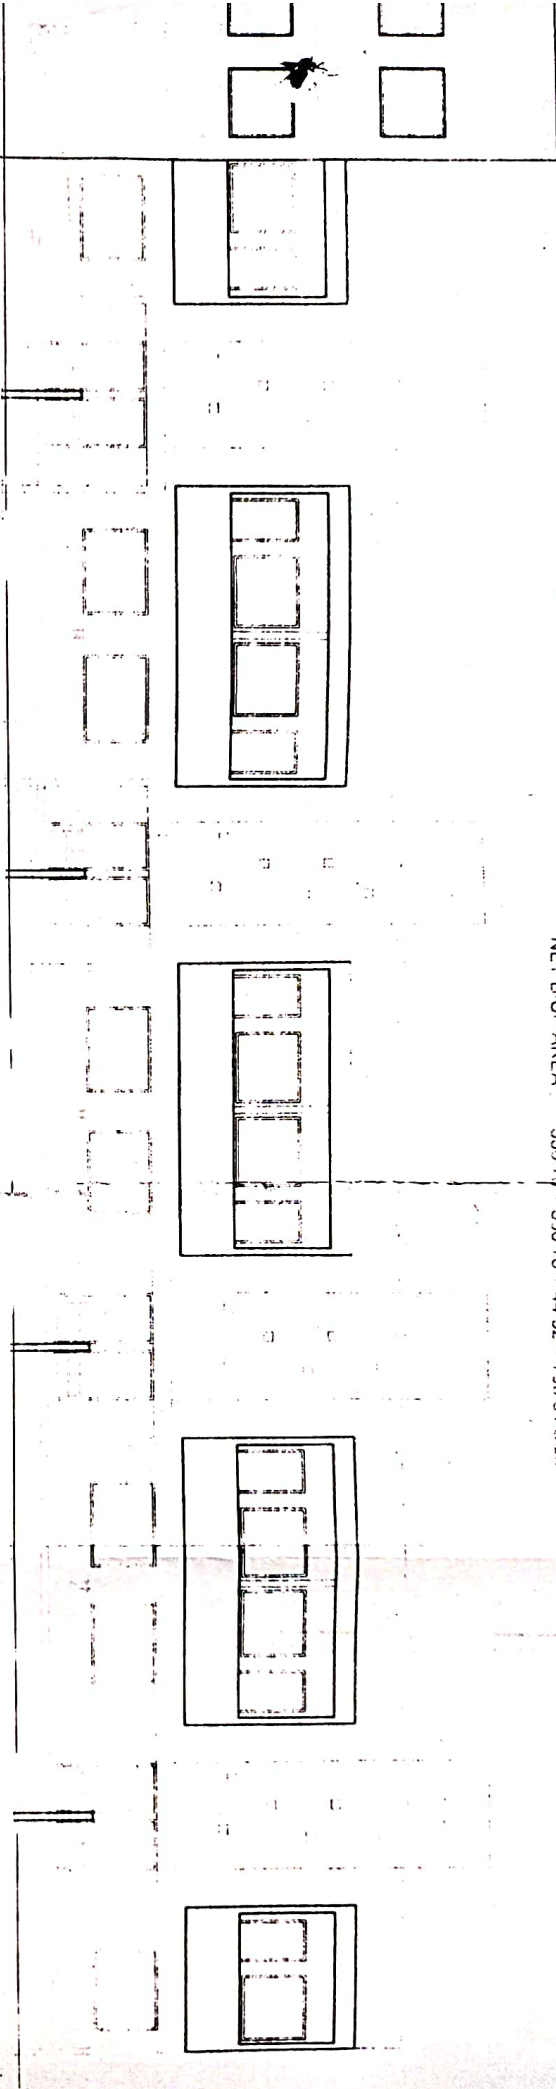

FRONT ELEVATION SCALE 1:100

PLAN OF SECTION


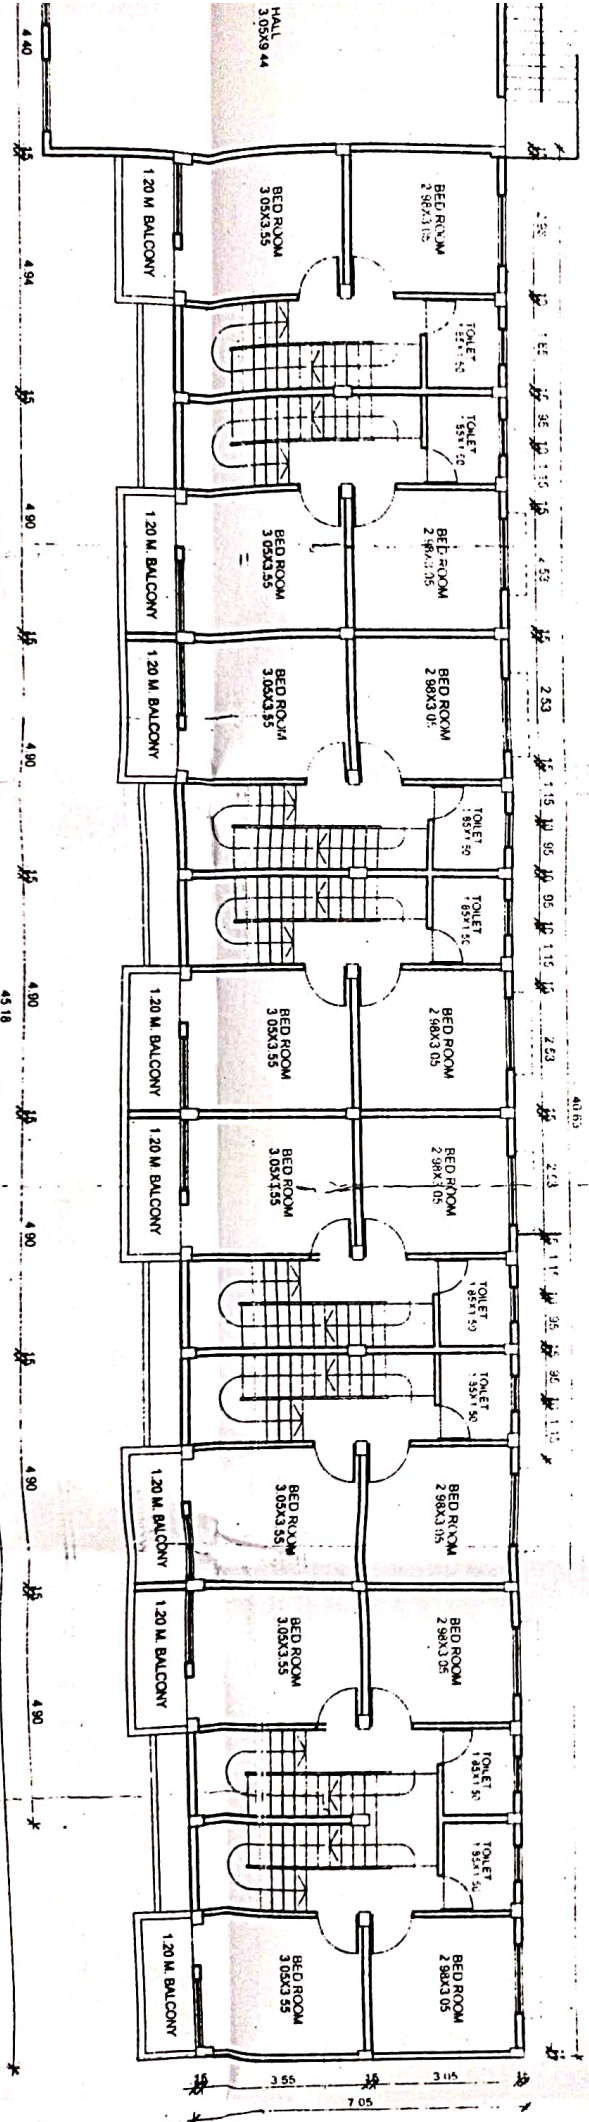


A 4.55 X 9.74 = 44.32 SQM
 B 40.63 X 7.05 = 286.44 SQM
 330.76 SQM

SECOND FLOOR


AREA OF BLOCK A 4.55 X 9.74 = 44.32 SQM

HONEY COMB BRICK MASONRY

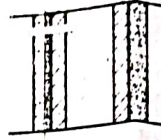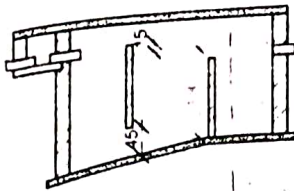



SECTION A-A

SECTION A-A

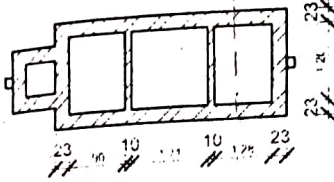



PLAN OF SEPTIC TANK

PLAN

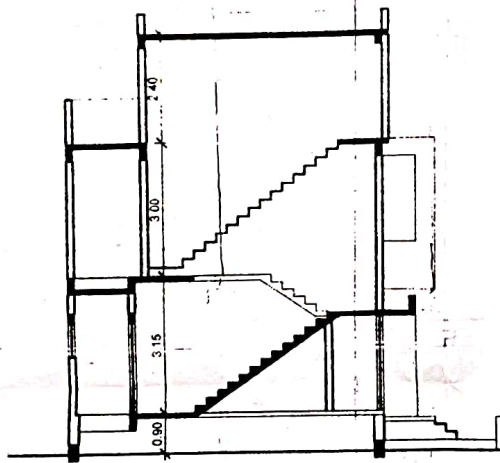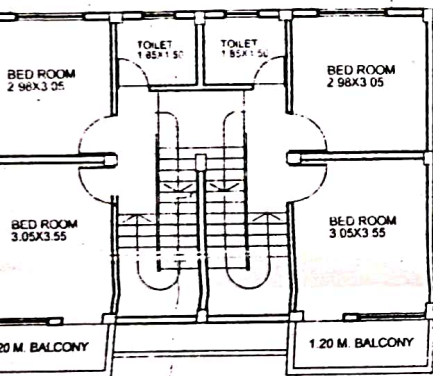

SECTION A-A

SCALE 1 100

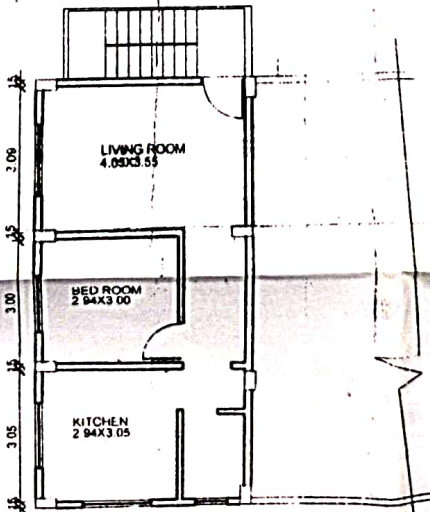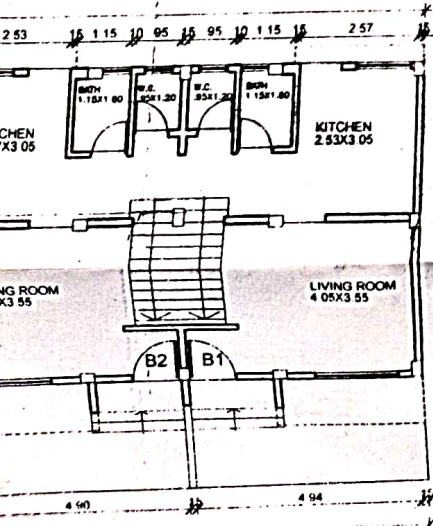

SECOND FLOOR PLAN

SCALE 1 100

APPROVING AUTHORITY

श.पं. दिंडोरी न. ७१/२०१२
 मासिक शुल्क-१२ रु. १२५३
 २०२४ (२) अथर्व नं. ११११११
 दिंडोरी तालुका अहमदनगर जिल्हा

ग्रामपंचायत अधिकारी
 ग्रामपालिका दिंडोरी
 ता. दिंडोरी, जि. नाशिक

सरपंच
 ग्रामपालिका, दिंडोरी



DOOR WINDOW SCHEDULE

D	90 X 2 10	FLUSH DOOR
D1	75 X 2 10	FLUSH DOOR
W	1 50 X 1 20	ALLUM. WINDOW
W1	1 80 X 1 20	ALLUM. WINDOW
V	0 60 X 0 90	ALLUM. WINDOW

AREA STATEMENT (BLOCK B)

AREA STATEMENT (BLOCK B)	SQM.
AREA OF PLOT	1450 00
FSI	1 00
PROPOSED BUILT UP AREA	
GROUND FLOOR	330 76
FIRST FLOOR	330 76
SECOND FLOOR	44 32
TOTAL BUILT UP AREA	705 84

NOTE
 PLOT BOUNDRY SHOWN IN THICK BLACK
 PROPOSED WORK SHOWN IN RED
 DRAINAGE LINE SHOWN IN DOTTED RED
 EXTERNAL WALL - 23M
 INTERNAL WALL - 10M

 OWN MR. ANIKET M. RAMDASI		 OR SHAILESH RAKIBE.	
PROJECT PROPOSED RESIDENTIAL BUILDING ON P. NO. 47/2 IN G.NO. 917(S.NO.368) AT DINDORI, TAL. DINDORI, NASHIK.			DATE 04.08.2024
FOR - MR. MUKUND N. RAMDASI, THRO.G.P.A. MR. ANIKET M. RAMDASI.			SCALE AS GIVEN
TITLE MUNICIPAL DRAWING			DRN BY S.V.R.
ARCHITECT SHAILESH RAKIBE ARCHITECT AND INTERIOR DESIGNER			CHK BY SHAILESH
S-5/A, SARITA DERSHAN OLD GANGAPUR NAKA GANGAPUR ROAD, NASHIK.			JOB NO 77
			DRG NO M-01