


B/U AREA CAL. (GR. FLR.) WING- I, J


UNITS	NO. OF UNITS	DIMENSION IN METRE	AREA IN SQ. M.
1	4	3.30 X 3.95	44.22
2	2	2.35 X 3.00	14.10
3	1	2.75 X 4.80	12.65
4	1	2.95 X 8.00	23.60
5	2	3.15 X 3.65	23.00
6	2	2.35 X 5.40	25.38
7	1	0.15 X 2.45	0.36
8	2	0.40 X 2.40	1.92
BAU AREA GR. FLOOR			145.23

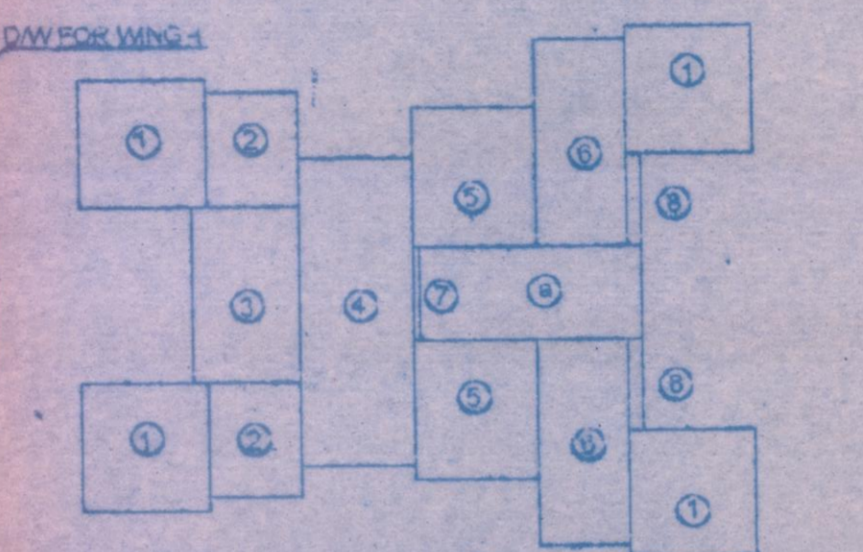

AREA DIAGRAM SCALE 1:200
1ST TO 4TH FLR (WING-I, J)

STAIRCASE AREA CALCULATION FOR GROUND FLOOR[WING-L]


B/U AREA PER FLOOR	68.13
PERMISSIBLE ST. AREA/FLR	10.37
PROPOSED STAIRCASE	
S1 1 4.25 X 2.60	11.05
PROPOSED STAIR AREA/FLOOR	11.05
EXCESS STAIR AREA/FLOOR	0.68

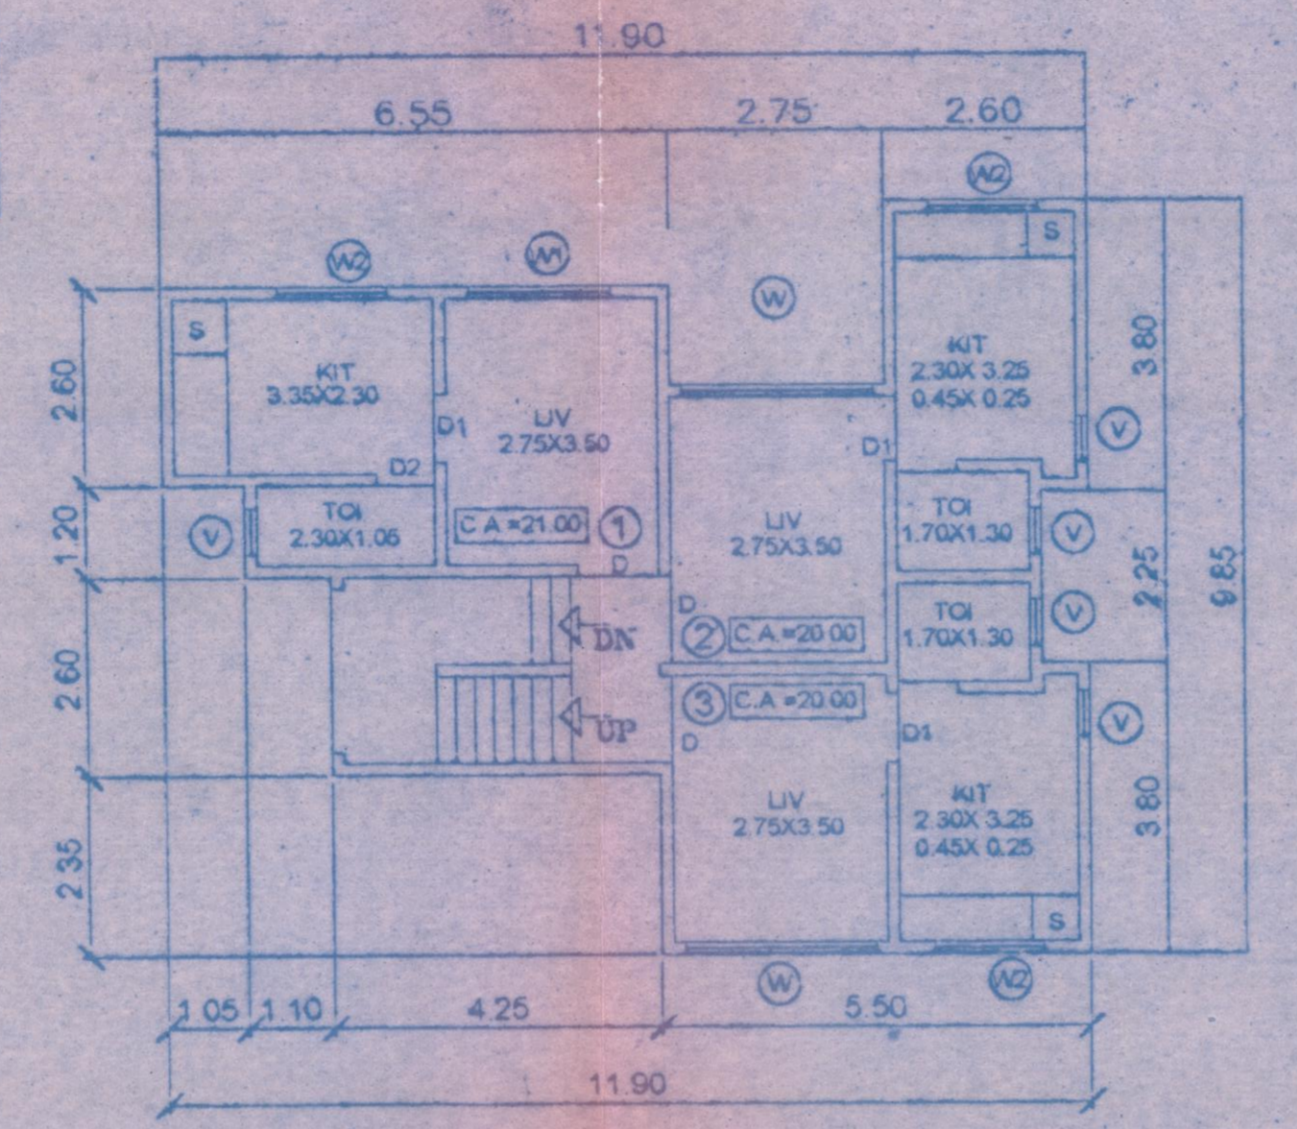


GROUND FLOOR PLAN [WING-L] SCALE 1:100

BUILT UP AREA CALCULATION FOR GROUND FLOOR[WING-L]

UNITS	NO. OF UNITS	DIMENSION IN METER	AREA IN SQ. M.
1	1	6.40 X 2.60	16.64
2	1	5.35 X 1.20	6.42
3	1	0.15 X 1.30	0.20
4	1	2.90 X 7.45	21.61
5	2	2.60 X 3.80	15.76
6	1	2.00 X 2.25	4.50
TOTAL			68.13

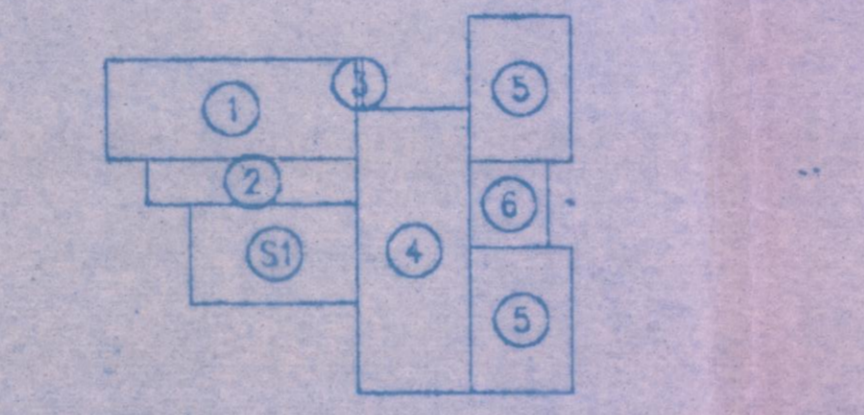


AREA DIAGRAM[WING-L] GROUND FLR. SCALE 1:200

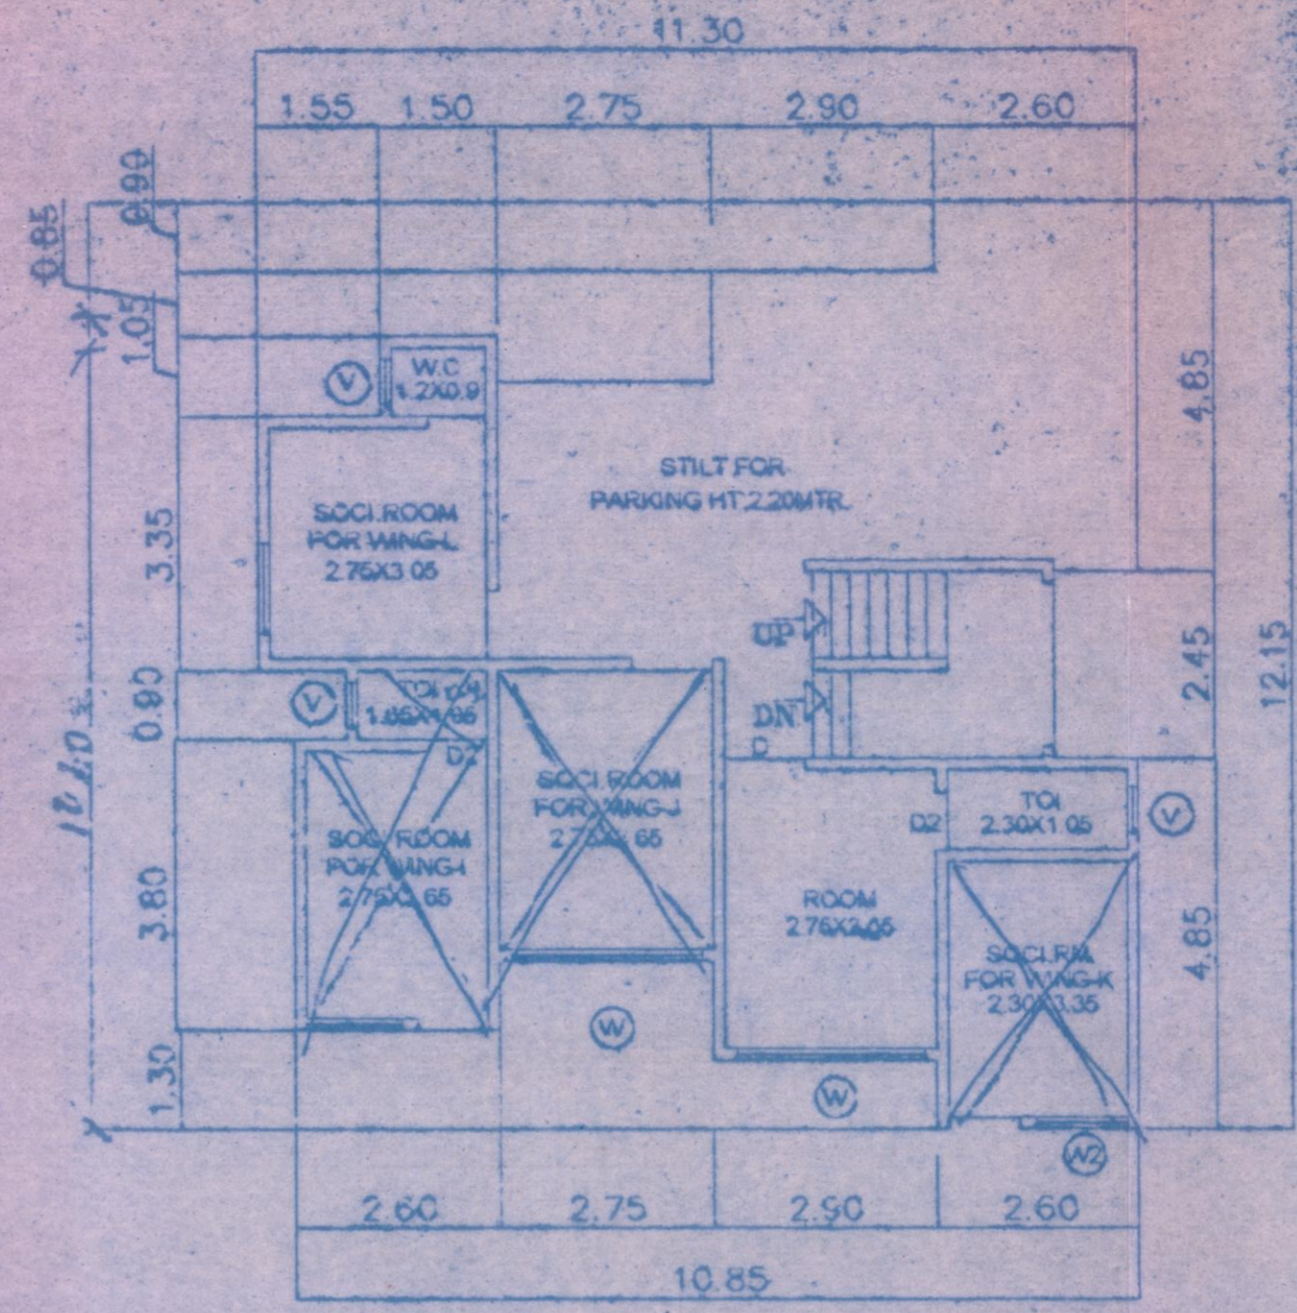

GROUND FLOOR PLAN [WING-K] SCALE 1:100

BUILT UP AREA CALCULATION FOR GROUND FLOOR[WING-K]

UNITS	NO. OF UNITS	DIMENSION IN METER	AREA IN SQ. M.
1	1	3.05 X 3.35	10.22
2	1	2.45 X 1.35	3.31
TOTAL			13.53

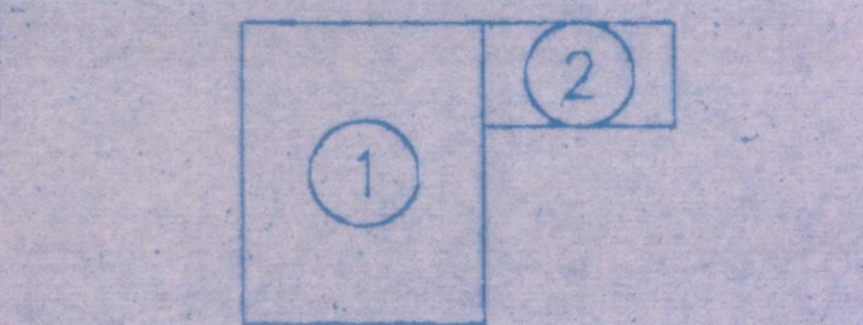

AREA DIAGRAM SCALE 1:200
GROUND FLR. [WING-K]

STAIRCASE AREA CAL. TYP. FLR. (1ST TO 4TH) WING-I, J

B/U AREA PER FLOOR	129.53
PERMISSIBLE ST. AREA/FLR	19.42
PROPOSED STAIRCASE	
a 1 2.45 X 4.75	11.63
TOTAL PROPOSED STAIR AREA	11.63
TOTAL BAL. AREA PROPOSED	NIL

BAL AREA CAL. TYP. FLR. (1ST TO 4TH) WING-I, J


B/U AREA PER FLOOR	129.53
PERMISSIBLE BAL. AREA/FLR	12.95
PROPOSED BALCONIES	
A 2 3.15 X 0.95	5.98
B 2 2.95 X 0.95	5.61
C 1 3.30 X 0.45	1.49
BAL. AREA PROPOSED/FLR	13.08
EX. BAL. AREA PROPOSED/FLR	0.13
EX. BAL. AREA (1ST-4TH)	0.52

STAIRCASE AREA CAL. GR. FLR. WING I, J

B/U AREA PER FLOOR	145.23
PERMISSIBLE ST. AREA/FLR	21.78
PROPOSED STAIRCASE	
a 1 2.45 X 4.75	11.63
TOTAL PROPOSED STAIR AREA	11.63
TOTAL BAL. AREA PROPOSED	NIL

B/U AREA CAL. (1ST TO 4TH) (WING- I, J)

UNITS	NO. OF UNITS	DIMENSION IN METRE	AREA IN SQ. M.
1	3	3.30 X 3.35	33.17
2	2	2.35 X 3.00	14.10
3	1	2.75 X 4.80	12.65
4	1	2.95 X 5.20	15.34
5	2	3.15 X 2.70	17.01
6	1	2.35 X 5.40	12.69
7	1	0.15 X 2.45	0.37
8	1	2.50 X 5.40	13.50
9	1	3.15 X 2.90	9.14
10	1	0.25 X 2.40	0.60
11	1	0.40 X 2.40	0.96
BAU AREA PER FLOOR			129.53
BAU AREA 1ST TO 4TH			518.12

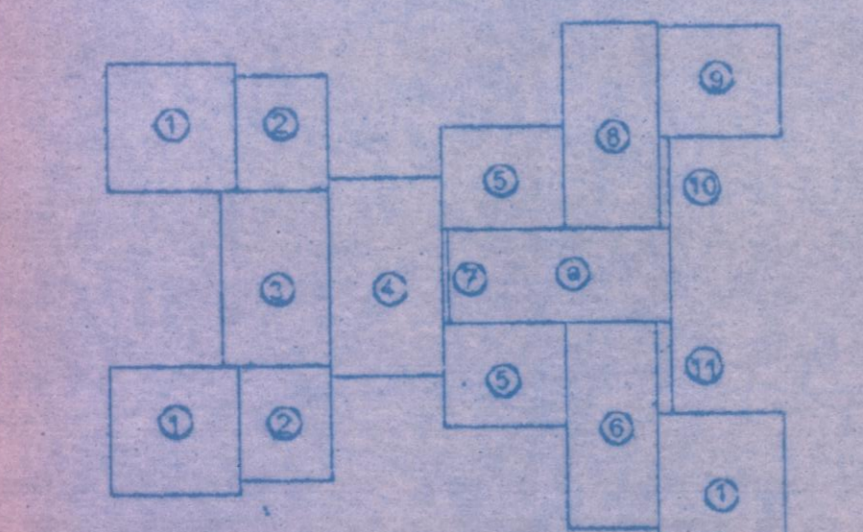


AREA CAL. DIAGRAM SCALE 1:200
1ST TO 4TH FLR [WING-I, J]

BALCONY AREA CAL.[WING-L] FOR TYPICAL FLOOR[1st to 4th]

B/U AREA PER FLOOR	62.03
PERMISSIBLE BAL. AREA	6.20
PROPOSED BALCONIES	
B1 1 1.35 X 2.60	3.51
B2 1 2.60 X 1.10	2.86
PROPOSED BAL. AREA/FLOOR	6.37
EXCESS BAL. AREA/FLOOR	0.17

STAIRCASE AREA CAL.[WING-L] FOR TYPICAL FLOOR[1st to 4th]


B/U AREA PER FLOOR	62.03
PERMISSIBLE ST. AREA/FLR	9.30
PROPOSED STAIRCASE	
S1 1 4.25 X 2.60	11.05
PROPOSED STAIR AREA/FLOOR	11.05
EXCESS STAIR AREA/FLOOR	1.75

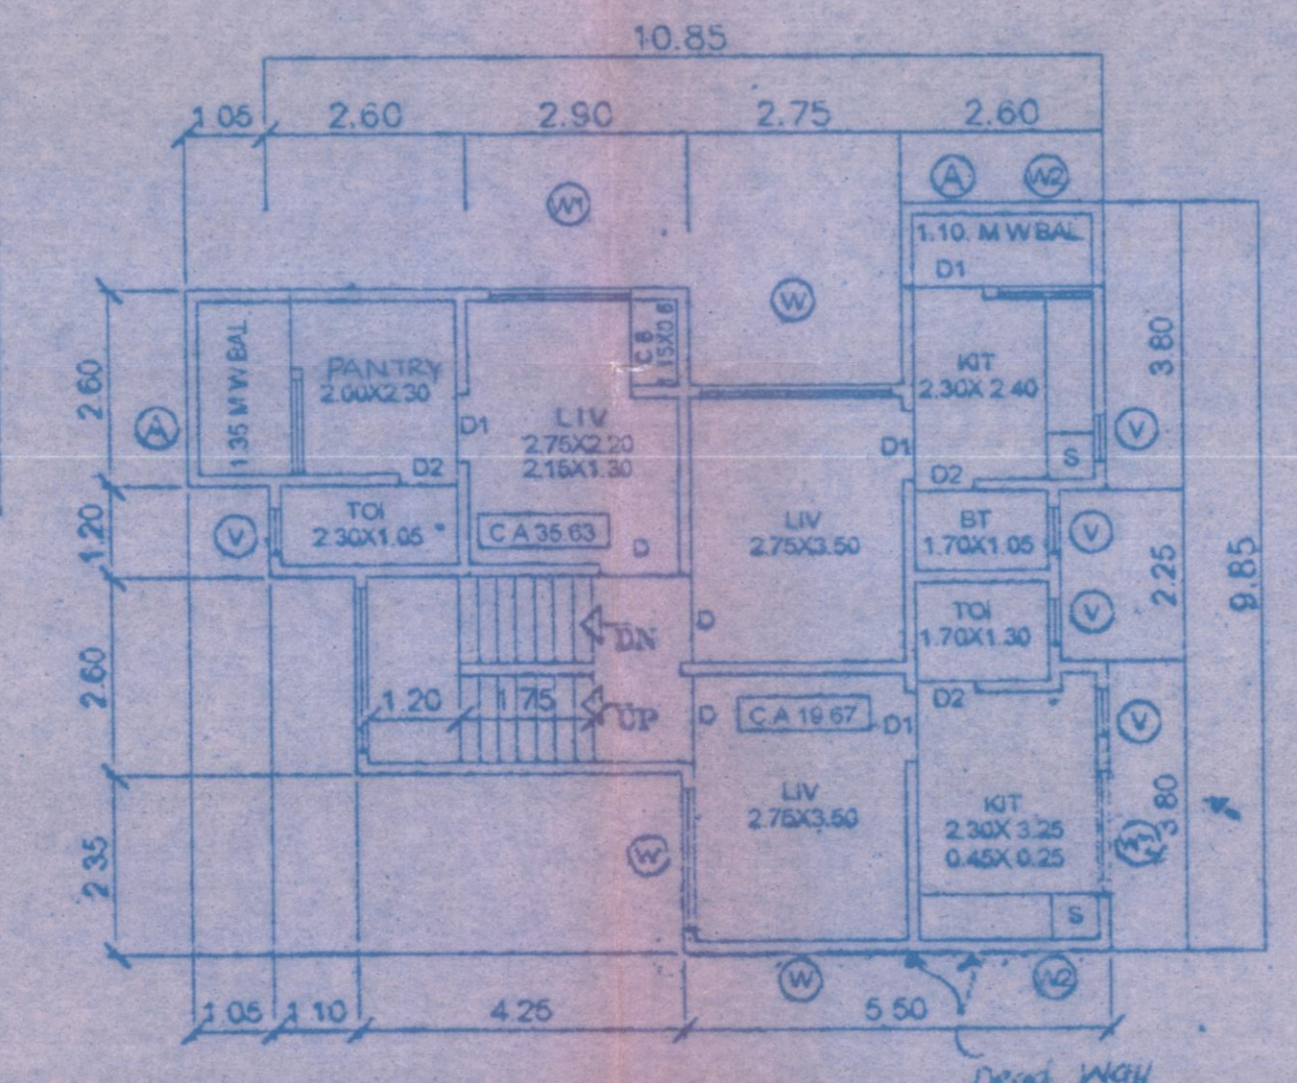

TYPICAL FLOOR PLAN 1ST TO 4TH FLR [WING-L] SCALE 1:100

B/U AREA CALCULATION [WING-L] FOR TYPICAL FLOOR[1st to 4th]

UNITS	NO. OF UNITS	DIMENSION IN METER	AREA IN SQ. M.
1	1	4.90 X 1.35	6.62
2	1	4.60 X 2.45	11.27
3	1	0.45 X 2.50	1.13
4	1	2.90 X 7.45	21.61
5	1	2.60 X 2.70	7.02
6	1	2.00 X 2.25	4.50
7	1	2.60 X 3.80	9.88
TOTAL			62.03

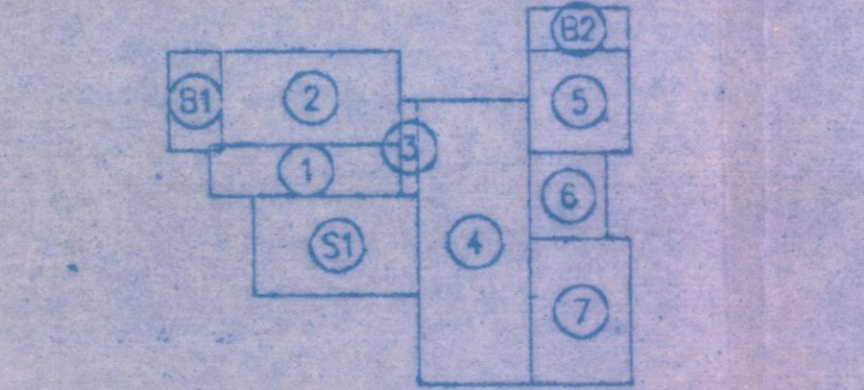


AREA DIAGRAM [WING-L] TYPICAL 1st TO 4th SCALE 1:200

B/U AREA PER FLOOR	85.92
PERMISSIBLE ST. AREA/FLR	12.58
PROPOSED STAIRCASE	
a 1 2.45 X 4.75	11.63
TOTAL PROPOSED STAIR AREA	11.63
TOTAL BAL. AREA PROPOSED	NIL

STAIRCASE AREA CAL. TYP. FLR. (1ST TO 4TH) WING-K

B/U AREA PER FLOOR	83.92
PERMISSIBLE BAL. AREA/FLR	8.39
PROPOSED BALCONIES	
A 2 1.05 X 2.60	5.46
B 1 0.60 X 2.90	3.48
BAL. AREA PROPOSED/FLR	8.94
EX. BAL. AREA PROPOSED/FLR	0.55
TOTAL BAL. AREA (1ST-4TH FLR)	02.20


BAL AREA CAL. TYP. FLR. (1ST TO 4TH) WING-K

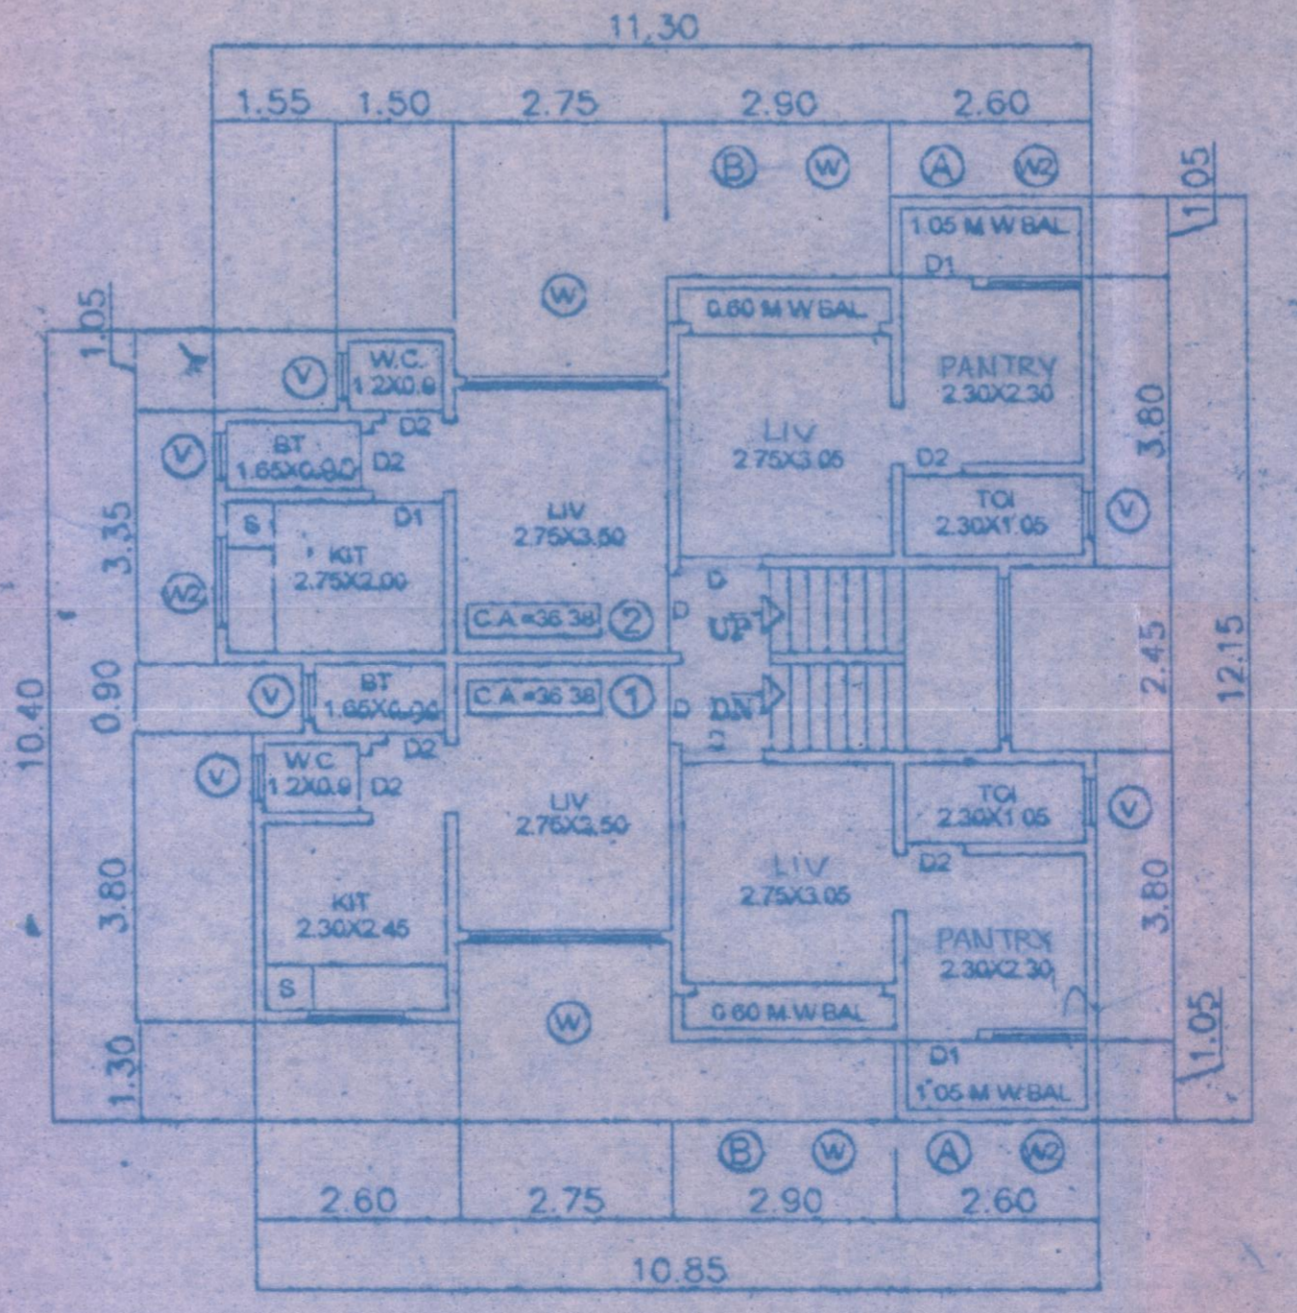

TYPICAL FLOOR PLAN 1ST TO 4TH FLR [WING-K] SCALE 1:100

B/U AREA CAL.(1ST TO 4TH) (WING-K)

UNITS	NO. OF UNITS	DIMENSION IN METRE	AREA IN SQ. M.
1	1	1.50 X 1.05	01.57
2	1	3.05 X 3.50	10.67
3	1	0.90 X 1.95	01.75
4	1	2.60 X 3.80	09.88
5	1	2.75 X 7.45	20.49
6	1	0.15 X 2.45	00.37
7	2	2.90 X 3.20	18.72
8	2	2.60 X 3.80	19.76
BAU AREA PER FLOOR			83.92
BAU AREA 1ST TO 4TH FLR			335.68

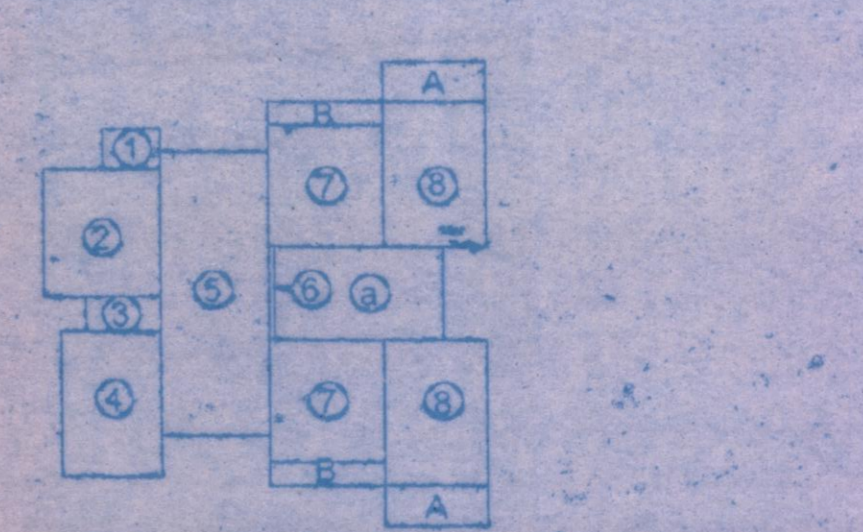

AREA DIAGRAM TYP. FLR.[1st to 4th] WING-K SCALE 1:200

SCHEDULE OF OPENINGS

TYPE	DIMENSION IN METER	DESCRIPTION
D	1.05X2.15	T.W. FRAMED DEC. FL.DOOR
D1	0.90X2.15	T.W. FRAMED FLUSH DOOR
D2	0.75X2.00	T.W. FRAMED PANEL DOOR
W	2.45X1.25	AL SLIDING WINDOWS
W1	1.85X1.25	AL SLIDING WINDOWS
W2	1.25X1.10	AL SLIDING WINDOWS
V	0.60X0.90	LOUVERED VENTILATORS

TOTAL B.U.A. STATEMENT

WING	GR.FLR.AREA IN SQ.MTR	TYP.FLR.AREA 1st TO 4th	TOTAL BAU AREA IN SQ.MTR.	EX STAIR AREA GR TO 4th	EX. BAL AREA 1st TO 4th
I&J(G+4)	145.23X2=290.46	518.12X2=1036.24	663.35X2=1326.70	NIL	0.52X2=1.04
K(ST+4)	13.53	335.68	349.21	NIL	02.20
L(G+4)	68.13	248.12	317.25	07.69	00.68
TOTAL			1326.70	07.69	03.92

NOTES :-
 1. ALL DIMENSION IN METRES
 2. ALL EXTERNAL WALLS ARE 0.15M CONC. WALLS
 3. ALL INTERNAL WALLS ARE 0.15M. BRICK WALLS
 4. STAIRCASE DETAILS
 A. WIDTH OF TREAD - 0.25M
 B. HEIGHT OF RISER - 0.18M.
 C. WIDTH OF FLIGHT - 1.15M.
 5. PLINTH HEIGHT FROM GL-0.15M

PROFORMA - B

CERTIFICATE OF AREA
 I HAVE SURVEYED THE PLOT UNDER REFERENCE AND THAT THE DIMENSIONS ON THE SITES ETC. OF THE PLANS ARE AS MEASURED ON THE SITE AND AREA SO WORKED OUT IS SCIENTIFICALLY AND TRULY STATED IN THE DOCUMENT OF OWNERSHIP / TOWN PLANNING SCHEME RECORD.

NAME OF P. A. HOLDER: CHANDS / CA. SURESHCHANDRAN / BABU RAO PATIL
 DATE: 04/04/2005
 DRAWING NO.: AS SHOWN
 SCALE: 1:100
 DATE: 04/04/2005
 JOB NO.:
 CHECKED BY: B. SURESH
 DRAWN BY: J. SURESH

ARCHITECT: **LEAD** ENGINEERING & ARCHITECTURAL DIVISION
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