


**FOURTH FLOOR PLAN**  
scale - 1 : 100



# FOURTH FLOOR PLAN

scale - 1 : 100


PRODUCED BY

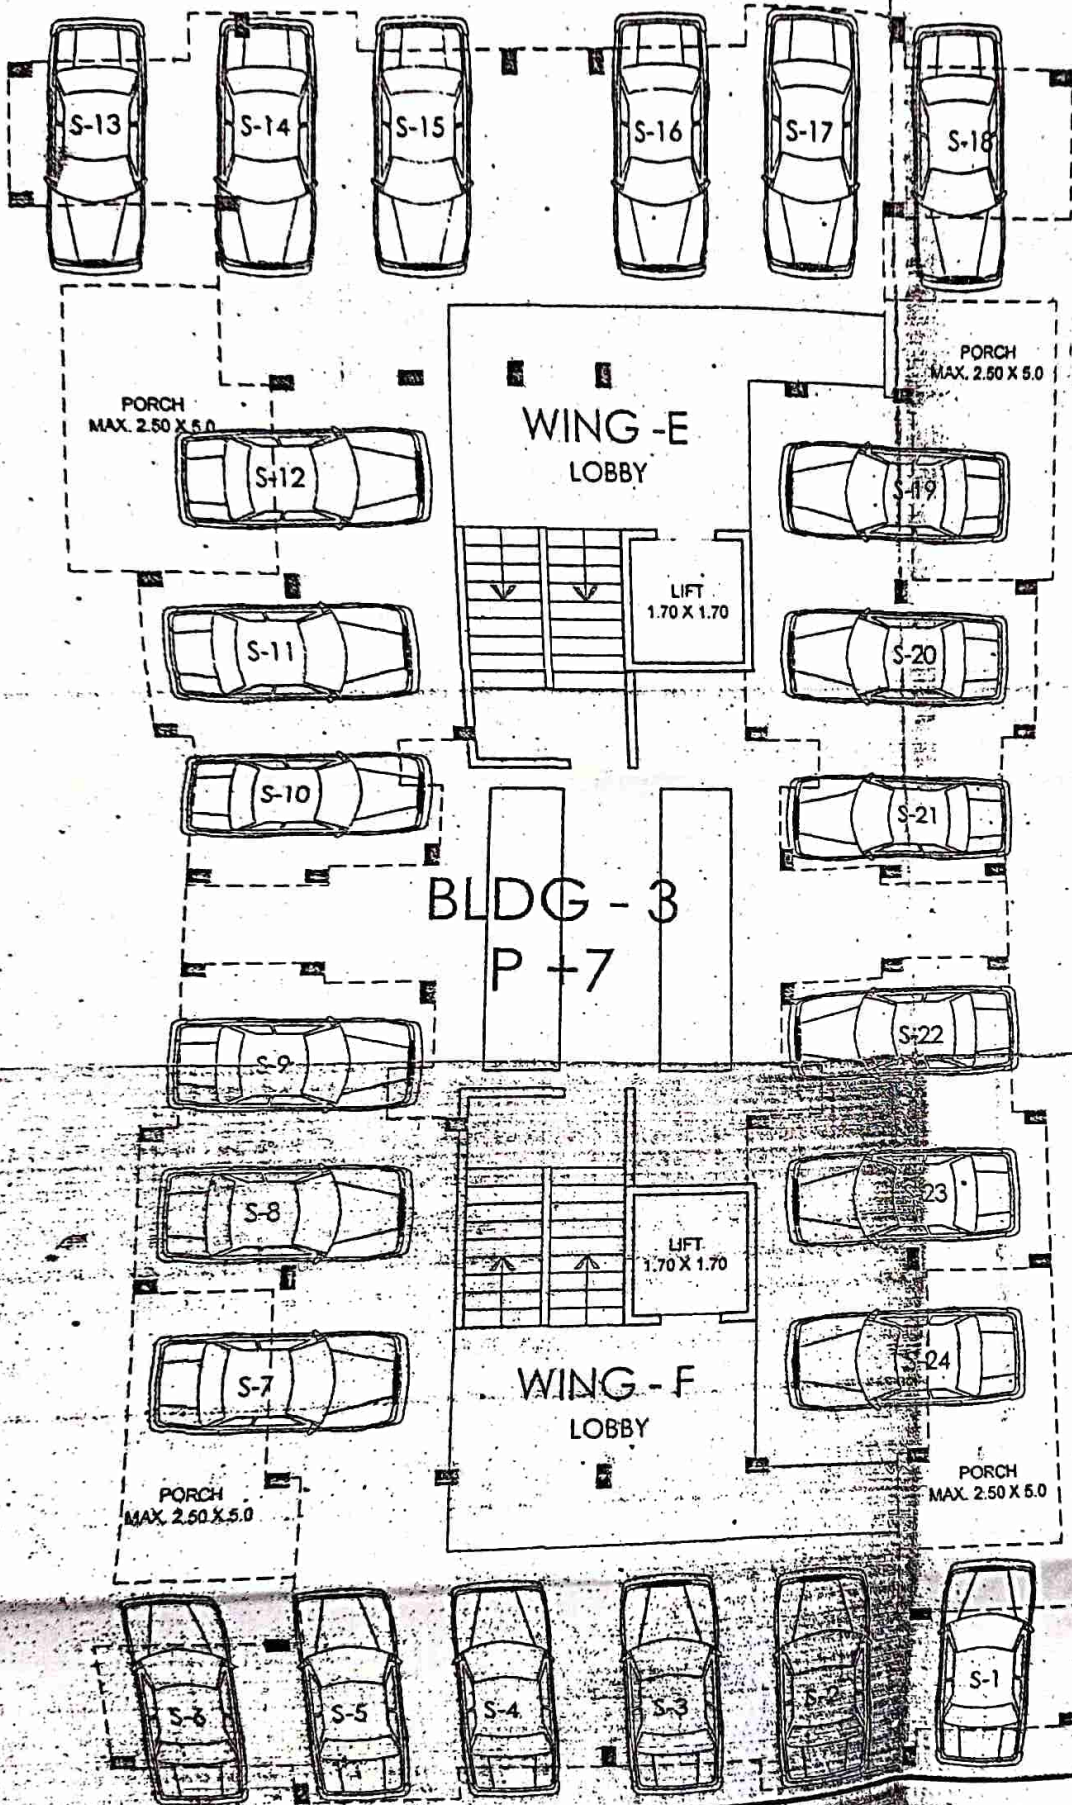

GROUND FLOOR PLAN

BUILDING



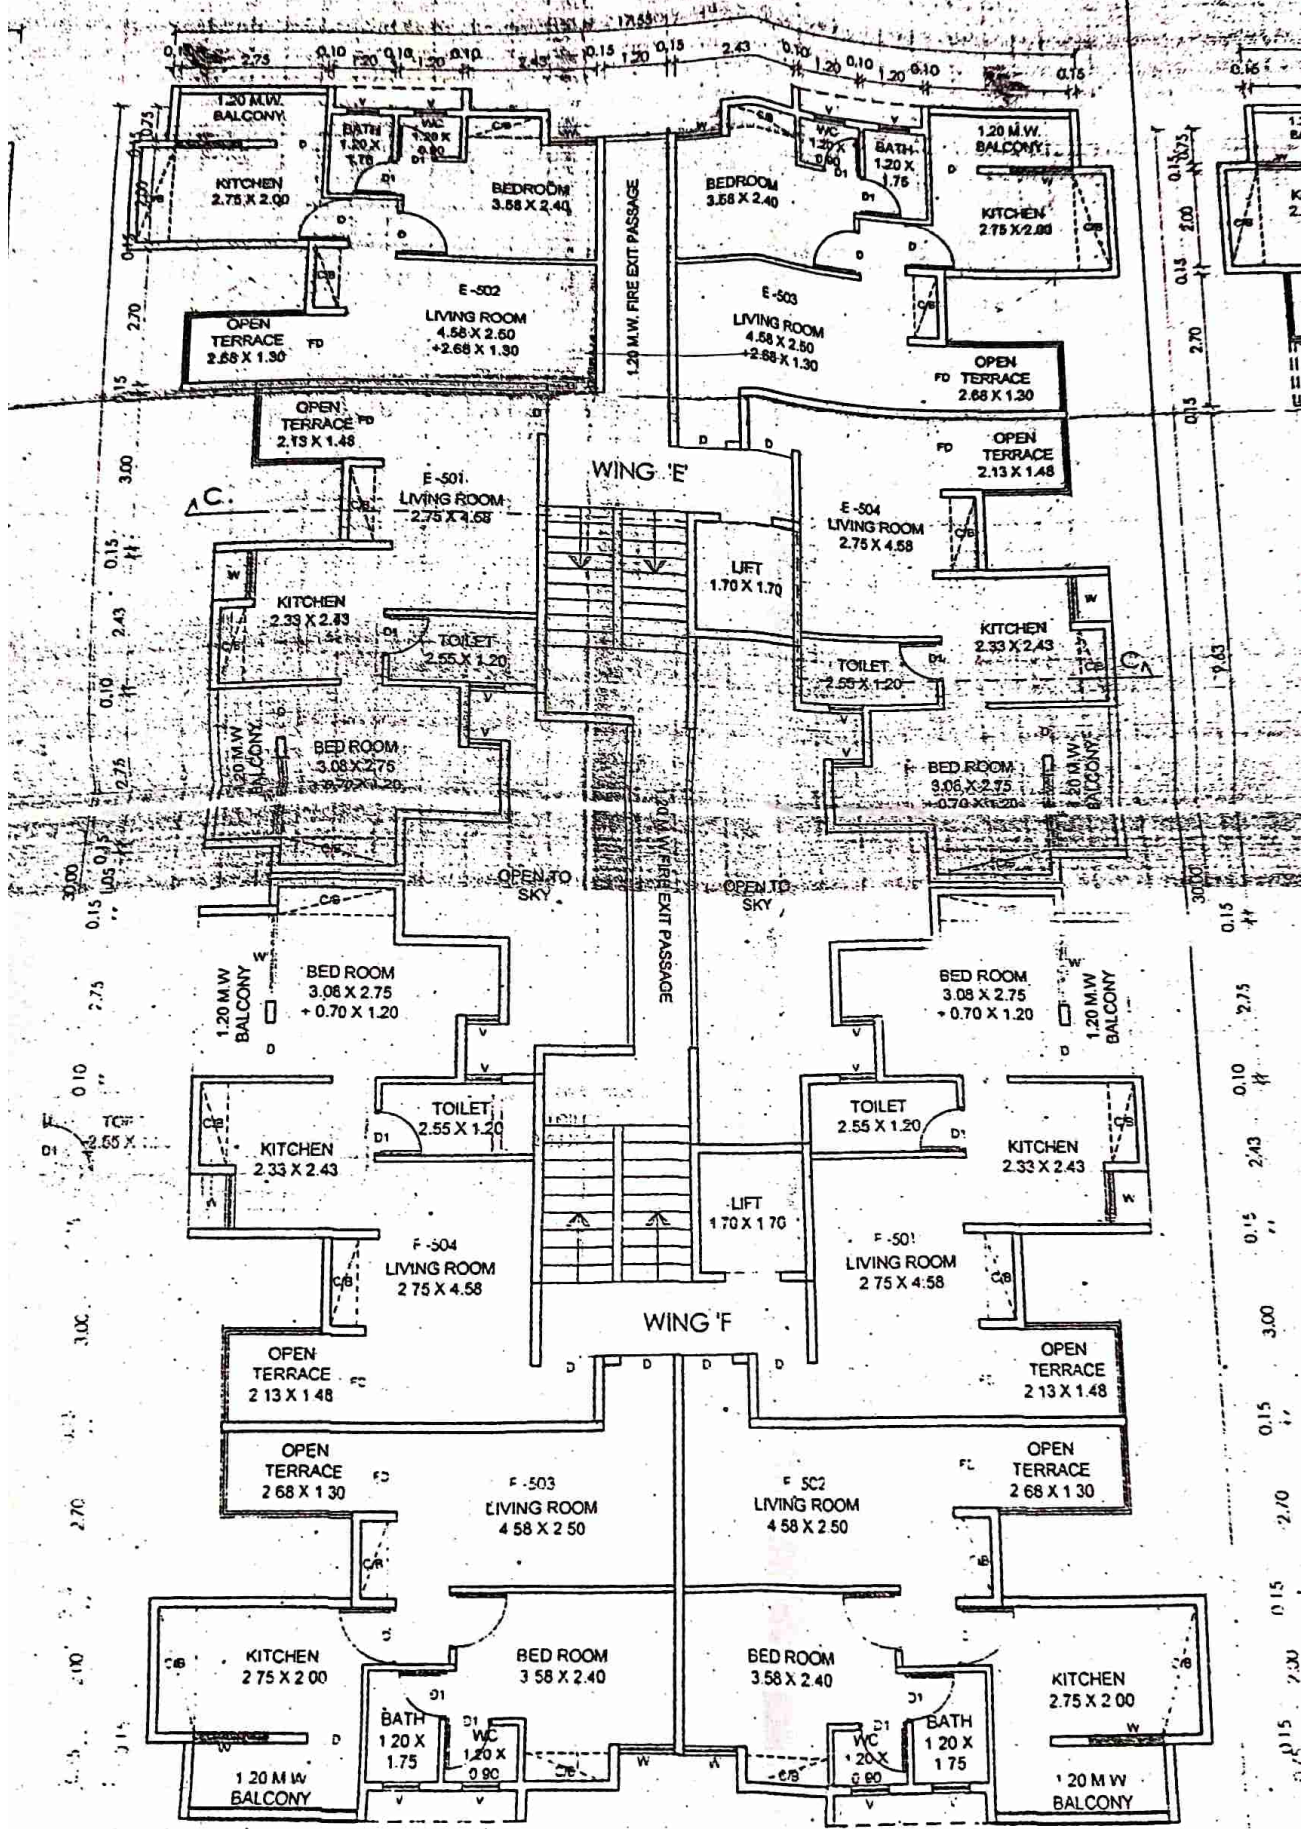


FIFTH FLOOR PLAN  
SCALE - 1 : 100



FIFTH FLOOR PLAN

SCALE - 1 : 100

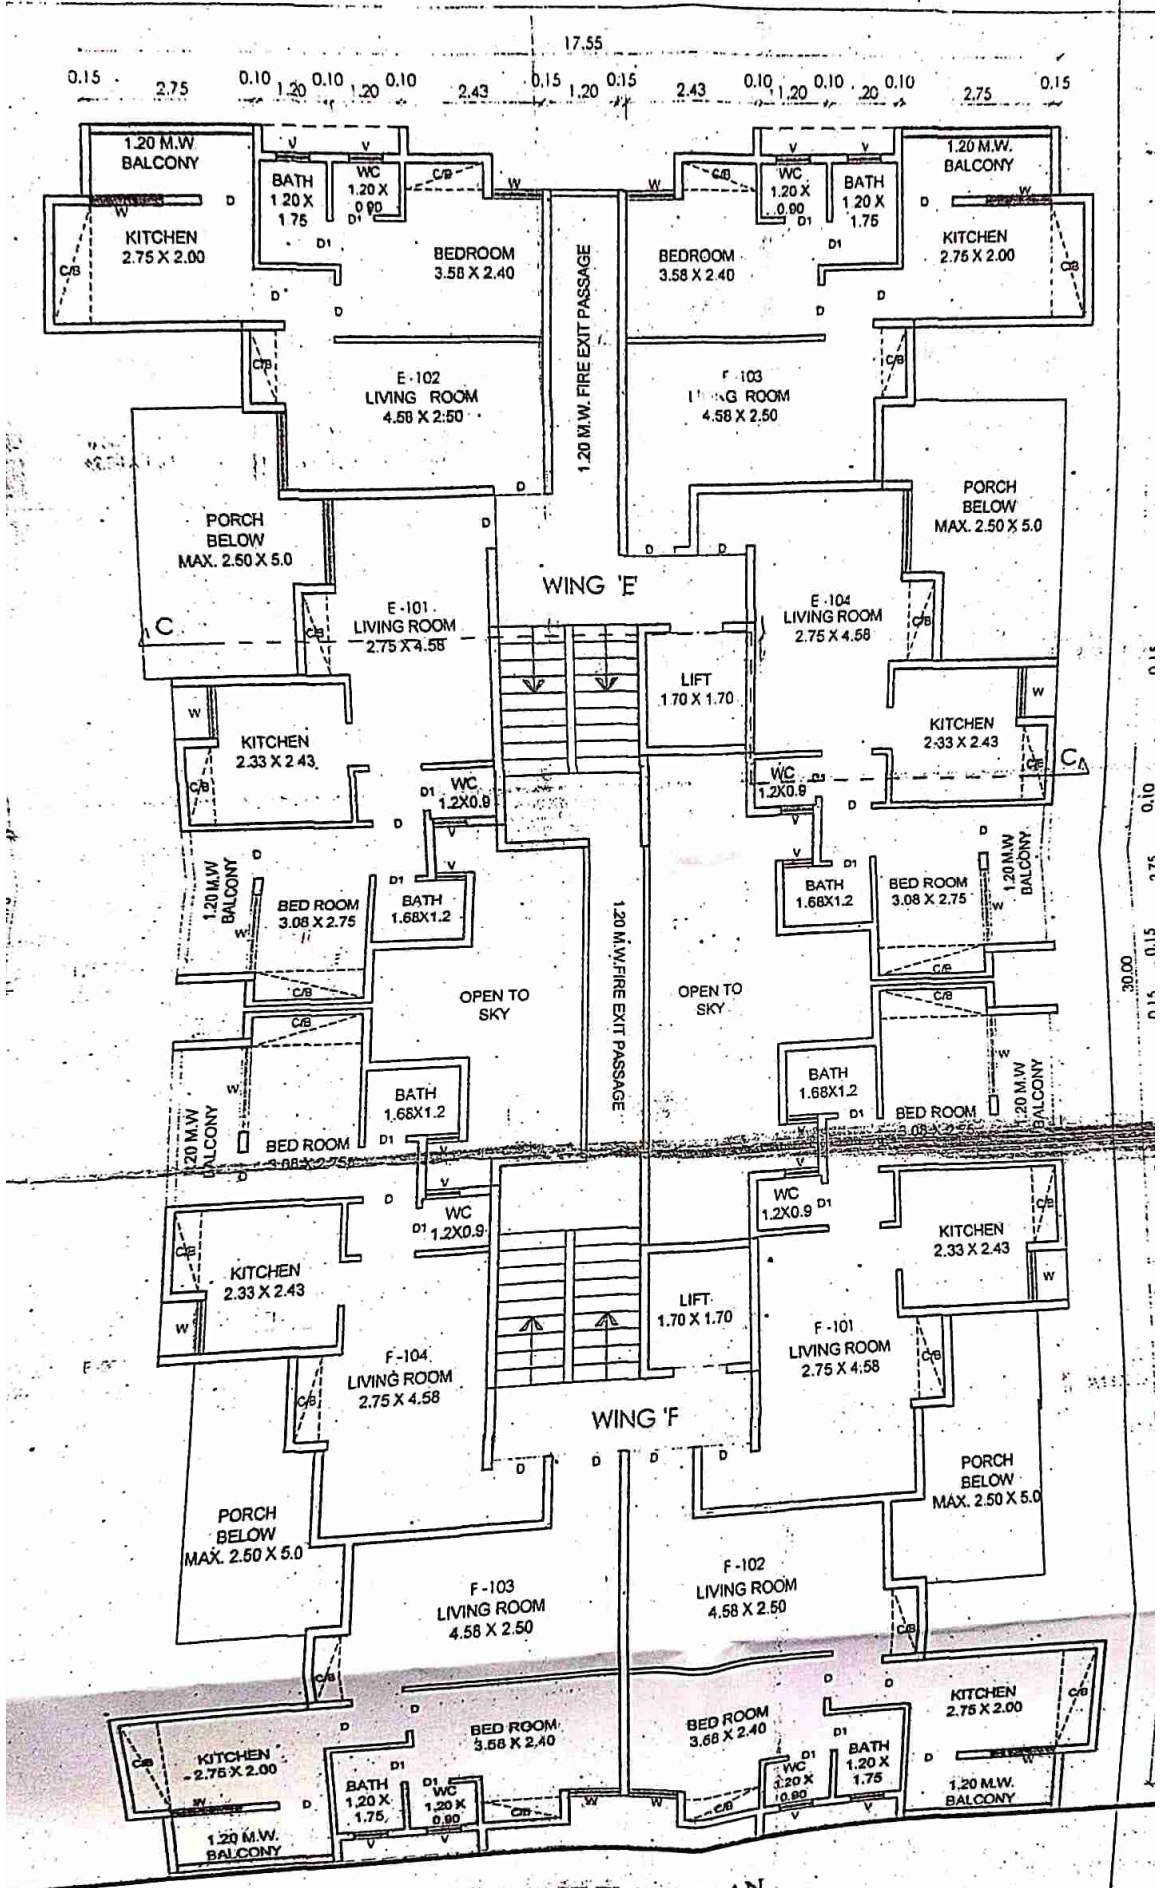


FIRST FLOOR PLAN

scale - 1 : 100

WING '3'



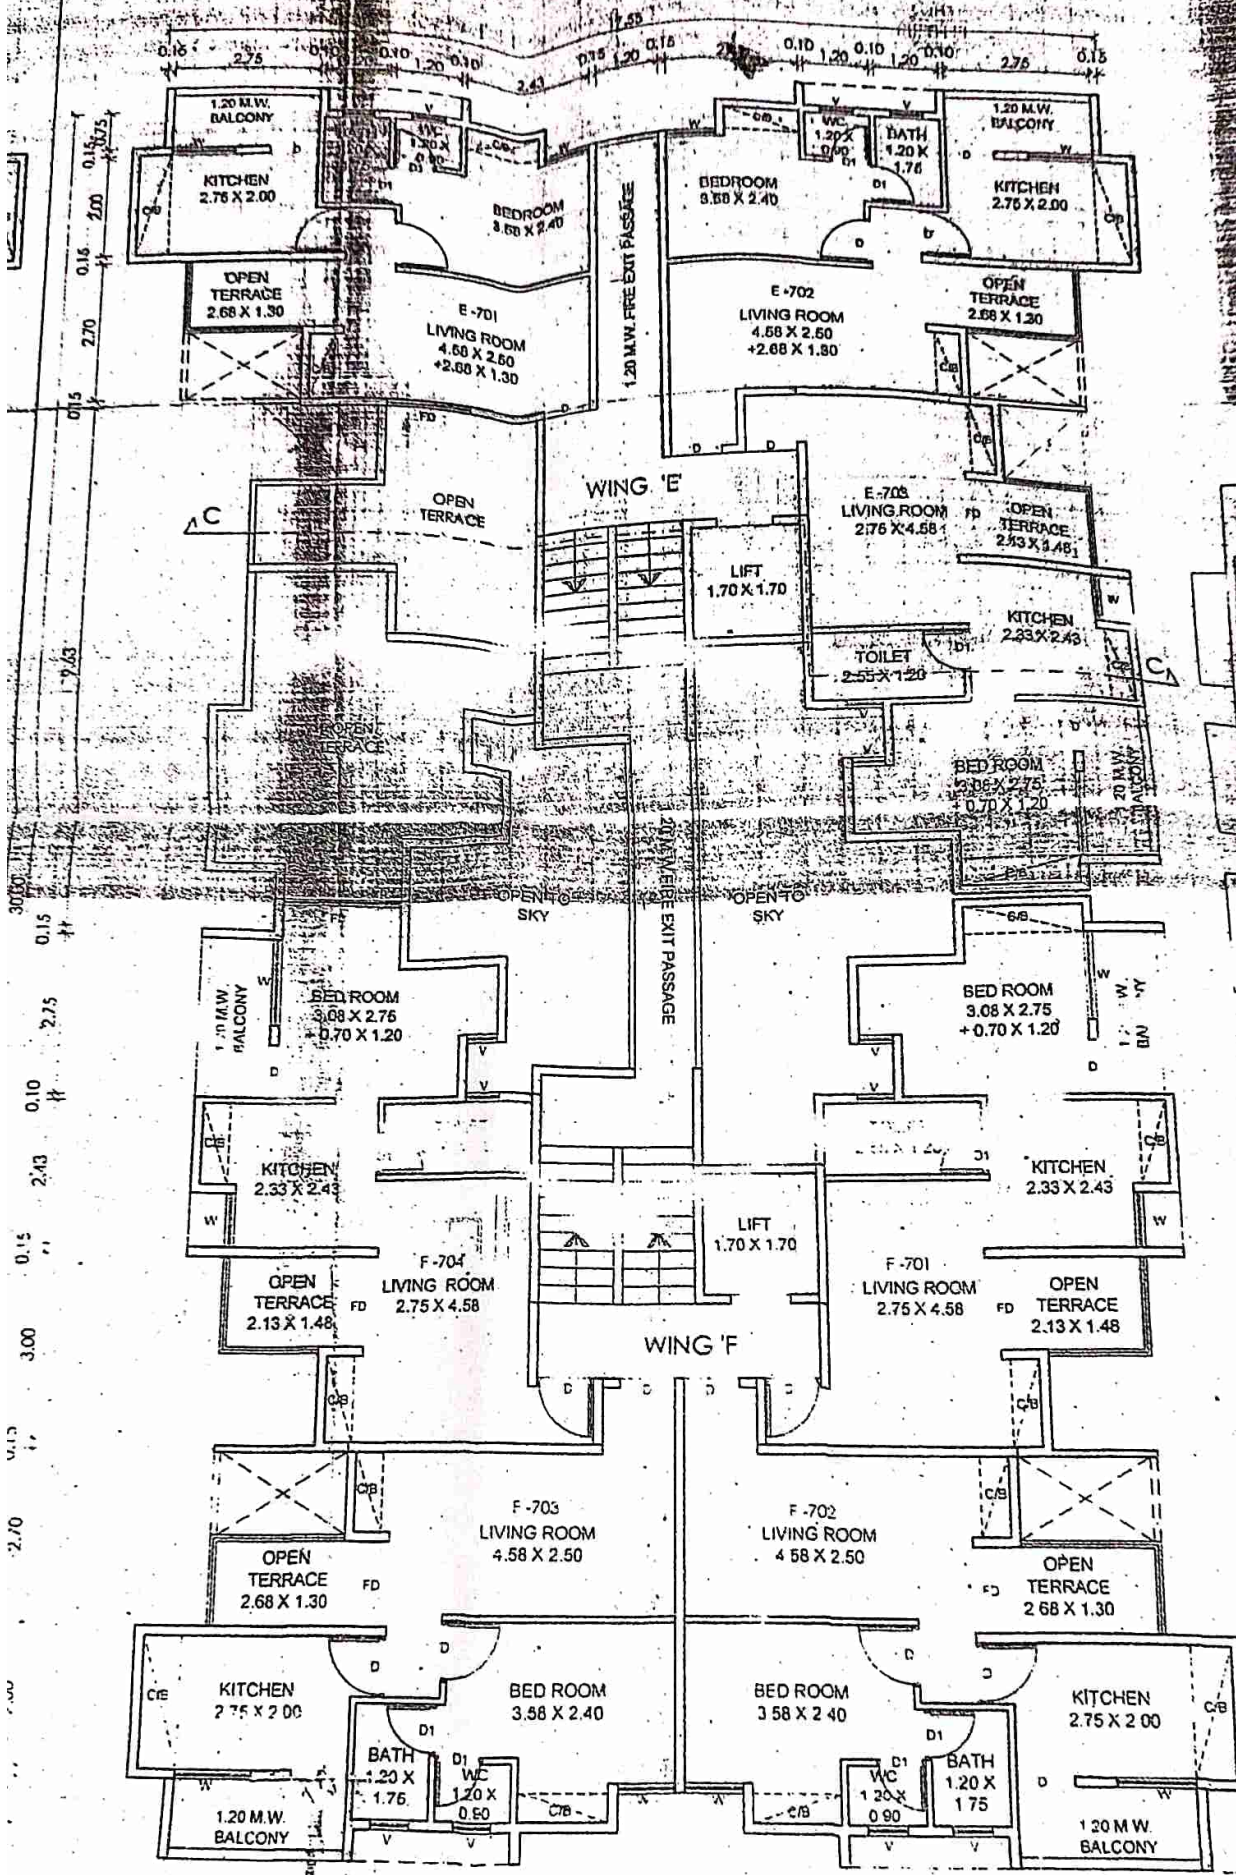


SEVENTH FLOOR PLAN

SCALE - 1 : 100



# SEVENTH FLOOR PLAN

SCALE - 1 : 100

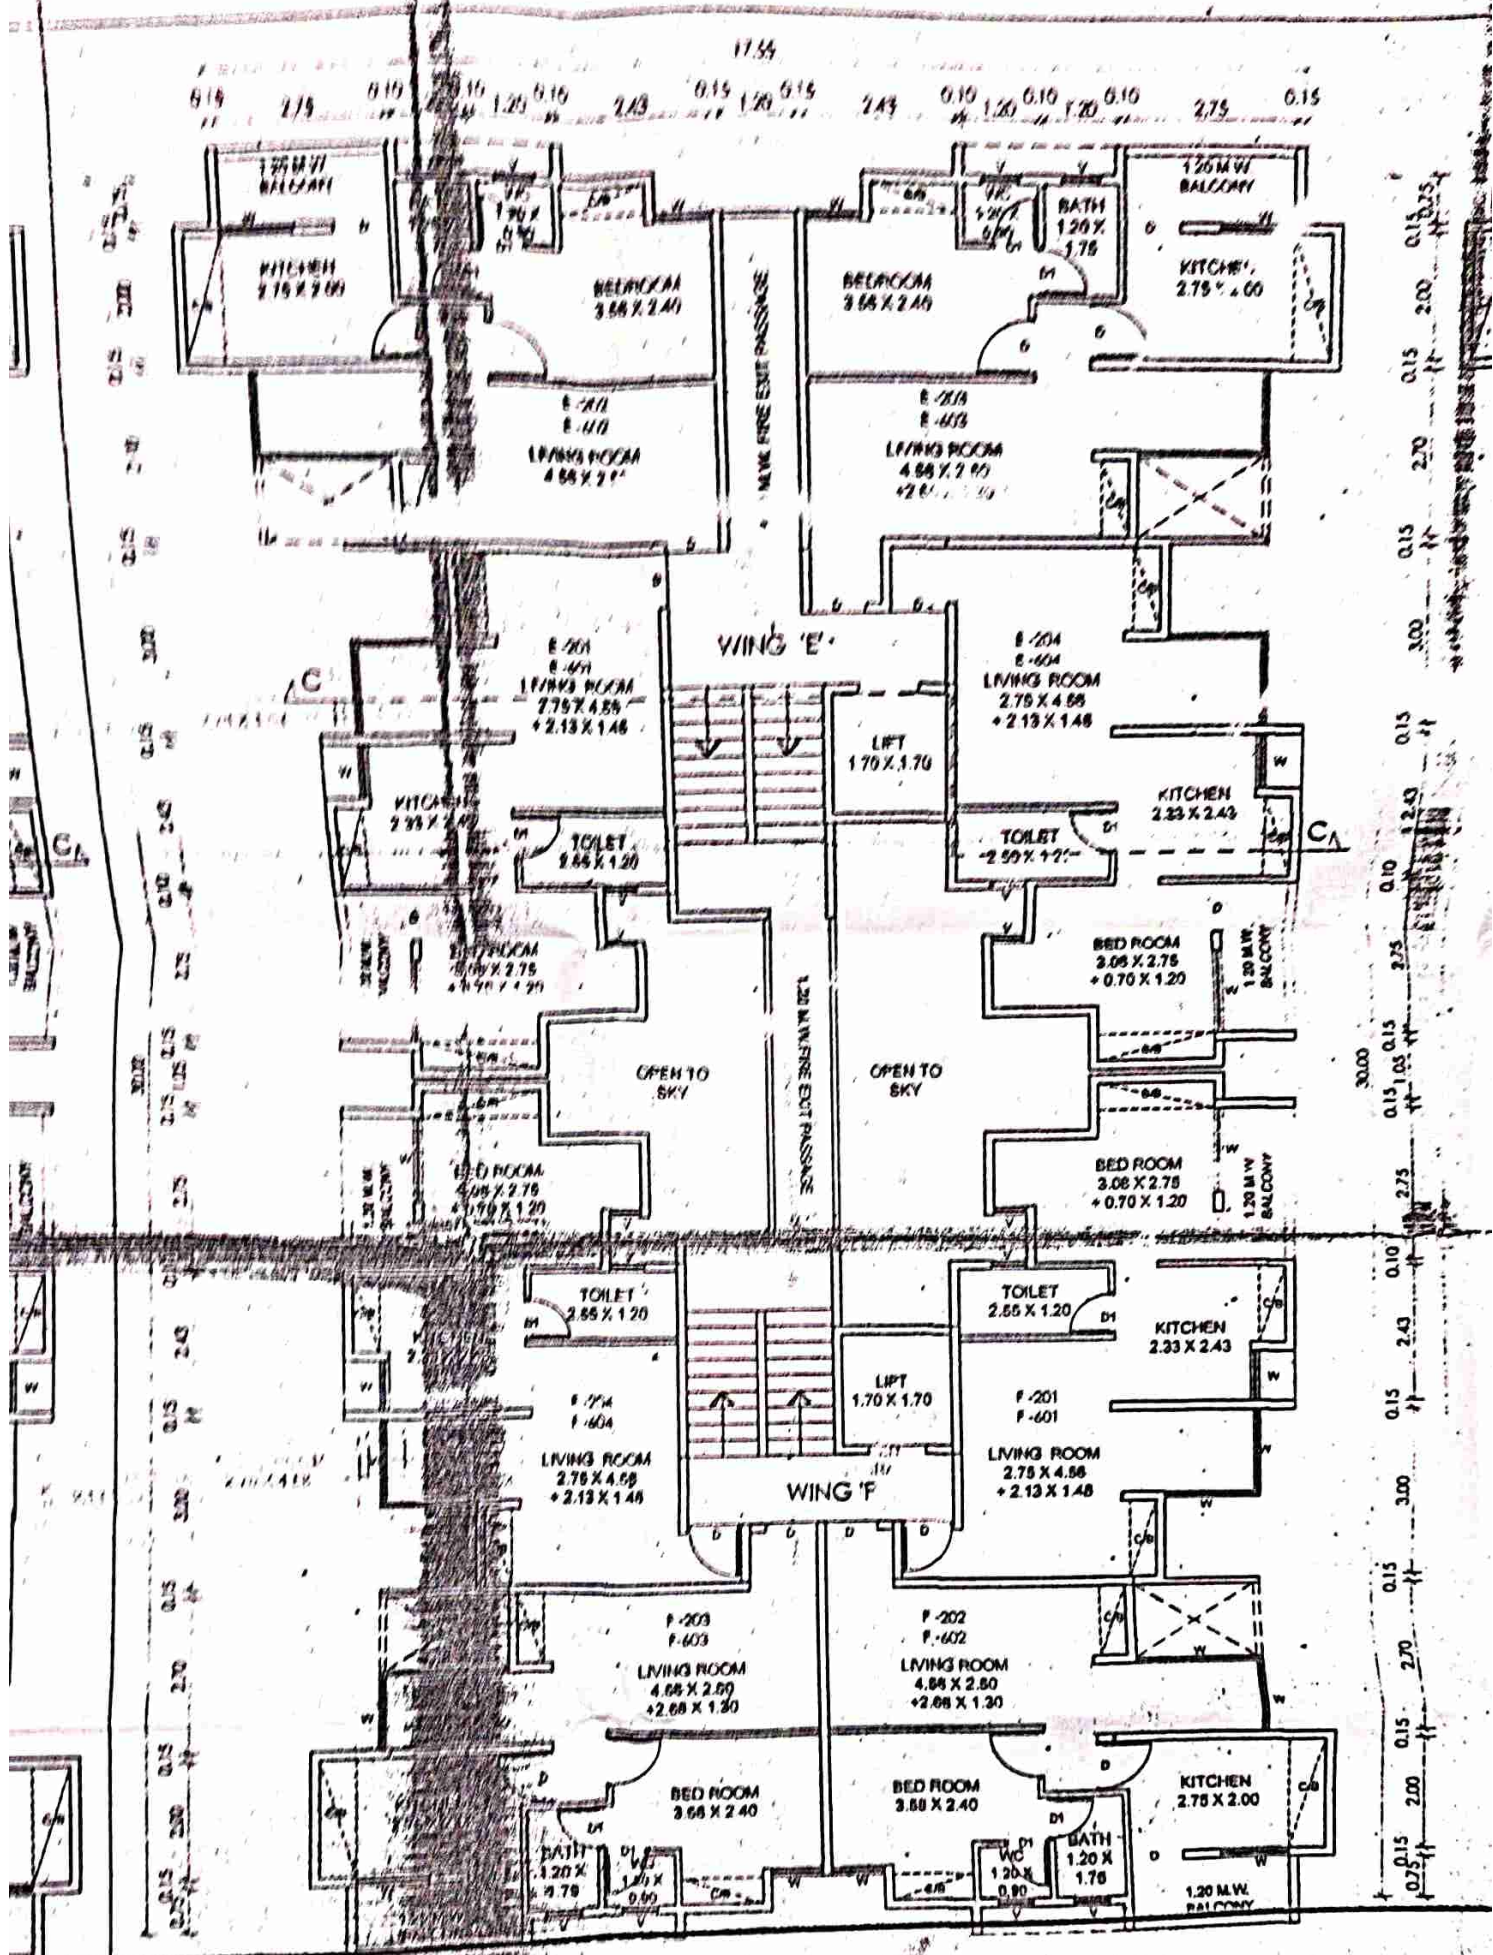

# TYPICAL SECOND & SIXTH FLOOR PLAN

SCALE - 1 : 100

BUILDING - 3



**ADD. LIVING AREA**

FOURTH FLOOR

AREA OF BLOCK

11297 X 128 X4 = 5845

21222 X 128 X4 = 11122

TOTAL = 20772

FOURTH FLOOR AREA = 277.27 + 8072



**ADD. LIVING AREA**

SECOND & SIXTH FLOOR

AREA OF BLOCK

1) 2166 X 120 X4 = 1057

2) 2122 X 128 X4 = 1109


TOTAL = 2166

SECOND & SIXTH FLOOR AREA = 277.27 + 29.66 = 306.93 SQM.





ARE  
SCALE

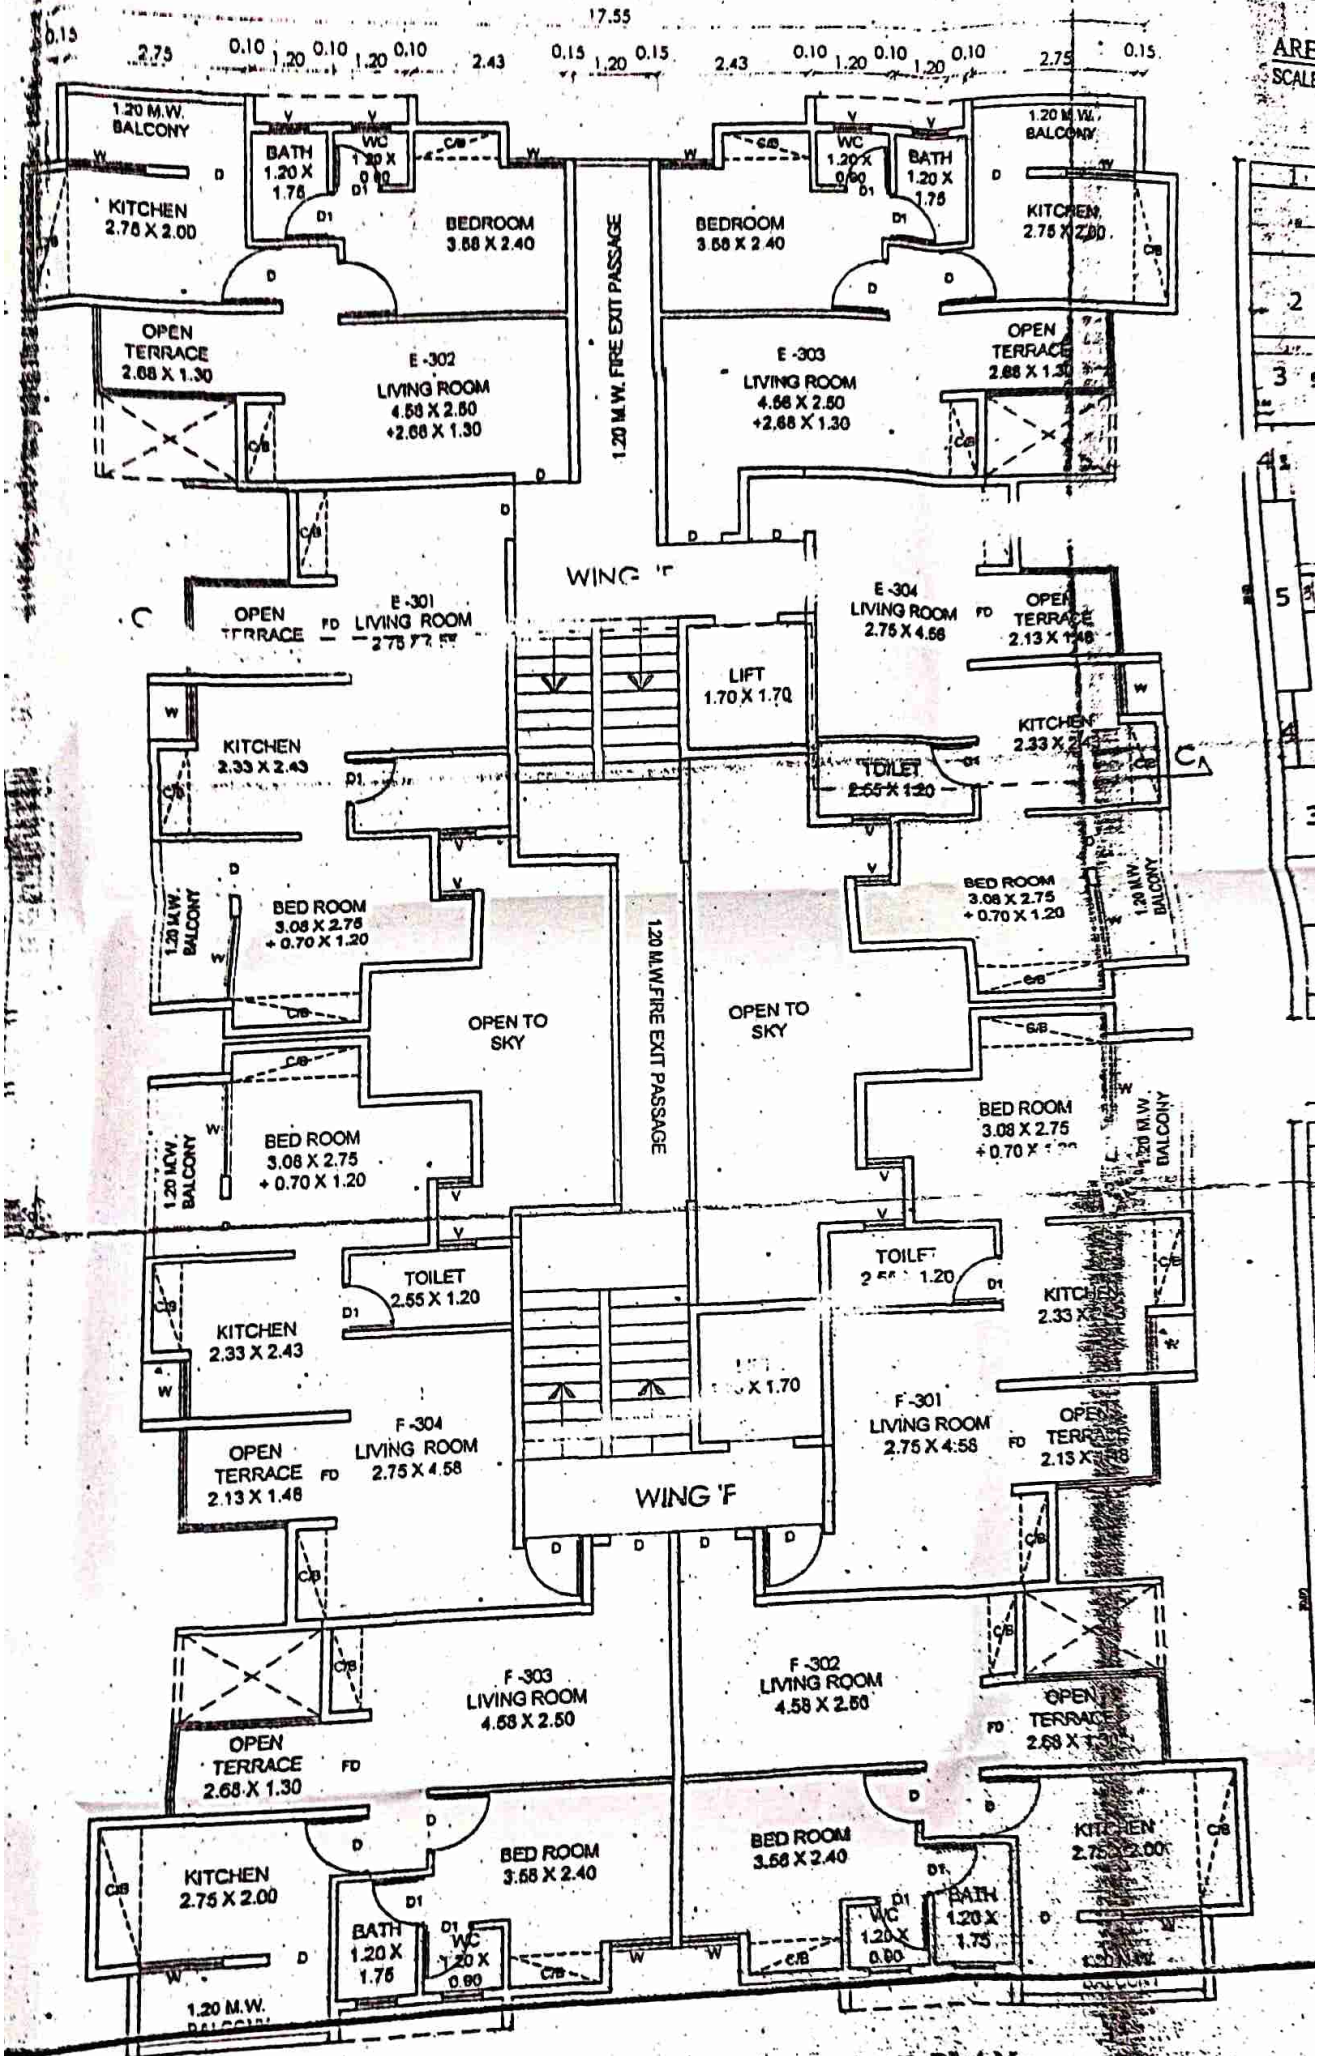

**THIRD FLOOR PLAN**  
SCALE - 1 : 100



APPROVAL STAMP

**APPROVED**  
 The Plans enclosed in  
 As per the conditions mentioned in  
 the accompanying commencement  
 Certificate No. dated  
 21/4/69 27/07 26/09/2013

Executive Engineer  
 TOWN PLANNING  
 Municipal Corporation  
 Nashik

**BALCONY AREA STATEMENT OF BLDG.**

FLOOR	NO. OF BALCONY	AREA
FIRST FLOOR	1	12.22
SECOND FLOOR	1	12.22
THIRD FLOOR	1	12.22
FOURTH FLOOR	1	12.22
FIFTH FLOOR	1	12.22
SIXTH FLOOR	1	12.22
SEVENTH FLOOR	1	12.22
EXCESS BALCONY	1	5.21
<b>TOTAL BALCONY AREA</b>		<b>84.34</b>

**BUILDING BUILT UP AREA SUMMARY**

FLOOR	BUILT UP AREA
FIRST FLOOR	1272.27
SECOND FLOOR	1206.64
THIRD FLOOR	1277.27
FOURTH FLOOR	1307.89
FIFTH FLOOR	1277.27
SIXTH FLOOR	1306.95
SEVENTH FLOOR	1243.99
EXCESS BALCONY	5.21
<b>ADD. BUILT AREA (1.70 X 1.70 X 2)</b>	<b>5.78</b>
<b>TOTAL BUILT UP AREA</b>	<b>2006.64</b>

**BUILDING "3" BUILT UP AREA = 2006.64 SQMT.**

**ADD. LIVING AREA**  
 FOURTH FLOOR  
 AREA OF FLOOR  
 1.275 X 1.87 X 1.15  
 1.275 X 1.87 X 1.15  
 TOTAL = 5.78


**ADD. LIVING AREA**  
 SECOND & SIXTH FLOOR  
 AREA OF FLOOR  
 1.275 X 1.87 X 1.15  
 1.275 X 1.87 X 1.15  
 TOTAL = 6.65

**SECOND & SIXTH FLOOR AREA**  
 1.275 X 1.87 X 1.15  
 1.275 X 1.87 X 1.15  
 TOTAL = 29.66 + 306.93 SQM.




**SECTION @ CC**  
 SCALE : 1:100


**AREA DIAGRAM & CALCULATION**  
 SCALE : 1:200

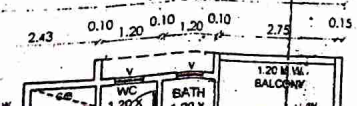




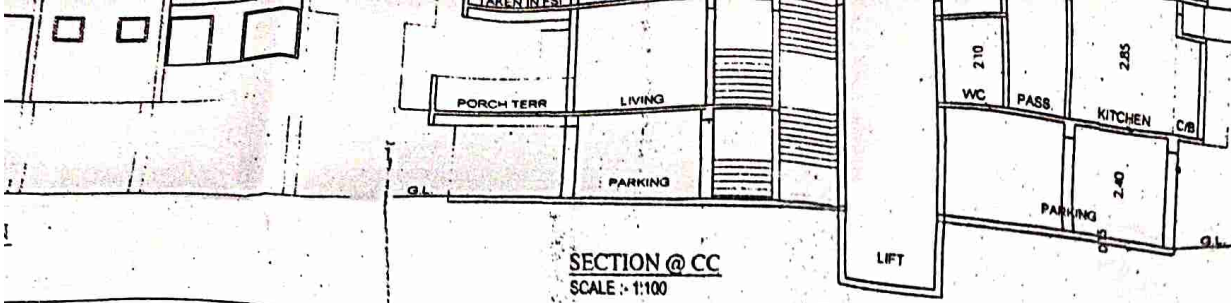


SECTION @ CC  
SCALE: 1:100

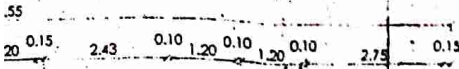

AREA DIAGRAM & CALCULATION  
SCALE: 1:200

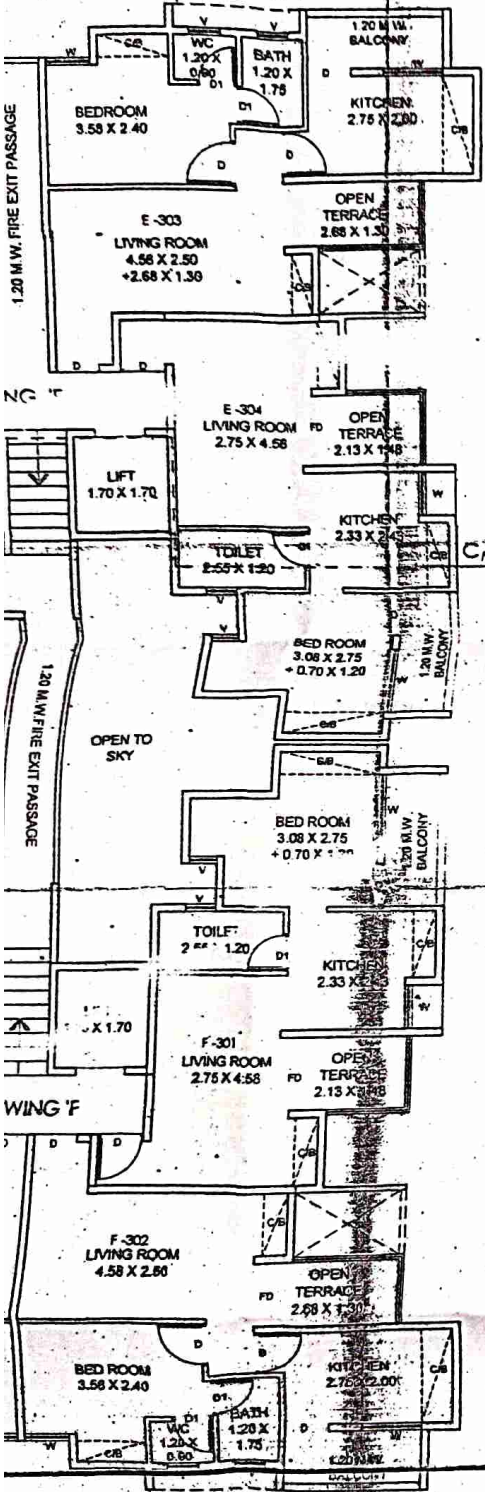


THIRD FLOOR PLAN  
SCALE: 1:100

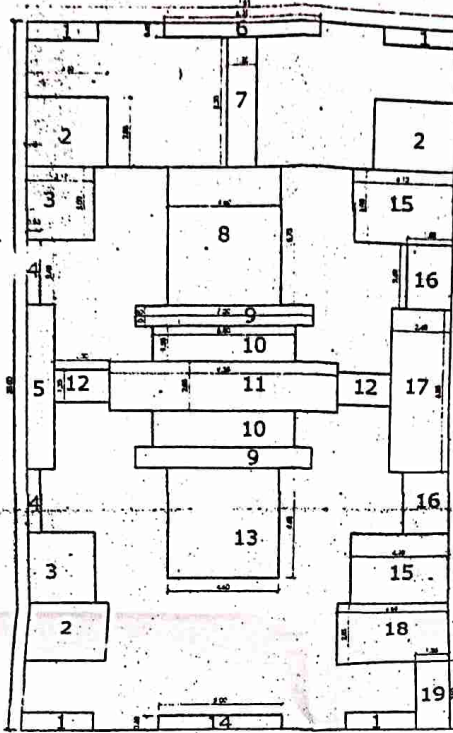

FOR 1ST TO 6TH FLOOR

- AREA OF BLOCK  
17.85 X 30.00 = 535.50 SQMT  
DEDUCTION
- 01) 2.90 X 0.75 X 4 = 8.70
  - 02) 3.30 X 2.85 X 3 = 28.22
  - 03) 2.75 X 3.00 X 2 = 16.50
  - 04) 0.53 X 2.68 X 2 = 2.84
  - 05) 1.13 X 6.85 X 1 = 7.74
  - 06) 6.35 X 0.60 X 1 = 3.81
  - 07) 1.20 X 5.30 X 1 = 6.36
  - 08) 4.60 X 5.73 X 1 = 26.36
  - 09) 7.20 X 0.85 X 1 = 6.12
  - 10) 5.80 X 1.50 X 2 = 17.40
  - 11) 9.35 X 2.05 X 1 = 19.17
  - 12) 2.30 X 1.35 X 2 = 6.21
  - 13) 4.60 X 4.68 X 1 = 21.53
  - 14) 5.00 X 0.60 X 1 = 3.00
  - 15) 4.12 X 3.00 X 2 = 24.72
  - 16) 1.88 X 2.68 X 2 = 10.07
  - 17) 2.48 X 6.85 X 1 = 16.99
  - 18) 4.65 X 2.85 X 1 = 13.25
  - 19) 1.35 X 3.05 X 1 = 4.12
- DEDUCTION = 245.23  
535.50 - 245.25 = 277.25 SQMT.  
B.U.P AREA ON TYPICAL FLOOR = 277.27 SQMT.  
EACH FLOOR AREA = 277.27 SQMT.

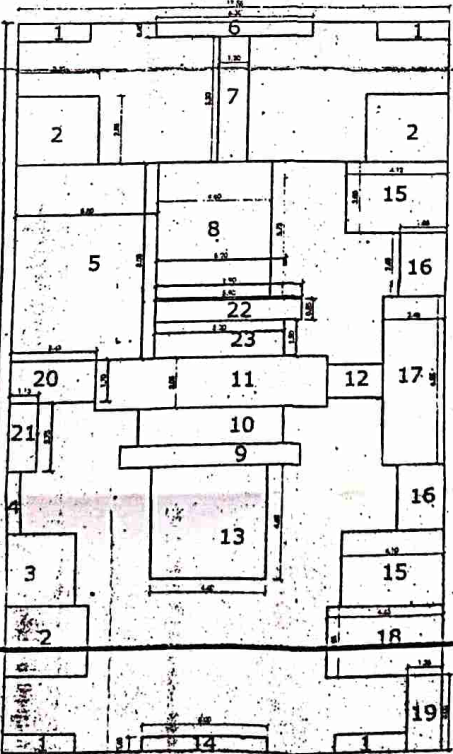

FOR SEVENTH FLOOR

- AREA OF BLOCK  
17.85 X 30.00 = 535.50 SQMT  
DEDUCTION
- 01) 2.90 X 0.75 X 4 = 8.70
  - 02) 3.30 X 2.85 X 3 = 28.22
  - 03) 2.75 X 3.00 X 1 = 8.25
  - 04) 0.53 X 2.68 X 1 = 1.42
  - 05) 5.80 X 8.08 X 1 = 46.86
  - 06) 6.35 X 0.60 X 1 = 3.81
  - 07) 1.20 X 5.30 X 1 = 6.36
  - 08) 4.60 X 5.73 X 1 = 26.36
  - 09) 7.20 X 0.85 X 1 = 6.12
  - 10) 5.80 X 1.50 X 1 = 8.70
  - 11) 9.35 X 2.05 X 1 = 19.17
  - 12) 2.30 X 1.35 X 1 = 3.11
  - 13) 4.60 X 4.68 X 1 = 21.53
  - 14) 5.00 X 0.60 X 1 = 3.00
  - 15) 4.12 X 3.00 X 2 = 24.72
  - 16) 1.88 X 2.68 X 2 = 10.07
  - 17) 2.48 X 6.85 X 1 = 16.99
  - 18) 4.65 X 2.85 X 1 = 13.25
  - 19) 1.35 X 3.05 X 1 = 4.12
  - 20) 3.43 X 1.70 X 1 = 5.83
  - 21) 1.13 X 2.75 X 1 = 3.11
  - 22) 5.80 X 0.85 X 1 = 5.01
  - 23) 5.20 X 1.50 X 1 = 7.80
- DEDUCTION = 282.61  
535.50 - 282.61 = 243.99 SQMT.  
B.U.P AREA ON SEVENTH FLOOR = 243.99 SQMT.



BUILDING 3

APPROVAL STAMP


SHEET NO. 1/1

**APPROVED**


The Plans amended in  
As per the conditions mentioned in  
the accompanying commencement  
Certificate No. G/1469/2707 dated 26/09/2013

*[Signature]*  
**Executive Engineer**  
**TOWN PLANNING**  
Nashik Municipal Corporation  
Nashik


X120-28.56	EXCESS AREA
X2120-28.56	0.84
X3120-28.56	0.84
X4120-28.56	0.84
X5120-28.56	0.84
X6120-28.56	0.84
X7120-28.56	0.84
X8120-28.56	0.84
X9120-28.56	0.84
X10120-28.56	0.84

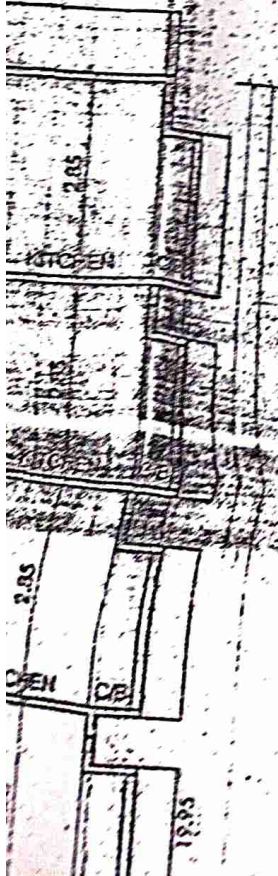




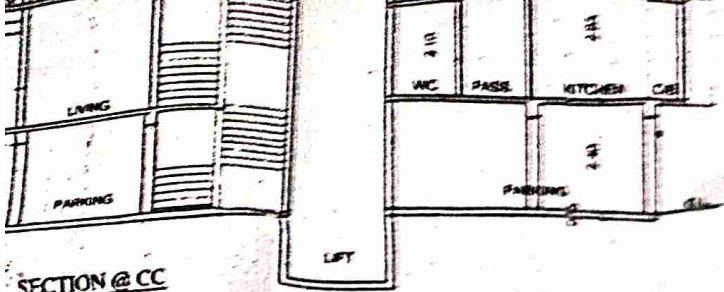

SECTION @ CC  
SCALE: 1:100

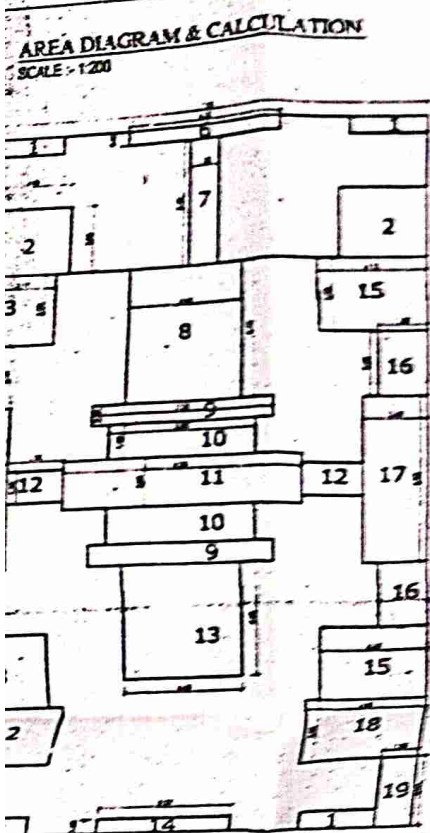

FOR 1ST TO 6TH FLOOR  
AREA OF BLOCK  
17.35 X 31.03 = 538.63 SQMT  
DEDUCTION  
01) 2.05 X 0.75 X 4 = 6.15  
02) 3.30 X 2.85 X 3 = 28.22  
03) 2.75 X 3.00 X 2 = 16.50  
04) 0.83 X 2.85 X 1 = 2.36  
05) 5.80 X 0.88 X 1 = 5.11  
06) 6.35 X 0.80 X 1 = 5.08  
07) 1.20 X 5.30 X 1 = 6.36  
08) 4.60 X 5.73 X 1 = 26.36  
09) 7.20 X 0.85 X 1 = 6.12  
10) 5.80 X 1.50 X 1 = 8.70  
11) 9.35 X 2.05 X 1 = 19.17  
12) 2.30 X 1.35 X 1 = 3.11  
13) 4.60 X 4.68 X 1 = 21.53  
14) 5.00 X 0.80 X 1 = 4.00  
15) 4.12 X 3.00 X 2 = 24.72  
16) 1.88 X 2.68 X 2 = 10.07  
17) 2.48 X 6.65 X 1 = 16.39  
18) 4.65 X 2.85 X 1 = 13.25  
19) 1.35 X 3.05 X 1 = 4.12  
DEDUCTION = 282.22  
828.50 - 282.22 = 546.28 SQMT.  
B.U.P AREA ON TYPICAL FLOOR  
= 546.28 SQMT.  
EACH FLOOR AREA = 546.28 SQMT.

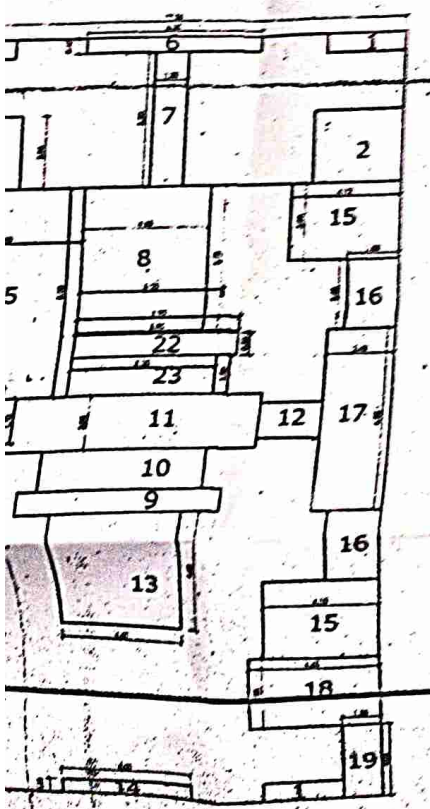

FOR SEVENTH FLOOR  
AREA OF BLOCK  
17.35 X 31.03 = 538.63 SQMT  
DEDUCTION  
01) 2.05 X 0.75 X 4 = 6.15  
02) 3.30 X 2.85 X 3 = 28.22  
03) 2.75 X 3.00 X 1 = 8.25  
04) 0.83 X 2.85 X 1 = 2.36  
05) 5.80 X 0.88 X 1 = 5.11  
06) 6.35 X 0.80 X 1 = 5.08  
07) 1.20 X 5.30 X 1 = 6.36  
08) 4.60 X 5.73 X 1 = 26.36  
09) 7.20 X 0.85 X 1 = 6.12  
10) 5.80 X 1.50 X 1 = 8.70  
11) 9.35 X 2.05 X 1 = 19.17  
12) 2.30 X 1.35 X 1 = 3.11  
13) 4.60 X 4.68 X 1 = 21.53  
14) 5.00 X 0.80 X 1 = 4.00  
15) 4.12 X 3.00 X 2 = 24.72  
16) 1.88 X 2.68 X 2 = 10.07  
17) 2.48 X 6.65 X 1 = 16.39  
18) 4.65 X 2.85 X 1 = 13.25  
19) 1.35 X 3.05 X 1 = 4.12  
20) 3.43 X 1.70 X 1 = 5.83  
21) 1.13 X 2.75 X 1 = 3.11  
22) 5.80 X 0.88 X 1 = 5.11  
23) 5.20 X 1.50 X 1 = 7.80  
DEDUCTION = 282.81  
828.50 - 282.81 = 545.69 SQMT.  
B.U.P AREA ON SEVENTH FLOOR  
= 545.69 SQMT.

PROPOSED PLOT AMALGAMATION AND RESIDENTIAL PROJECT IN PLOT NOS. 3-4-5-6 OF S. NO. 17/31-3 OF VILLAGE WASHIK FOR MR. TARUN LAGAP TERE M/S UNITED BUILDERS

ARCHITECT SIGN  
OWNERS SIGN  
REGISTRAR ENGINEER

GHUGGS DESIGNS  
17/31-3, WASHIK, TALUKA WASHIK, DISTRICT WASHIK