

TRUE COPY




**M. Ramiah M. S. Shetty**  
 Special & Joint Municipal Engineer  
 MUNICIPAL CONCILIAR  
 VASAI, Dist. Thane.

APPROVED  
 Additional Collector, Thane  
 for registration of the plan  
 Dated: 16-11-1980

Additional Collector  
 Thane



LOCATION PLAN

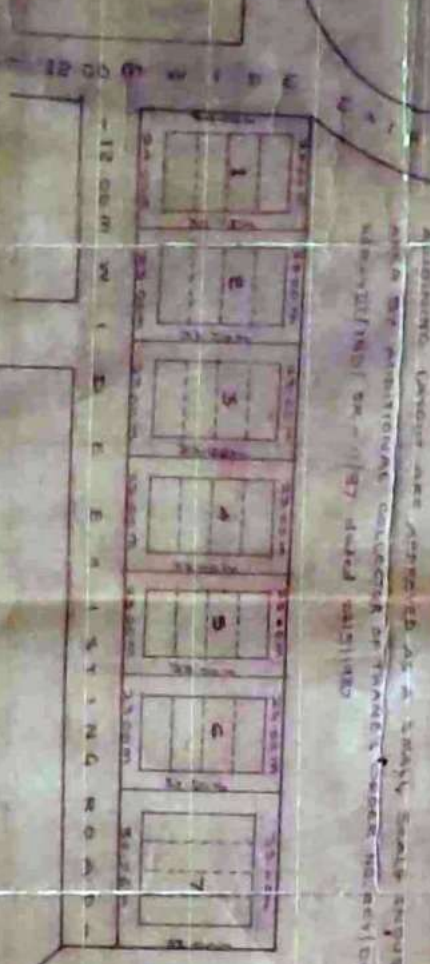

SITE PLAN

APPROVED AS A TOWNY SCALE REQUIREMENTS  
 AND THE MUNICIPAL CONCILIAR OF THANE'S ORDER NO. 1/1980 DATED 16/11/1980

**PILOT AREA STATEMENT**

Plot No.	Area (sq. m)	Area (sq. ft)	Area (sq. yd)
1	772.8	8343.96	950.40
2	772.8	8343.96	950.40
3	772.8	8343.96	950.40
4	772.8	8343.96	950.40
5	772.8	8343.96	950.40
6	772.8	8343.96	950.40
7	772.8	8343.96	950.40

**BUILT UP AREA STATEMENT**

P NO	Area of the Plot (sq. m)	Area of the Building (sq. m)	Area of the Road (sq. m)	Area of the Open Space (sq. m)
1	772.8	150.00	15.00	607.80
2	772.8	150.00	15.00	607.80
3	772.8	150.00	15.00	607.80
4	772.8	150.00	15.00	607.80
5	772.8	150.00	15.00	607.80
6	772.8	150.00	15.00	607.80
7	772.8	150.00	15.00	607.80

**HOLDING AREA STATEMENT**

AREA OF THE PLOT - 1440.00 sq. m. - 1600.00 sq. ft. - 1800.00 sq. yd.

**NOTES**

- Area of the holding bounded by Municipal Engineer's Department's Survey No. 1/1980.
- How detailed plans of the plot are to be prepared.
- Area of the plot is 1440.00 sq. m. (1600.00 sq. ft. & 1800.00 sq. yd.).
- Area of the building is 150.00 sq. m. (1650.00 sq. ft. & 187.50 sq. yd.).
- Area of the road is 15.00 sq. m. (165.00 sq. ft. & 18.75 sq. yd.).
- Area of the open space is 607.80 sq. m. (6585.00 sq. ft. & 750.00 sq. yd.).

PROPOSED PLOT LAYOUT PLAN OF S.NO. 441 H.NO.3 VIL:MAHIM.

**PROJECT** : PROPOSED PLOT LAYOUT PLAN OF S.NO. 441 H.NO.3 VIL:MAHIM.

**CLIENT** : BILCO VASAI

**TITLE** : PROPOSED PLOT LAYOUT PLAN

**DRG NO** : 1

**JOB NO** : 1

**BIDCO ENGINEERING DIVISION**

**DESIGNED BY** : D. W. A. N. I. O. W. E. R.

**CHECKED BY** : D. W. A. N. I. O. W. E. R.

**VASAI (RMW) TA. VASAI DIST. THANE**

RODD

ELEVATION

SECTION B-H

5.000

5.000

ROOF CALCULATION

Area	Vol. of air	sq. ft.	cu. ft.
1	38.00	0.00	189.00
2	40.00	0.00	190.00

LINE DRAWING SCALE 1/8" = 1'-0"

ROOF CALCULATION

Area	Vol. of air	sq. ft.	cu. ft.
1	38.00	0.00	189.00
2	40.00	0.00	190.00



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GENERAL NOTES

1. ALL WORK SHALL BE IN ACCORDANCE WITH THE SPECIFICATIONS FOR THE PROJECT.
2. THE CONTRACTOR SHALL BE RESPONSIBLE FOR OBTAINING ALL NECESSARY PERMITS AND APPROVALS.
3. ALL MATERIALS SHALL BE OF THE HIGHEST QUALITY AND SHALL BE SUBMITTED FOR APPROVAL PRIOR TO INSTALLATION.
4. THE WORK SHALL BE COMPLETED WITHIN THE SPECIFIED TIME FRAME.
5. ALL WORK SHALL BE SUBJECT TO INSPECTION AND APPROVAL BY THE ARCHITECT.




**CALIFORNIA**  
 REGISTERED ARCHITECT  
 No. 12345  
 State of California

DATE: 10/15/2011  
 SCALE: 1/8" = 1'-0"


ARCHITECTS AND ENGINEERS <b>J.P. METTA AND ASSOCIATES</b> 101 S. F STREET, SUITE 100 LOS ANGELES, CA 90012	CLIENT MAY BAKER AND ASSOCIATES	JOB NEW 2000 BLDG	LOCATION 101 S. F STREET, SUITE 100 LOS ANGELES, CA 90012	TITLE SECTION B-H	DATE 10/15/2011	SCALE 1/8" = 1'-0"	SHEET NO. 100 OF 100
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THIS DOCUMENT IS NOT VALID FOR ANY OTHER PROJECT WITHOUT THE WRITTEN PERMISSION OF THE ARCHITECT.

ROAD

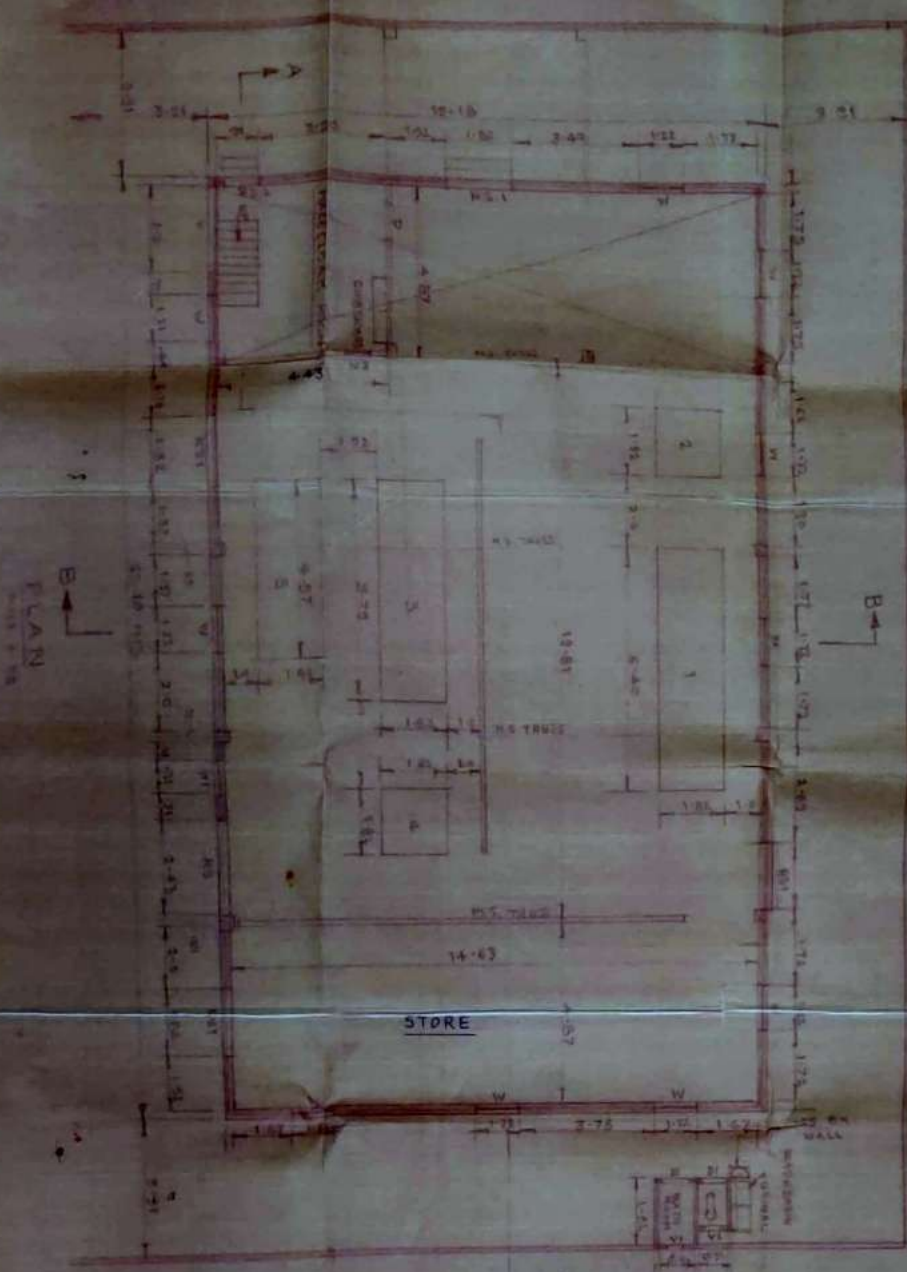


SECT. A-A ELEVATION

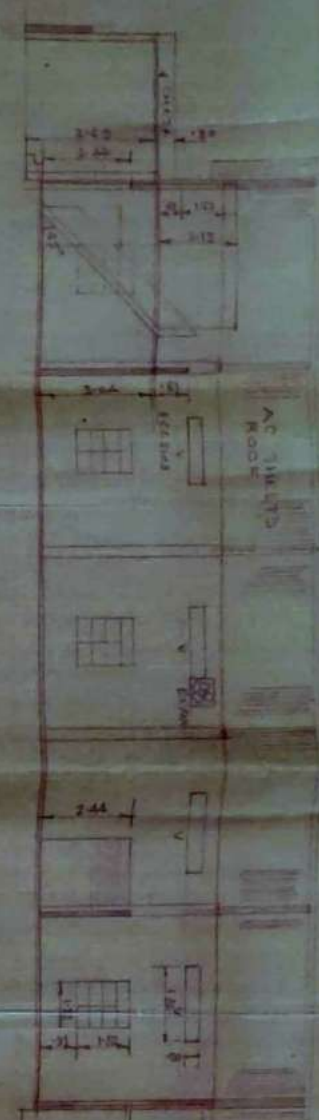

SECT. B-B



DETAIL OF LEFT PLUMB

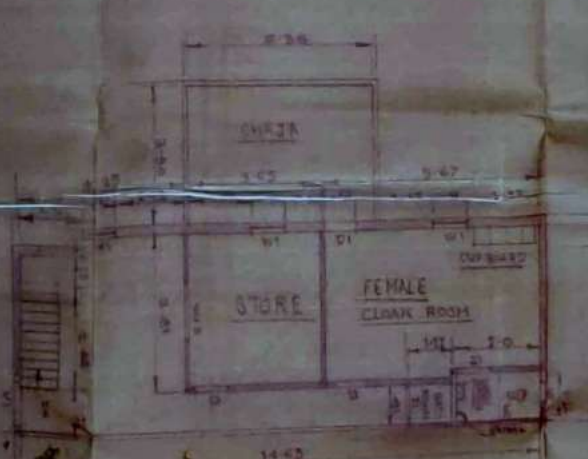

LOCATION PLAN

SCHEMATIC OF MATERIALS

NO.	DESCRIPTION	QUANTITY	UNIT
1	BRICKS	1000	NO.
2	CEMENT	50	NO.
3	IRON	10	NO.
4	WOOD	100	NO.
5	GLASS	10	NO.

NO.	DESCRIPTION	QUANTITY	UNIT
6	ROOFING	100	NO.
7	PAINT	10	NO.
8	WATER	100	NO.
9	ELECTRIC	10	NO.
10	PLASTER	100	NO.

NO.	DESCRIPTION	QUANTITY	UNIT
11	CONCRETE	100	NO.
12	STEEL	10	NO.
13	GLASS	10	NO.
14	WOOD	100	NO.
15	PAINT	10	NO.

APPROVED AND AUTHORIZED  
 FOR THE ARCHITECT  
 [Signature]

DATE: 1955

BY: [Signature]